
HARRIS COUNTY ENGINEERING DEPARTMENT

ON-STREET BIKEWAY SIGNING AND PAVEMENT MARKINGS POLK STREET FROM EMANCIPATION AVE TO CULLEN BLVD

UPIN: 19101MF0ZG01

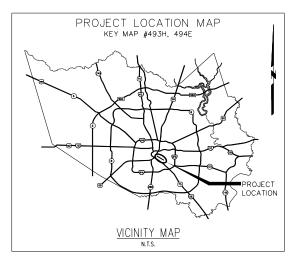

RODNEY ELLIS PRECINCT 1

PRECINCT 2

LINA HIDALGO

STEVE RADACK

COMMISSIONER PRECINCT 3

R. JACK CAGLE COMMISSIONER


PRECINCT 4

MICHAEL POST, CPA

ADRIAN GARCIA

COMMISSIONER

JOHN R. BLOUNT, P.E.

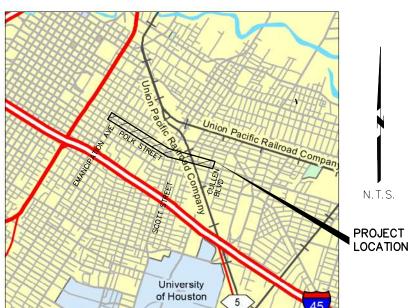



PRECINCT 1 Harris County, Texas



APPROVED: City of Houston Houston Public Works Director





801 Congress Avenue, Suite 325, Houston, TX 77002 TEL (713) 270-8145/FAX (281) 809-0807 TBPE Registration No. F-3158

100 Cover Sheet 101 Index of Sheets

102 Project Layout Polk Street

103 General Notes

104 Review Sheet

Quantity Summary Sheets

105 Basis of Estimate

106 Quantity Summary - Signing, Pvmt Marking, & Sidewalk

107 Quantity Summary - Pavement Repair

08 Summary of Traffic Signal Quantities

Traffic Control Plan

109 One Lane, Two-Way Operation

Signing and Pavement Marking Plans

200 Signing and Pavement Marking Plan Sheet 1 of 8

201 Signing and Pavement Marking Plan Sheet 2 of 8

202 Signing and Pavement Marking Plan Sheet 3 of 8

203 Signing and Pavement Marking Plan Sheet 4 of 8 204 Signing and Pavement Marking Plan Sheet 5 of 8

205 Signing and Pavement Marking Plan Sheet 6 of 8

206 Signing and Pavement Marking Plan Sheet 7 of 8

207 Signing and Pavement Marking Plan Sheet 8 of 8

Signing and Pavement Marking Details

208 Signing and Pavement Marking Legend

209 Houston Bikeways Sign Details

210 Standard Small Sign Details

211 Signing and Pavement Marking Detail Sheet 1 of 4

212 Signing and Pavement Marking Detail Sheet 2 of 4

213 Signing and Pavement Marking Detail Sheet 3 of 4

214 Signing and Pavement Marking Detail Sheet 4 of 4

215 Sidewalk Details

216 Curb Ramp Details

217 Detectable Warning Details

218 Directional Tactile Surface-Applied Detail

219 METRO Bus Stop Detail Sheet 1 of 2

220 METRO Bus Stop Detail Sheet 2 of 2

221 Project Sign Details

222 Special Sign Details Sheet 1 of 2

223 Special Sign Details Sheet 2 of 2

Paving Sheets

INDEX OF SHEETS

Pavement Removals and Repairs Plan Sheet 1 of 8

01 Pavement Removals and Repairs Plan Sheet 2 of 8

302 Pavement Removals and Repairs Plan Sheet 3 of 8

303 Pavement Removals and Repairs Plan Sheet 4 of 8

304 Pavement Removals and Repairs Plan Sheet 5 of 8

305 Pavement Removals and Repairs Plan Sheet 6 of 8

306 Pavement Removals and Repairs Plan Sheet 7 of 8

307 Pavement Removals and Repairs Plan Sheet 8 of 8

308 Polk at St. Charles EB Bus Stop Paving Detail

309 Polk at St. CharlesRemoval & Paving

310 Polk at St. Charles WB Bus Stop Paving Detail

311 Polk at Live Oak Removal

312 Polk at Live Oak Paving

313 Polk at Nagle Removal 314 Polk at Nagle Paving

315 Polk at Delano Removal & Paving

316 Polk at Delano WB Bus Stop Paving Detail

317 Polk at Paige Removal & Pavina

318 Polk at Ennis Removal

319 Polk at Ennis Paving

320 Polk at Palmer Removal

321 Polk at Palmer Paving

322 Polk at Palmer EB Bus Stop Paving Detail

323 Polk at Palmer WB Bus Stop Paving Detail

324 Polk at Velasco Removal

325 Polk at Velasco Paving

326 Polk at Roberts Removal

327 Polk at Roberts Paving

328 Polk at Scott EB Bus Stop Paving Detail

329 Polk at Scott WB Bus Stop Paving Detail

330 Polk at Scott Paving

331 Polk at Milby Removal

332 Polk at Milby Paving

333 Polk at Cullen EB Bus Stop Paving Detail

334 Polk at Cullen WB Bus Stop Paving Detail

335 Bus Platform Section A-A

336 Bus Platform Section B-B

337 Bus Platform Section C-C

338 Bus Platform Section D-D

339 Bus Platform Section E-E

340 Bus Platform Section F-F

Signal Design Sheets

- 400 Polk St at Scott St Existing Traffic Signal Layout
- 401 Polk St at Scott St Proposed Traffic Signal Layout
- 402 Polk St at Scott St Proposed Signal Elevation Sheet 1 of 2 403 Polk St at Scott St Proposed Signal Elevation Sheet 2 of 2
- 404 Loop Detector Installation Details
- 405 COH Signal General Notes Sheet 1 of 2
- 406 COH Signal General Notes Sheet 2 of 2



NO. REVISIONS DATE NAME



7EL (713) 270-8145/FAX (281) 809-0807 TBPE Registration No. F-3158




HARRIS COUNTY ENGINEERING DEPARTMENT

PROJECT TITL	E:
	LK STREET ON-STREET BIKEWAY
DRAWN BY:	SHEET DESCRIPTION:
GB	INDEX OF SHEETS
CK'D BY:	
JL	
SCALE:	
NONE	
DATE:	APPROVED BY:
4/12/2019	

SHEET NO: 101

1000'

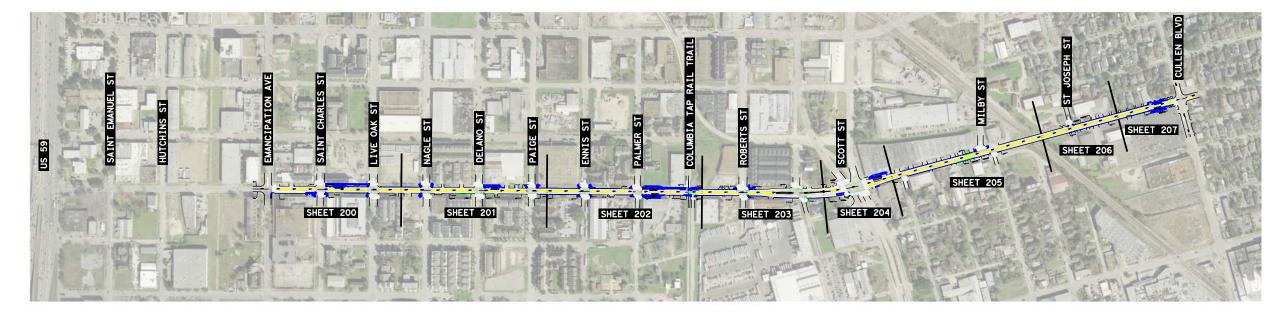



NO.	REVISIONS	DATE	NAME



801 Congress Avenue, Suite 325, Houston, TX 77002 TEL (713) 270-8145/FAX (281) 809-0807 TBPE Registration No. F-3158



ROJECT TITL	E:	
	LK STREET ON-STREET BIKE	WAY
RAWN BY:	SHEET DESCRIPTION:	
GB	PROJECT LAYOU	ΙT
K'D BY:		
JL		
CALE:		
NONE		
ATE:	APPROVED BY:	
4/12/2019		
•		SHEET NO:
		102

/2019

GENERAL

- THE CONTRACTOR SHALL FIELD VERIFY EXISTING CONDITIONS BEFORE BEGINNING CONSTRUCTION.
- THE CONTRACTOR IS RESPONSIBLE FOR PROVIDING SECURITY TO PROTECT THE PROJECT SITE. CONTRACTOR PROPERTY. EQUIPMENT. AND WORK.
- THE CONTRACTOR IS RESPONSIBLE FOR CLEANING STREETS OF CONSTRUCTION DIRT AND DEBRIS AT CLOSE OF EACH WORK DAY.
- 4. THE CONDITION OF THE ROAD AND/OR RIGHT-OF-WAY, UPON COMPLETION OF THE JOB SHALL BE AS GOOD AS OR BETTER THAN PRIOR TO STARTING WORK.
- PRIOR TO CONSTRUCTION, THE CONTRACTOR, ALONG WITH CONCURRENCE FROM THE FIELD ENGINEER, SHALL DETERMINE HIS/HER LAY-DOWN AND/OR STAGING AREA LOCATIONS.
- THE CONTRACTOR SHALL NOTIFY ALL PROPERTY OWNERS A MINIMUM OF 24 HOURS PRIOR TO BLOCKING DRIVEWAYS OR ENTERING UTILITY EASEMENTS.
- TRAFFIC INGRESS AND EGRESS FOR DRIVEWAYS AND PEDESTRIAN ACCESS FACILITIES SHALL BE MAINTAINED THROUGHOUT CONSTRUCTION.
- . THE CONTRACTOR SHALL REMOVE ANY FENCES, POSTS, MAILBOXES, PLANTERS, PERMANENT TRASH CONTAINERS, CULVERTS, ETC. OR SECTIONS THEREOF, THAT ENCROACH WITHIN THE COUNTY'S RIGHT-OF-WAY. NOTE: PRIOR TO CONSTRUCTION, THE PROPERTY OWNER WAS PAID TO RELOCATE OR REPLACE THESE ITEMS OUTSIDE OF THE COUNTY'S RIGHT-OF-WAY.

IF THE OWNER HAS FAILED TO DO SO, THE CONTRACTOR WILL REPLACE THEM WITH THE MINIMUM LEVEL OF QUALITY NEEDED TO SECURE THE PROPERTY AND/OR MAINTAIN MAIL DELIVERY. IN THAT CASE, PAYMENT FOR THESE INSTALLATIONS WILL BE INCLUDED AS EXTRA WORK ITEMS OR AS OVERRUNS TO EXISTING PAY ITEMS.

ANY DAMAGE CAUSED BY THE CONTRACTOR TO SUCH ITEMS LOCATED OUTSIDE OF THE COUNTY'S RIGHT-OF-WAY, SHALL BE REPLACED WITH LIKE-KIND OR BETTER AT THE CONTRACTOR'S EXPENSE.

ALSO, IF THESE ITEMS ARE LOCATED WITHIN THE PROJECT RIGHT-OF-WAY AND ARE DESIGNATED TO REMAIN, ANY DAMAGE CAUSED BY THE CONTRACTOR TO SUCH ITEMS, SHALL BE REPLACED WITH LIKE-KIND OR BETTER AT THE CONTRACTOR'S EXPENSE.

TREES, BUSHES, SHRUBBERY AND OTHER DAMAGED PLANTINGS DESIGNATED TO REMAIN SHALL BE REPLACED WITHIN 72 HOURS OF REMOVAL AND ARE TO BE THOROUGHLY WATERED-IN. NO SEPARATE PAY.

- PAVED SURFACES, PAVEMENT MARKERS AND MARKINGS SHALL BE PROTECTED FROM DAMAGE BY TRACKED EQUIPMENT.
- 10. IRON RODS DISTURBED DURING CONSTRUCTION ARE TO BE REPLACED BY A REGISTERED PROFESSIONAL LAND SURVEYOR FOR THE ORIGINAL PROPERTY OWNER AT NO SEPARATE PAY.
- 11. CONSTRUCTION STAKING WILL BE PROVIDED BY THE CONTRACTOR. TWO COPIES OF STAKING NOTES TO BE PROVIDED TO THE ENGINEER PRIOR TO CONSTRUCTION.
- 12. THE COUNTY OR THE COUNTY'S SURVEYOR SHALL PROVIDE A BENCHMARK OR TEMPORARY BENCHMARK AND SURVEY CONTROLS.
- 13. THE CONTRACTOR SHALL MAINTAIN UPDATED RED-LINED RECORD DRAWINGS ON SITE FOR
- 14. MOWING, MAINTENANCE, AND CLEAN-UP OF THE PROJECT SHALL MEET THE REQUIREMENT OF SPECIFICATION ITEM 560 (NO SEPARATE PAY). MOWING, MAINTENANCE, AND CLEAN-UP IS REQUIRED FOR THE PROJECT LIMITS AND DURATION, REGARDLESS OF THE CONTRACTOR'S SCOPE OF ACTIVITIES WITHIN THE PROJECT LIMITS.
- 15. THE REMOVAL OF ANY ABANDONED UTILITIES REQUIRED TO COMPLETE THE WORK SHALL BE INCIDENTAL AND NO SEPARATE PAYMENT SHALL BE MADE.
- 16. IT IS THE CONTRACTOR'S RESPONSIBILITY TO STOCKPILE NECESSARY MATERIAL ON-SITE OR AT A SECURED OFF-SITE LOCATION AT NO ADDITIONAL EXPENSE TO HARRIS COUNTY. ANY SUITABLE EXCAVATED MATERIAL ON THE PROJECT WHICH IS AVAILABLE AT THE TIME OF NEED; WHETHER FROM STORM SEWER, ROADWAY, AND/OR CHANNEL EXCAVATION, SHALL BE USED BEFORE BORROW IS BROUGHT ON-SITE.
- 17. MANHOLES, JUNCTION BOXES, INLETS, AND RISERS ARE TO BE PRE-CAST OR CAST IN PLACE.

PROJECT-SPECIFIC NOTES

- CONTRACTOR SHALL LOCATE EXISTING EDGE OF PAVEMENT & SIDEWALK AND REMOVE ANY DIRT, DEBRIS, VEGETATION, OR OTHER IMPEDIMENTS TO PROVIDE CLEAR SURFACE AND 8' VERTICAL CLEARANCE. TO BE PAID AS CLEARING AND GRUBBING.
- EXISTING SIGNAGE TO REMAIN UNLESS NOTED.
- NEW CROSSWALKS AND STOP BARS, AS SHOWN ON SIGNAGE AND PAVEMENT MARKING SHEETS, TO BE CONSTRUCTED ON ALL SIDE STREETS. STOP SIGNS SHALL BE RELOCATED TO ALIGN WITH NEW STOP BARS.
- 4. TWO WEEKS PRIOR TO PROJECT SITE MOBILIZATION, COORDINATION WITH METRO IS REQUIRED FOR REMOVAL OF EXISTING BUS STOPS AND ANY TRANSIT AMENITIES FOR IMPACTS TO BUS OPERATIONS DURING CONSTRUCTION. CONTRACTOR SHALL NOTIFY METRO AT LEAST 72 HOURS PRIOR TO CONSTRUCTION OF STANDARD BUS PAID AND LANDINGS PER COH PWE INFRASTRUCTURE DESIGN MANUAL, 10-60. CONTRACTOR SHALL ALLOW METRO TO INSPECT THE SLAB FORM FOUNDATION FOR THE BUS STOP PRIOR TO PLACEMENT OF CONCRETE AND NOTIFY METRO AT LEAST 72 HOURS IN ADVANCE. CONTRACTOR SHALL COORDINATE WITH METRO, AS NECESSARY, FOR INSTALLATION OF VARIOUS AMENITIES AT FINISHED BUS STOP LOCATIONS. CONTACT FACILITIES MAINTENANCE #T DECEMBER OF THE PROPERTY OF THE PRO
- 5. CONTRACTOR SHALL INSTALL/REFRESH ALL PAVEMENT MARKINGS SHOWN ON PLANS.
- CONTRACTOR SHALL INSTALL GREEN PAVEMENT MARKINGS BEFORE WHITE PAVEMENT MARKINGS WHERE ABUTTING

VRAFFIC SIGNAL

- LL ITEMS RELATING TO THE CONSTRUCTION OF TRAFFIC SIGNAL INSTALLATIONS, EXCEPT OR
 PUNCHLIST ITEMS, SHALL BE COMPLETED PRIOR TO THE ACTIVATION OF THE SIGNAL SYSTEM(S)
 UNLISS OTHERWISE REQUIRED BY THE CONTRACT.
- ACTOR SHALL MEET WITH THE HARRIS COUNTY TRAFFIC SIGNAL MAINTENAN NEPECTOR, HEREAFTER REFERRED TO AS THE TRAFFIC INSPECTOR, ONE-WET SIRE ACTIVATION OF ANY NEW TRAFFIC SIGNALS. THE CONTRACTOR SHALL THE DESIRE OBTAIN DRRENCE FROM THE TRAFFIC INSPECTOR THAT ADEQUATE PROGRES ID THAT ADEQUATE PREPARATIONS ARE IN PLACE TO SCHEDULE A VERBAL CON AS REEN ACHIEVED AND TURN ON WALK-THROUGH INPECTION MEETING. IF IN THE OPINION OF THE TRAFFI PROGRESS AND ADEQUATE PREPARATIONS ARE NOT COMPLETE, THE PRE-"THE WALK-THROUGH INSPECTION MEETING WILL BE POSTPONED TO ALLOW ADEC INCOMPLETE CONSTRUCT ON ITEMS AND PREPARATIONS TO BE COMPLETED. INSPECTOR, REQUIRED AFTER THE CONTRACTOR HAS COMPLETED ALL INCOMPLETE ITEMS AND PREPARATION SHALL REQUEST THE TRAFFIC INSPECTOR REVIEW AND APPROVE ITEMS S. THE CONTRACTOR PREVIOUSLY IDENTIFIED. THE OPINION OF THE TRAFFIC INSPECTOR REVIEW AND AFFROVE IF, IN THE OPINION OF THE TRAFFIC INSPECTOR, ALL ITEMS IS SATISFACTORILY, THE DATE OF THE PRE-"TURN ON" WALK-THROW ESTABLISHED. TIME EXTENSION TO THE CONTRACT TIME WILL CAUSED BY INCOMPLETE CONSTRUCTION OR INADEQUATE CONTRACT BEEN ADDRESSED H INSPECTION SHALL BE NOT BE GRANTED FOR DELAYS ACTOR PREPARATIONS REQUIRED TO COMPLETE TRAFFIC SIGNAL SYSTEM WITHIN THE TIMEFTAME SET FORTH IN THE CONTRACT.
- 3. PRIOR TO ACTIVATING A NEW TRAFFIC GNAL. THE O NTRACTOR SHALL REQUEST A PRE-TURN ON WITH ITEM 2. THE PURPOSE OF THE WALK-THROUGH INSPECTION MEETING, IN MEETING WILL BE TO ESTABLISH THAT THE ACCORDANCE WITH THE CONTRACT, AND IN A SIGNAL SYSTEM HAS BEEN CONSTRUCTED IN THAT DOES NOT ADVERSELY IMPACT PUBLIC SAFETY. THIS MEETING SHALL BE OF RECORD, AND THE CONTRACTOR. AS A M DED BY THE TRAFFIC INSPECTOR, THE ENGINEER N. ANY DEFICIENCIES THAT ADVERSELY IMPACT PUBLIC SAFETY WILL BE IDENTIFIED FOR FOR THE TRAFFIC SIGNAL SYSTEM. ITEM PRIOR TO ESTABLISHING THE "TURN ON" DATE AN IMPACT ON PUBLIC SAFETY INCLUDE, BUT ARE NOT LIMITED TO: PAVEMENT MARKINGS AND SINAGE, PROPER AND ACCEPTABLE BONDING OF EARTH GROUNDS, PROPERLY ALIGNED TRAFFIC SIGNALS, FULLY OPERATIONAL T-TO-FIELD WIRING, AND PROPERLY
 DDRESS THE PUNCHLIST ITEMS VEHICULAR AND PEDESTRIAN DETEC COMPLETED CABINE TERMINATED ELECTRICAL SERVICE NDÚCTORS, FAILURE TO IDENTIFIED AS BEING CRITICAL MEETING WILL RESULT IN THE O PUBLIC SAFETY PRIOR TO THE PRE-TURN ON WALK-THROUGH URN ON" BEING POSTPONED TO LOW ADEQUATE TIME FOR THE INCOMPLETE ITEMS TO BE CONTRAFFIC SIGNAL HAS BEEN 20 LETED. AT SUCH TIME AS MEETING ATTENDEES AGREE THAT THE SYSTRUCTED IN ACCORDANCE WITH THE CONTRACT, AND THAT THE TRAFFIC SIGNAL, AS IT STS, IS NOT A THREAT TO PUBLIC SAFET A "TURN ON" DATE WILL BE ESTABLISHED.
- 4. THE CONTRACTOR SHALL HAVE 10 DAYS FROM THE DATE THE TRAFFIC SIGNAL SYSTEM IS TURNED ON TO COMPLETE AND PUNCHLIST ITEMS IDENTIFIED AT THE PRE-"TURN ON" WALK-THROUGH MEETING OR AT THE TIME THE SIGNAL SYSTEM IS ACTIVATED THAT ARE NOT OTHERWISE ADDRESSED PRIOR TO ACTIVATION OF THE TRAFFIC SIGNAL SYSTEM.
- 5. THE CONTRAC OR'S ATTENTION IS DIRECTED TO STANDARD SPECIFICATION ITEM 1000, TRAFFIC SIGNAL INSTALLATION AND MODIFICATION, WHICH INCLUDES PROCEDURES AND REQUIREMENTS REGARDING ACTIVATION OF TRAFFIC SIGNAL CONTROL SYSTEMS. THE PROJECT MANUAL MA INCLUDE SPECIAL SPECIFICATIONS AND/OR SPECIAL PROVISIONS RELATED TO PROPOSED TRAFFIC COUTROL SIGNAL SYSTEM INSTALLATION(S) AND MODIFICATION(S) REQUIRING THE CONTRACTOR'S ADHABENCE TO DEFINED CHECKLISTS, PROCEDURES AND/OR REPORTS AT NO ADDITIONAL COST TO THE COUNTY DEFYOND THE ESTABLISHED BID ITEMS OF THE CONTRACT.

NCFCD

- 1. OBTAIN AND COMPLY WITH ALL APPLICABLE CITY,
 COUNTY, STATE, AND FEDERAL PERMITS AND APPROVALS, WITH ASSISTANCE FROM ENGINEER, I
 NECESSARY. OBTAIN PERMIT (CERTIFICATION) FROM HARRIS COUNTY ENGINEER TO ENTER HARRIS
 COUNTY NEODD CONTROL DISTRICT RIGHT-OF-WAY.
- NOTIFY THE ARRIS COUNTY FLOOD CONTROL DISTRICT'S PROPERTY MANAGEMENT DEPARTMENT IN WRITING AT LEAST 48 HOURS PRIOR TO CONSTRUCTION. SUBMIT THE HOFCE 48 HOUR PRE-CONSTRUCTION NOTIFICATION FORM, A COPY OF THE APPORVE CONSTRUCTION ORAWINGS, AND A COPY OF THE CORPS OF ENGINEERS INDIVIDUAL SECTION 404 PERMIT, IF APPLICABLE, TO HOFCE, 9900 NORTHWEST FREEWAY, HOUSTON, TEXAS 77092, ATTN: PROPERTY MANAGEMENT DEPT. BY HAND DELIVERY, OR FAX TO N.3-684-4129 (FAX NUMBER).
- 3. ENGINEER SHALL SUBMIT CERTIFICATION LETTER AND RECORD DRAWINGS TO THE HARRIS COUNTY FLOOD CONTROL DISTRICT'S PROPERTY MANAGEMENT DEPARTMENT REQUESTING INSPECTION OF ITEMS CONSTRUCTED IN HARRIS COUNTY LOOD CONTROL DISTRICT RIGHT-OF-WAY. PRIOR TO REQUESTING INSPECTION, THE DRAINAGE RIGHT OF-WAY AND/OR EASEMENTS SHALL BE STAKED AND FLAGGED.
- 4. PROTECT, MAINTAIN, AND RESTORE EXISTING BACKSLOPE DRAINAGE SYSTEM.
- BACKSLOPE SWALE AND INTERCEPTOR STRUCTURE ELEVATIONS AND LOCATIONS SHOWN IN PLANS ARE APPROXIMATE. FINAL ELEVATIONS AND LOCATIONS HALL BE FIELD VERIFIED BY THE ENGINEER PRIOR TO INSTALLATION.
- 6. ESTABLISH TURF GRASS ON ALL DISTURBED LEAS WI HIN THE CHANNEL OR DETENTION RIGHT-OF-WAY, EXCEPT THE CHANNEL BOTTOM AND WHERE STRUCTURAL ENOSION MEASURES ARE USED. MINIMUM ACCEPTANCE CRITERIA ARE 75% COVERAGE OF LIVE BERMONA GRASS AND NO EROSION OR RILLS DEEPER THAN 4".
- 7. BACKFILL IN ACCORDANCE WITH I HARRIS COUNTY FLOOD CONTROL DISTRICT STANDARD SPECIFICATION, SECTION 023 5 EXCAVATING AND BACKFILLING OR EQUIVALENT.
- 8. EXCAVATE CHANNEL FLOWLINE TO DESIGN ELEVATION AS SHOWN ON PLANE AND DOWNSTREAM, AS NECESSARY, TO ENSURE NO WATER REMAINS IN THE FACILITY (STORM SENER, LATERAL CHANNEL, OR DRY BOTTOM DETENTION BASIN) DURING NORMAL WATER SURFACE CONDITIONS IN THE CHANNEL, SO THE FACILITY WILL FUNCTION AS INTENDED. FOR WET BOTTOM DETENTION BASINS, ENSURE NO WATER IS ABOVE THE DESIGN LEVEL IN THE WET BOTTOM DURING NORMAL WATER SURFACE CONDITIONS IN THE CHANNEL.
- 9. MAINTAIN LOW IN CHANNEL DURING CONSTRUCTION AND RESTORE CHANNEL TO ORIGINAL CONDITION.
- 10. REMOVE ALL EXCAVATED MATERIAL FROM THE HARRIS COUNTY FLOOD CONTROL DISTRICT OR DRAMAGE RIGHT-OF-WAY, NO FILL IS TO BE PLACED WITHIN A DESIGNATED FLOOD PLAIN AREA WITHOUT FIRST OBTAINING A FILL PERMIT FROM THE APPROPRIATE JURISDICTIONAL AUTHORIT

TRAFFIC CONTROL

- THE CONTRACTOR SHALL PROVIDE AND INSTALL TRAFFIC CONTROL DEVICES IN CONFORMANCE WITH PART VI OF THE MOST RECENT EDITION OF THE MANUAL ON UNIFORM TRAFFIC CONTROL DEVICES AND THE APPROVED TRAFFIC CONTROL PLAN
- THE CONTRACTOR SHALL MAINTAIN AT LEAST ONE LANE OF TRAFFIC IN EACH DIRECTION DURING WORKING HOURS EXCEPT DURING FLAGGING OPERATION OR PROVIDE DETOURS AROUND THE CONSTRUCTION SITE AND PROVIDE PUBLIC NOTIFICATION.
- 3. LANE CLOSURES SHALL BE DURING OFF-PEAK HOURS ONLY (MONDAY THROUGH FRIDAY 9 A.M. TO 4 P.M.) UNIFORMED PEACE OFFICERS OR FLAGGERS IN RADIO CONTACT ARE REQUIRED TO DIRECT TRAFFIC DURING LANE CLOSURES.
- 4. DETOURS REQUIRE PRIOR APPROVAL OF THE FIELD ENGINEER AND PRECINCT. DETOUR PLANS, IF ALLOWED, MUST INCLUDE APPROPRIATE DETOUR SIGNAGE, PUBLIC NOTICE VIA SIGNAGE TWO WEEKS IN ADVANCE STATING THE DATES OF THE AGREED UPON DATE OF CLOSURE AND DATE THE ROAD WILL RE-OPEN TO TRAFFIC. CONTRACTOR TO USE (WITH PRIOR APPROVAL OF THE FIELD ENGINEER) HIGH EARLY STRENGTH CONCRETE AND OTHER RELATED CONSTRUCTION METHODS TO MINIMIZE THE DURATION OF THE DETOUR AND TO ENSURE THAT THE ROADWAY IS OPEN ON, OR PRIOR TO, THE AGREED UPON DATE.
- 5. ONE DAY PRIOR TO THE IMPLEMENTATION OF A TRAFFIC CONTROL PLAN PHASE OR STEP, OR THE IMPLEMENTATION OF AN ADDITIONAL, REVISED, OR NEW TRAFFIC CONTROL ELEMENT, THE CONTRACTOR SHALL MEET WITH THE ENGINEER TO GIVE A DETAILED DESCRIPTION OF THE CONTRACTOR'S PLAN AND PREPARATIONS. THE CONTRACTOR SHALL OBTAIN WRITTEN CONCURRENCE FROM THE ENGINEER THAT ADEQUATE PROJECT PROGRESS HAS BEEN ACHIEVED AND THAT ADEQUATE PREPARATIONS ARE IN PLACE PRIOR TO SWITCHING TRAFFIC. IF, IN THE OPINION OF THE ENGINEER, REQUIRED PROGRESS AND ADEQUATE PREPARATIONS ARE NOT COMPLETE, THE CONTRACTOR SHALL NOT IMPLEMENT THE NEXT PHASE, STEP, OR ELEMENT OF TRAFFIC CONTROL UNTIL INCOMPLETE CONSTRUCTION ITEMS OR PREPARATIONS ARE COMPLETED. TIME EXTENSIONS WILL NOT BE GRANTED FOR DELAYS CAUSED BY THE INCOMPLETE CONSTRUCTION ITEMS OR INADEQUATE CONTRACTOR PREPARATIONS REQUIRED TO IMPLEMENT TRAFFIC CONTROL
- 6. TRAFFIC CONTROL PER THE CONTRACT IS REQUIRED FOR THE ENTIRE DURATION OF THE PROJECT, INCLUDING THE PUNCHLIST PERIOD. PAYMENT FOR TRAFFIC CONTROL THAT IS PROPERLY INSTALLED FOR LESS THAN A FULL MONTH SHALL BE BASED ON A PERCENTAGE BASIS OF THE TIME INSTALLED. TRAFFIC CONTROL PAYMENTS TO THE CONTRACTOR SHALL END 10 DAYS AFTER SUBSTANTIAL COMPLETION, ALTHOUGH PROPER TRAFFIC CONTROL MUST BE MAINTAINED UNTIL PUNCHLIST COMPLETION.
- 7. THE PURPOSE OF THE CONSTRUCTION SEQUENCE AND TRAFFIC HANDLING OUTLINED HEREIN IS TO DOCUMENT A VIABLE TCP THAT CAN BE UTILIZED TO CONSTRUCT THE PROJECT. IT IS THE BASIS OF ESTIMATION FOR THE TRAFFIC CONTROL BID ITEMS, AND IS TO BE UTILIZED AND IMPLEMENTED, UNLESS OTHERWISE DIRECTED BY THE ENGINEER.

IF THE CONTRACTOR CHOOSES TO USE A DIFFERENT TCP, HE/SHE SHALL PREPARE AND SUBMIT THE ALTERNATIVE TCP TO THE COUNTY FOR APPROVAL NO LESS THAN 10 WORKING DAYS PRIOR TO THE PROPOSED IMPLEMENTATION DATE. THE TCP SHALL BE DRAWN TO SCALE AND SIGNED & SEALED BY A PROFESSIONAL ENGINEER LICENSED TO PRACTICE IN THE STATE OF TEXAS. UPON APPROVAL BY HARRIS COUNTY, THE ALTERNATIVE PLAN SHALL BECOME THE BASIS FOR A "CHANGE IN CONTRACT" TO REVISE THE TRAFFIC CONTROL BID ITEMS ACCORDINGLY AND BECOME PART OF THE CONTRACT DOCUMENTS.

NOTICE:

*CONSTRUCTION IN HARRIS COUNTY FLOOD CONTROL DISTRICT RIGHT-ON-WAY REQUIRES:

SITE PLANS MUST BE APPROVED PRIOR TO OBTAINING THE REQUIRED HCFCD RIGHT-OF-WAY NOTIFICATION. BE ADVISED THAT THE HCFCD RIGHT-OF-WAY NOTIFICATION IS EPARATE FROM THE SITE DEVELOPMENT PERMIT PACKAGE

- 1.) HCFCD RIGHT-OF-WAY NOTIFICATION (PERMIT)
- 2.) HCFCD 48 HOUR PRE-CONSTRUCTION NOTIICE

BOTH ARE REQUIRED PRIOR TO EXTERING OR WORKING WITHIN HARRIS COUNTY FLOOD CON ROL DISTRICT RIGHT-OF-WAY NOTIFICATION AND 48-HOUR NOTIFICE MUST BE PROVIDED TO HEFED AT DELDBHEFED. ORG.

TO APPLY FOR THE HCFCD RIGHT-OF-WAY NOTIF ATION PLEASE GO TO HTTP://APPS.HARRISCOUNTYTX.GOV EPERMITS AND APPLY FOR THE HCFCD

FAILURE TO PROVIDE BOTH ITEMS COULD RESULT IN PROJECT DELAYS.



NO. REVISIONS DATE NAME



801 Congress Avenue, Suite 325, Houston, TX 77002 TEL (713) 270-8145/FAX (281) 809-0807 TBPE Registration No. F-3158



HARRIS COUNTY ENGINEERING DEPARTMENT PROJECT TITLE:

PROJECT TITLE:
POLK STREET ON—STREET BIKEWAY

DRAWN BY: SHEET DESCRIPTION:
GB GENERAL NOTES


CK'D BY:
JL SHEET 1 OF 1

SCALE:
NONE

DATE:
4/12/2019

SHEET NO:

103

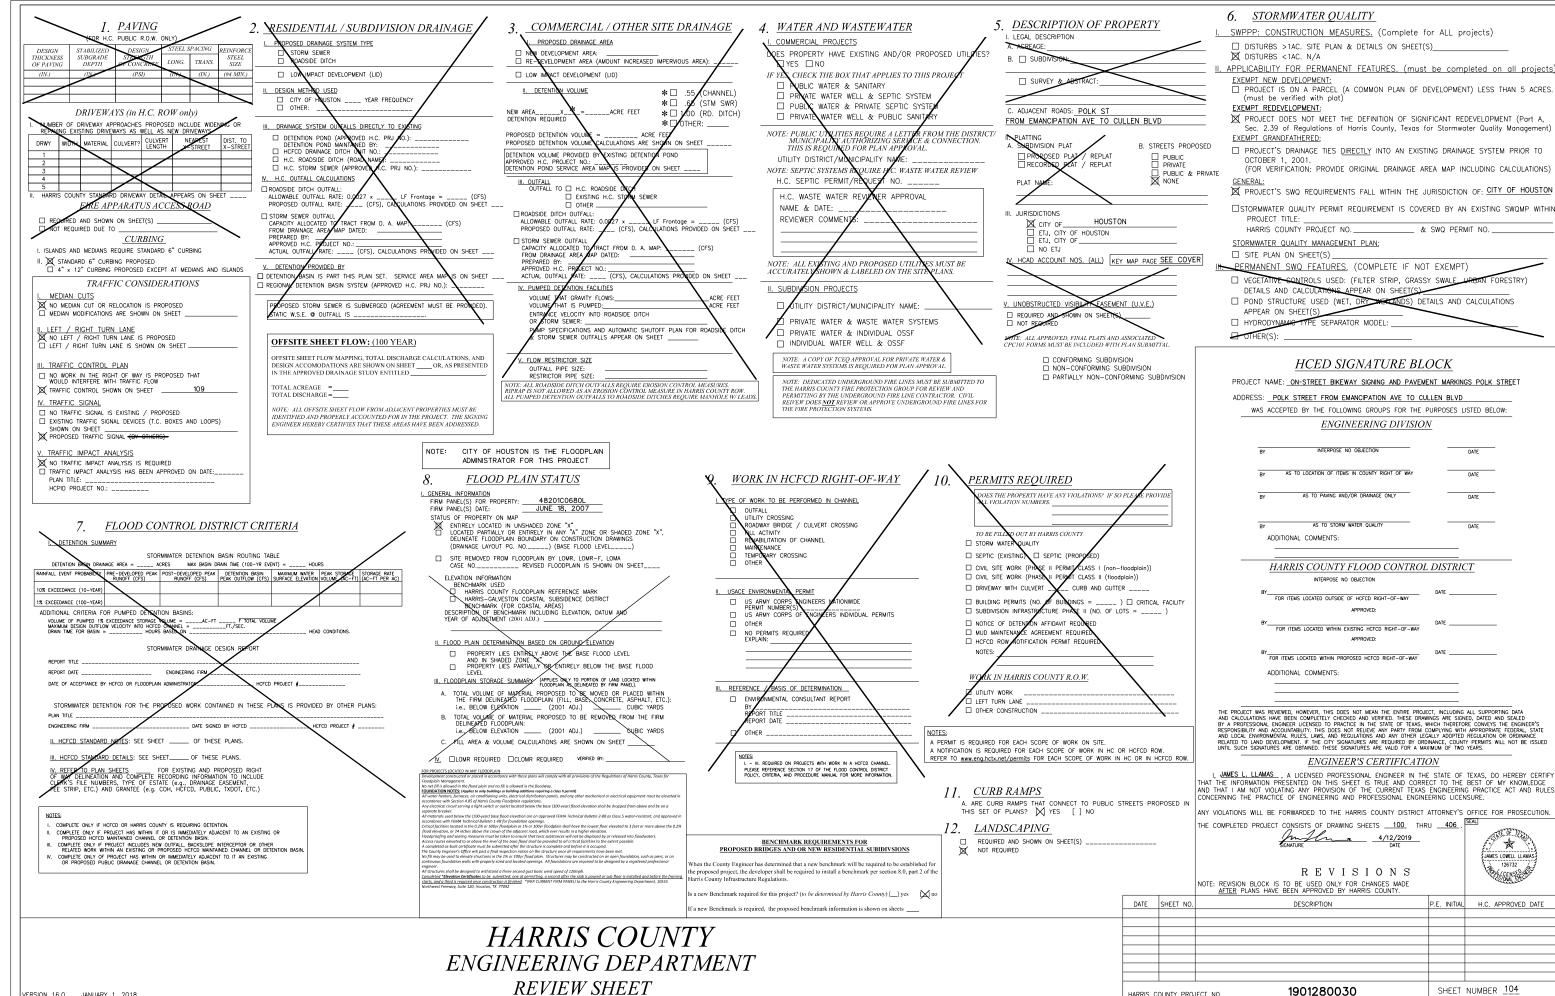

HARRIS COUNTY PROJECT NO

VERSION 16.0 JANUARY 1, 2018

	О
DATE:4/12/2019 12:46:27 PM USER:/USER/	04
	\u00e4
	Ź
	 X
	3/B
	2
	۷
	a O
	_
	+
	-:
	ă
	5
	ţ
EP.	Š
٦VS	ď
ä	7
JSE	H
_	, s.
	<u>a</u>
	5
Σ	6
7 P	ā
2	č
46	F
12	C
	ţ.
	7
	<u>'</u> _
19	ç
/20	C
12	Ì
:4/	ij
√ TE	4 =
á	ū

			PROJECT
ITEM NO	DESCRIPTION	UNIT	TOTAL
4	Remove and Dispose of Existing Concrete Pavement, All Depths including sawcut	SY	1,354
7	Place, Maintain and Remove Project Identification Signs	EA	2
10	Remove & Relocate Traffic Signs, Mail Boxes and Roadway Signs	EA	2
19	Concrete Pavement (10" Depth) including saw cut and doweling into Existing Pavement	SY	65
20	Concrete Pavement (7" Depth) (High-Early Strength) including saw cut and doweling into Existing Pavement	SY	101
24	Concrete Esplanades, Medians and Directional Islands (6" Depth)	SY	330
29	Concrete ADA Ramp (up to Six (6) feet wide (inclusive), All Types, Complete in Place)	EA	48
31	Reinforced Concrete Sidewalks (4-1/2" thick) (#3 Bar @ 18" Center to Center)	SY	1,568
32	Six Inch Reinforced Concrete Curb and Gutter (Monolithic)	LF	946
33	Six Inch Reinforced Concrete Curb (Doweled)	LF	586
73	Traffic Control - Barricades, Barriers, Barrels, Cones, and Signing	EA	1
75	Aluminum Signs - Furnish & Install	EA	259
77	Remove Existing Ground Mounted Sign and Post Assembly	EA	52
78	Flexible Post Delineators (Surface Mounted, All Styles, All Heights)	EA	17
82	Reflectorized Pavement Markings Type I - 4" Solid Yellow	LF	9,291
83	Reflectorized Pavement Markings Type I - 6" Solid White	LF	18,029
84	Reflectorized Pavement Markings Type I - 6" Guide White	LF	1,530
85	Reflectorized Pavement Markings Type I - 8" Yield Triangles White	EA	28
86	Reflectorized Pavement Markings Type I - 12" Solid White	LF	2,491
89	Reflectorized Pavement Markings Type I - 24" Solid White	LF	594
92	Reflectorized Pavement Markings Type I - Solid Green	SF	2,961
94	Reflectorized Pavement Markings - Type I (W) (WORD, SYMBOL, ARROW, RR Crossing "X", Sharrow, Etc.)	EA	58
95	Methyl Methacrylate Pavement Markings (All Widths, All Colors)	SF	1,220
99	Reflectorized Pavement Markers - Type II-AA	EA	121
134	3 Section Bicycle Signal Head (Vertical) (B3)	EA	2
147	7/C-#14 AWG XHHW Solid Cable	LF	1,000
178	Cycle Lane Separator - Zicla Zebra13 Black/White "Armadillo"	EA	1,002
190	Pedestrian Railing (TxDOT PR-1)	LF	195
202	Checker Steel Culvert Plate and Support Irons (Furnish & Install)	LF	350
207	Reflective PM TY C Preform (BUS) (GREEN/WHITE)	EA	4
209	Reflective PM TY C Preform (STRAIGHT ARROW) (GREEN/WHITE)	EA	15
210	Reflective PM TY C Preform (TURN BOX) (GREEN/WHITE)	EA	2
213	Reflective PM TY C Preform (BIKE MAN) (GREEN/WHITE)	EA	15
216	Surface-Applied Detectable Warning Material	SF	76
224	Surface-Applied Directional Tactile Material, 12" width	LF	365
226	Cast-In-Place Detectable Warning Material	SF	296
TBD	Reflective PM TY C Preform (BIKE DETECTOR) (GREEN/WHITE)	EA	2





NO.	REVISIONS	DATE	NAME
l		1	



801 Congress Avenue, Suite 325, Houston, TX 77002 TEL (713) 270-8145/FAX (281) 809-0807 TBPE Registration No. F-3158



PROJECT TITL	E:	
	LK STREET ON-STREET BIKE	WAY
DRAWN BY:	SHEET DESCRIPTION:	
GB	BASIS OF ESTIMA	λTE
CK'D BY:		
JL		
SCALE:		
NONE		
DATE:	APPROVED BY:	
4/12/2019		
		SHEET NO:
		105
		100

		POLK ON-STREET BIKEWAY				TOTAL					
ITEM			SHEET	SHEETS							
NO.	DESCRIPTION	UNIT	1 OF 8	2 OF 8	3 OF 8	4 OF 8	5 OF 8	6 OF 8	7 OF 8	8 OF 8	1-8
4	Remove and Dispose of Existing Concrete Pavement, All Depths including sawcut	SY	332	263	463	57	68	30	-	141	1,354
7	Place, Maintain and Remove Project Identification Signs	EA	1	-	-	-	-	-	-	1	2
10	Remove & Relocate Traffic Signs, Mail Boxes and Roadway Signs	EA	-	-	-	1	-	-	-	1	2
19	Concrete Pavement (10" Depth) including saw cut and doweling into Existing Pavement	SY	22	9	17	-	-	-	-	17	65
20	Concrete Pavement (7" Depth) (High-Early Strength) including saw cut and doweling into Existing Pavement	SY	-	-	11	_	60	-	-	30	101
24	Concrete Esplanades, Medians and Directional Islands (6" Depth)	SY	34	34	77	-	118	-	-	67	330
29	Concrete ADA Ramp (up to Six (6) feet wide (inclusive), All Types, Complete in Place)	EA	10	12	16	5	1	2	-	2	48
31	Reinforced Concrete Sidewalks (4-1/2" thick) (#3 Bar @ 18" Center to Center)	SY	375	235	508	50	152	12	-	236	1,568
32	Six Inch Reinforced Concrete Curb and Gutter (Monolithic)	LF	200	115	298	-	115	-	-	218	946
33	Six Inch Reinforced Concrete Curb (Doweled)	LF	80	70	140	-	50	-	-	246	586
73	Traffic Control - Barricades, Barriers, Barrels, Cones, and Signing	EA	1	-	-	-	-	-	-	-	1
75	Aluminum Signs - Furnish & Install	EA	36	48	58	36	26	30	13	12	259
77	Remove Existing Ground Mounted Sign and Post Assembly	EA	7	9	16	8	3	3	2	4	52
78	Flexible Post Delineators (Surface Mounted, All Styles, All Heights)	EA	2	2	7	-	2	-	-	4	17
82	Reflectorized Pavement Markings Type I - 4" Solid Yellow	LF	1,315	1,348	1,528	800	550	2,030	980	740	9,291
83	Reflectorized Pavement Markings Type I - 6" Solid White	LF	3,100	2,461	3,031	2,892	1,460	2,660	1,373	1,052	18,029
84	Reflectorized Pavement Markings Type I - 6" Guide White	LF	142	292	211	224	80	305	176	100	1,530
85	Reflectorized Pavement Markings Type I - 8" Yield Triangles White	EA	4	4	8	-	4	-	-	8	28
86	Reflectorized Pavement Markings Type I - 12" Solid White	LF	450	503	307	360	600	225	46	-	2,491
89	Reflectorized Pavement Markings Type I - 24" Solid White	LF	108	118	91	74	130	45	12	16	594
92	Reflectorized Pavement Markings Type I - Solid Green	SF	470	620	440	385	500	400	66	80	2,961
94	Reflectorized Pavement Markings - Type I (W) (WORD, SYMBOL, ARROW, RR Crossing "X", Sharrow, Etc.)	EA	10	16	10	4	6	4	4	4	58
95	Methyl Methacrylate Pavement Markings (All Widths, All Colors)	SF	350	300	-	-	-	570	-	-	1,220
99	Reflectorized Pavement Markers - Type II-AA	EA	18	19	21	8	9	25	12	9	121
134	3 Section Bicycle Signal Head (Vertical) (B3)	EA	-	-	-	-	2	-	-	-	2
147	7/C-#14 AWG XHHW Solid Cable	LF	-	-	-	-	1,000	-	-	-	1,000
178	Cycle Lane Separator - Zicla Zebra13 Black/White "Armadillo"	EA	147	146	104	170	66	190	106	73	1,002
190	Pedestrian Railing (TxDOT PR-1)	LF	27	27	54	-	33	-	-	54	195
202	Checker Steel Culvert Plate and Support Irons (Furnish & Install)	LF	50	50	100	-	50	-	-	100	350
207	Reflective PM TY C Preform (BUS) (GREEN/WHITE)	EA	1	1	0	0	0	2	0	0	4
209	Reflective PM TY C Preform (STRAIGHT ARROW) (GREEN/WHITE)	EA	3	1	1	2	4	2	0	2	15
210	Reflective PM TY C Preform (TURN BOX) (GREEN/WHITE)	EA	0	0	0	0	2	0	0	0	2
213	Reflective PM TY C Preform (BIKE MAN) (GREEN/WHITE)	EA	3	1	1	2	4	2	0	2	15
216	Surface-Applied Detectable Warning Material	SF	0	0	40	0	36	0	0	0	76
224	Surface-Applied Directional Tactile Material, 12" width	LF	49	45	82	-	30	-	-	159	365
226	Cast-In-Place Detectable Warning Material	SF	48	48	56	-	48	-	-	96	296
TBD	Reflective PM TY C Preform (BIKE DETECTOR) (GREEN/WHITE)	EA	-	-	-	_	2	-	-		2





NO.	REVISIONS	DATE	NAME



801 Congress Avenue, Suite 325, Houston, TX 77002 TEL (713) 270-8145/FAX (281) 809-0807 TBPE Registration No. F-3158



HARRIS COUNTY ENGINEERING DEPARTMENT

PROJECT TITL	E:	
	LK STREET ON-STREET BIKE	WAY
DRAWN BY:	SHEET DESCRIPTION:	
GB	SIGNING, PVMT MARKING, a	& SIDEWALK
CK'D BY:		
JL	QUANTITY SUMMA	.RY
SCALE:		
NONE		
DATE:	APPROVED BY:	
4/12/2019		
		SHEET NO:

106

		POLK ON-STREET BIKEWAY					TOTAL				
ITEM			SHEET	SHEETS							
NO.	DESCRIPTION	UNIT	1 OF 8	2 OF 8	3 OF 8	4 OF 8	5 OF 8	6 OF 8	7 OF 8	8 OF 8	1-8
3	Removing Old Concrete (All Type Curb)	LF	444	246	919	831	98	1,204	639	712	5,093
4	Removing Old Concrete (Pavement W/Curb and Driveway, All Depths including sawcut)	SY	-	1	-	-	-	52	26	-	78
5	Roadway Excavation Including 3" Topsoil	CY	-	1	0	-	-	-	-	-	0
8	Remove & Relocate Traffic Signs, Mail Boxes and Roadway Signs	EA	-	1	1	-	-	-	-	-	1
9	HMAC Base Course (Black Base) (Depth per Plan)	TON	-	-	23	-	-	-	-	-	23
10	Milling Existing Asphalt Pavement (1" to 3" Depth per Plan or Directed by Engineer)	SY	3,450	4,330	4,005	3,950	160	2,600	1,190	1,280	20,965
12	HMAC Surface Course (Depth per Plan)	TON	380	476	452	435	18	286	131	141	2,318
13	Tack Coat (0.1 Gal/SY)	GAL	345	433	401	395	16	260	119	128	2,097
14	Concrete Pavement (7" to 10") including saw cut and doweling into Existing Pavement	SY	-	-	20	-	-	62	26	-	108
20	ADA Ramp (All Types)	EA	-	-	4	-	-	-	-	-	4
21	Reinforced Concrete Sidewalks (4-1/2" thick) (#3 Bar @ 18" Center to Center)	SY	-	-	66	-	-	-	-	-	66
22	Concrete Curb and Gutter (Monolithic)	LF	444	246	1,050	831	98	1,204	639	712	5,224





ı				
	NO.	REVISIONS	DATE	NAME
I				
Ì				
Ì				



801 Congress Avenue, Suite 325, Houston, TX 77002 TEL (713) 270-8145/FAX (281) 809-0807 TBPE Registration No. F-3158



HARRIS COUNTY ENGINEERING DEPARTMENT


PROJECT TITLE:						
P0	POLK STREET ON-STREET BIKEWAY					
DRAWN BY:	SHEET DESCRIPTION:					
GB	PAVEMENT REPAIR					
CK'D BY:						
JL	QUANTITY SUMMARY					
SCALE:						
NONE						
DATE:	APPROVED BY:					
4/12/2019						

SHEET NO: 107

	00:000 1 +00:000
USER:/USER/	1 / · + 0 · · · · · · · · · · · · · · · · ·
12:46:29 PM	
:4/12/2019	70400VGV.

		POLK ON-STREET BIKEWAY				TOTAL					
ITEM			SHEET	SHEETS							
NO.	DESCRIPTION	UNIT	1 OF 8	2 OF 8	3 OF 8	4 OF 8	5 OF 8	6 OF 8	7 OF 8	8 OF 8	1 - 8
75	ALUMINUM SIGNS - FURNISH & INSTALL	EA	-	-	-	-	2	-	-	-	2
134	3 SECTION BICYCLE SIGNAL HEAD (VERTICAL) (B3)	EA	-	-	-	-	2	-	-	-	2
147	7/C-#14 AWG XHHW SOLID CABLE	LF	-	-	-	-	1000	-	-	-	1000



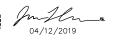


NO.	REVISIONS	DATE	NAME



801 Congress Avenue, Suite 325, Houston, TX 77002 TEL (713) 270-8145/FAX (281) 809-0807 TBPE Registration No. F-3158



PROJECT TITLE:							
POLK STREET ON-STREET BIKEWAY							
DRAWN BY:	SHEET DESCRIPTION:						
GB	SUMMARY OF						
CK'D BY:							
JL	TRAFFIC SIGNAL QUA	NTITIES					
SCALE:							
NONE							
DATE:	APPROVED BY:						
4/12/2019							
		SHEET NO:					
		108					
		100					

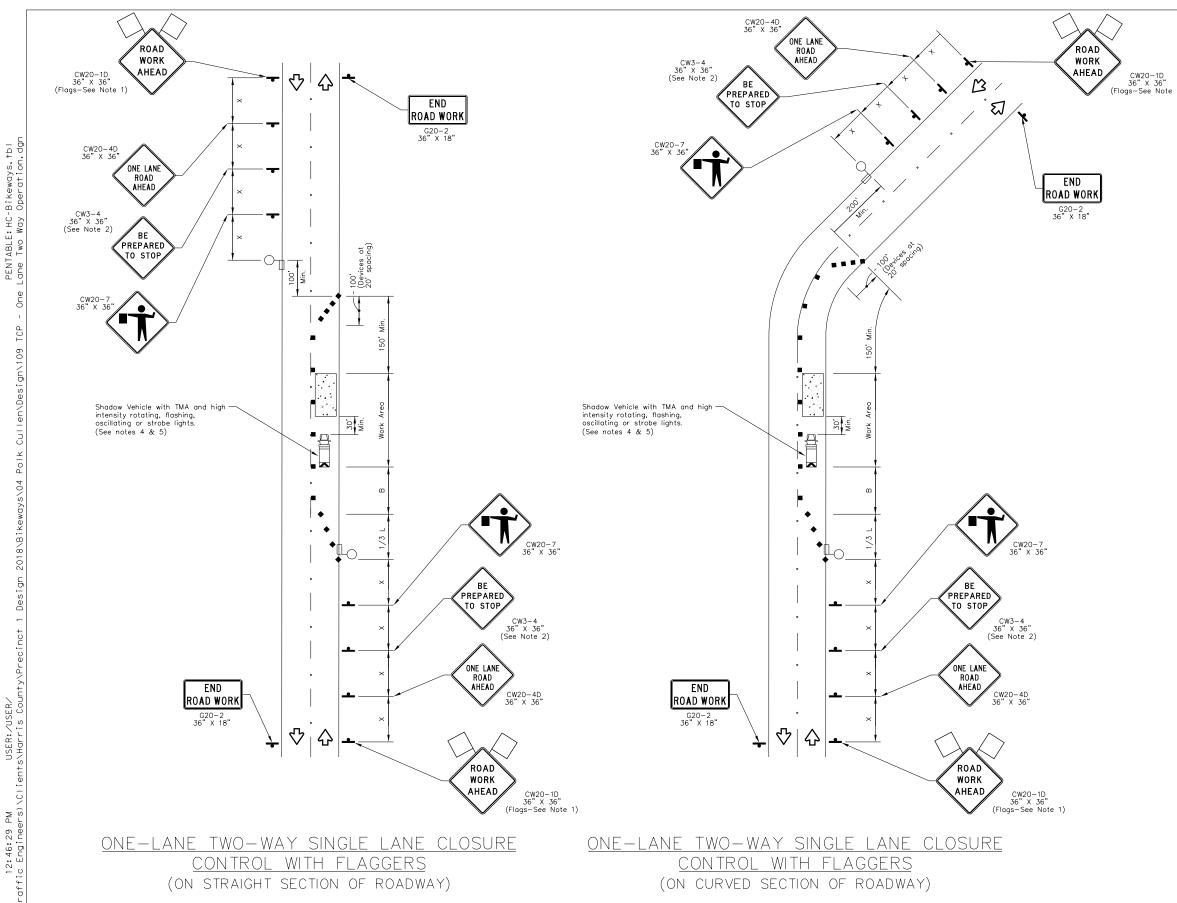

TRAFFIC CONTROL PLAN SECTION SHALL BE COMPLETED BY ENGINEER

ROADWAY	POSTED SPEED	TAPER LENGTH	CHANN	CING ELIZING ICES	SIGN SPACING	BUFFER SPACE
	0. 220		TAPER	TANGENT		
HARDY STREET	35 MPH	225'	35'	70'	160'	120'
ELYSIAN STREET	35 MPH	225'	35'	70'	160'	120'
MAURY STREET	30 MPH	165'	30'	60'	120'	90'
HARRINGTON STREET	30 MPH	165'	30'	60'	120'	90'

	LEGEND							
	Type 3 Barricade	88	Channelizing Devices					
	Heavy Work Vehicle		Truck Mounted Attenuator (TMA)					
	Trailer Mounted Flashing Arrow Board	M	Portable Changeable Message Sign (PCMS)					
-	Sign	7	Traffic Flow					
\Diamond	Flag	Lo	Flagger					

Posted Speed	Formula	Minimum Desirable Taper Lengths "L" * *			Suggested Maximum Spacing of Channelizing Devices		Minimum Sign Spacing "x"	Suggested Longitudinal Buffer Space "B"
		10' Offset	11' Offset	12' Offset	On a Taper	On a Tangent	Distance	"B"
30	ws ²	150'	165'	180'	30'	60'	120'	90'
35	$L = \frac{WS}{60}$	205'	225'	245'	35'	70'	160'	120'
40	60	265	295'	320'	40'	80'	240'	155'
45		450'	495'	540'	45'	90'	320'	195'
50		500'	550'	600'	50'	100'	400'	240'
55	L=WS	550'	605'	660'	55'	110'	500'	295'
60	L- W3	600'	660'	720'	60'	120'	600'	350'
65		650'	715'	780'	65'	130'	700'	410'
70		700'	770'	840'	70'	140'	800'	475'
75		750'	825'	900'	75'	150'	900'	540'

** Taper lengths have been rounded off. L=Length of Taper(FT) W=Width of Offset(FT) S=Posted Speed(MPH)

GENERAL NOTES

Flags attached to signs where shown are OPTIONAL.
 All traffic control devices illustrated are REQUIRED, except those denoted with the triangle symbol are OPTIONAL.

the triangle symbol are OPTIONAL.

Inactive work vehicles or other equipment should be parked near the right-of-way line and not parked on the paved shoulder.

A Shadow Vehicle with a TMA should be used anytime it can be positioned 30 to 100 feet in advance of the area of crew exposure without adversely affecting the performance or quality of the work. If workers are no longer present but road or work conditions require the traffic control to remain in place, Type 3 Barricades or other channelizing devices may be substituted for the Shadow Vehicle and TMA.

the Shadow Vehicle and TMA.

Additional Shadow Vehicles with TMAs may be positioned off the paved surface, next to those shown in order to protect wider work spaces.

Contractor shall provide and install traffic control devices in conformance with

- part VI of Texas Manual on Uniform Traffic Control Devices (TMUTCD Latest edition with revisions) during construction.
 Flaggers should use two-way radios or other methods of communication to control traffic.
- 8. Length of work space should be based on the ability of flaggers to communicate
- 9. If the work space is located near horizontal or vertical curve, the buffer distances should be increased in order to maintain adequate stopping sight
- distances to the flogger and a queue of stopped vehicles (see table above).

 10. Channelizing devices on the center—line may be omitted when a pilot car is leading traffic and approved by the Engineer.
- 11. Flaggers should use 24" STOP/SLOW paddles to control traffic. Flags should be limited to emergency situations.
 12. No lanes shall be blocked from 7am to 9am and 4pm to 6:30pm Monday thru
- rriagy.

 13. Off duty police officers required to direct traffic when applicable.

 14. If project is within 400 feet from a signalized intersection, the Contractor shall contact Horris County Engineering Department, Traffic Signal Maintenance at (713) 881–3210 five (5) days prior to the start of construction.

DATE NAME

REVISIONS

NO.

HARRIS COUNTY ENGINEERING DEPARTMENT






801 Congress Avenue, Suite 325, Houston, TX 77002 TEL (713) 270-8145/FAX (281) 809-0807 TBPE Registration No. F-3158




		POLK/CULLEN STRE
	DRAWN BY:	
0 10	0.475 534	0557 0.500.007.01.
Justen "	CK'D BY:	SHEET DESCRIPTION:
04/12/2019		TRAFFIC (
04/12/2013	SCALE:	
	NONE	ONE LANE, TW
	DATE:	APPROVED BY:
	1/12/2010	1

PROJECT TITLE REETS ON-STREET BIKEWAY HCED STANDARD

CONTROL PLAN WO-WAY OPERATION SHEET NO: 4/12/2019

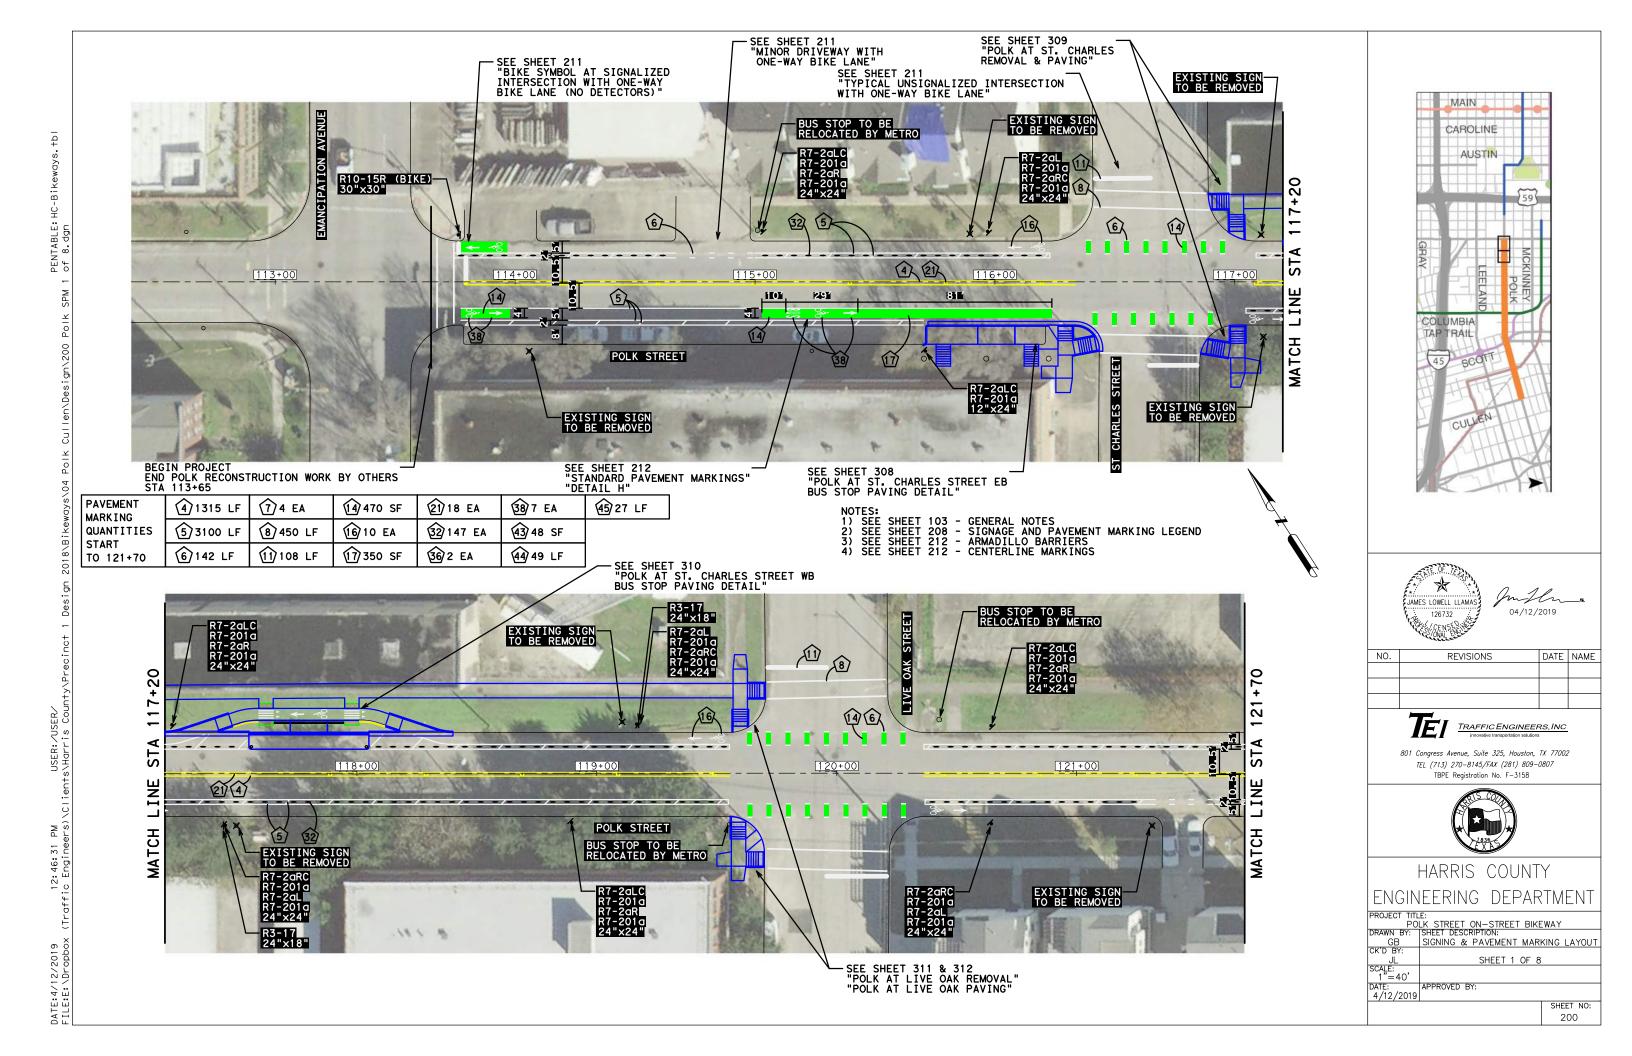

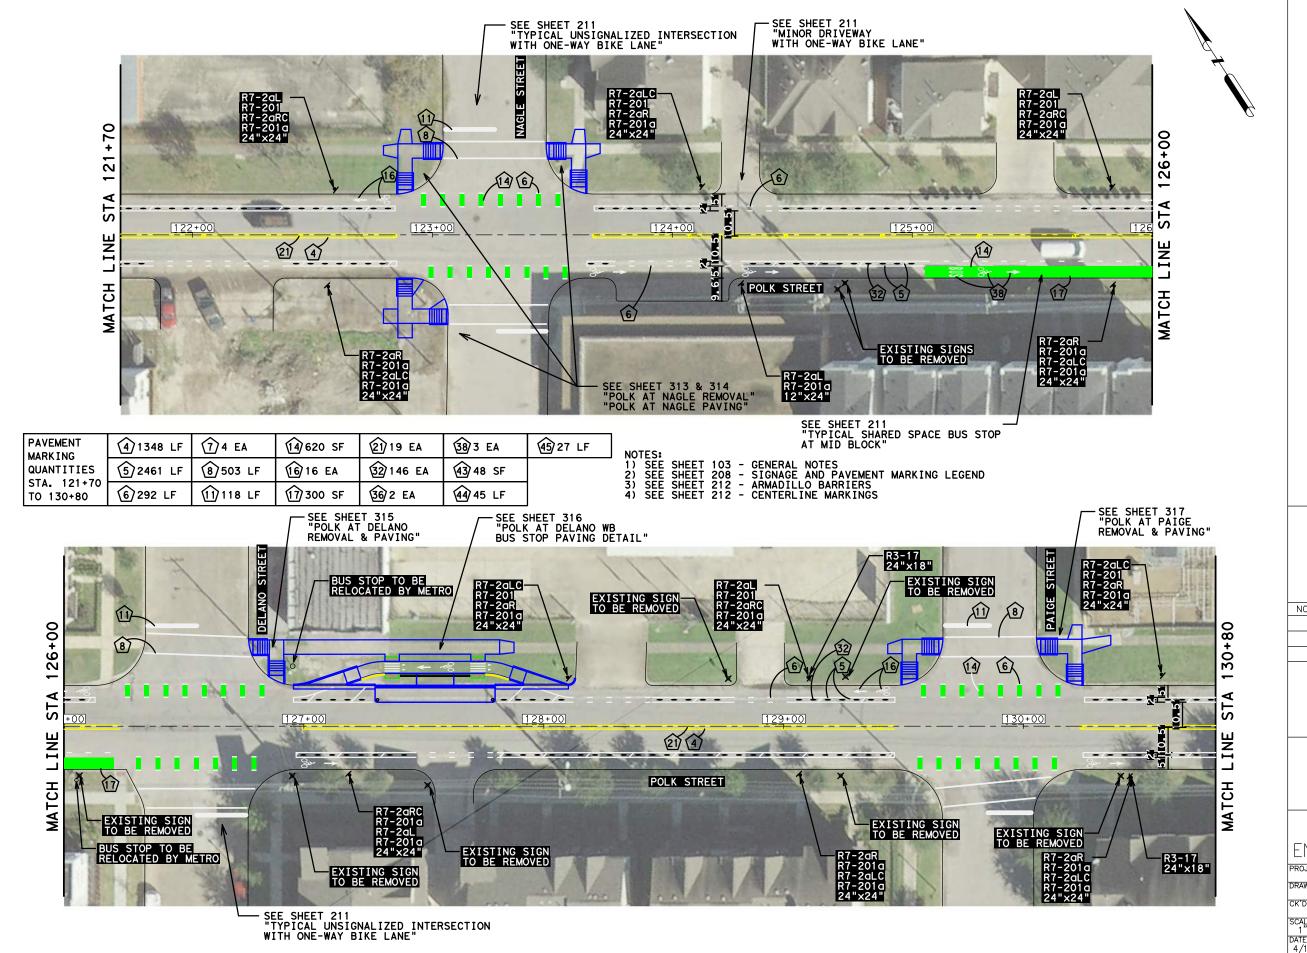

PENTABLE: HC-Bikeways. of 8.dgn

> USER:/USER/ s\Harris Cou

12:46:39 PM (Traffic Engineers)

DATE:4/12/2019 FILE:E:\Dropbo>





NO.	REVISIONS	DATE	NAME



801 Congress Avenue, Suite 325, Houston, TX 77002 TEL (713) 270–8145/FAX (281) 809–0807 TBPE Registration No. F-3158



HARRIS COUNTY ENGINEERING DEPARTMENT

PROJECT TITLE:
POLK STREET ON—STREET BIKEWAY


DRAWN BY: SHEET DESCRIPTION:
GB SIGNING & PAVEMENT MARKING LAYOUT

CK'D BY:
JL SHEET 2 OF 8


SCALE:
1"=40'

DATE:
4/12/2019

SHEET NO:
201

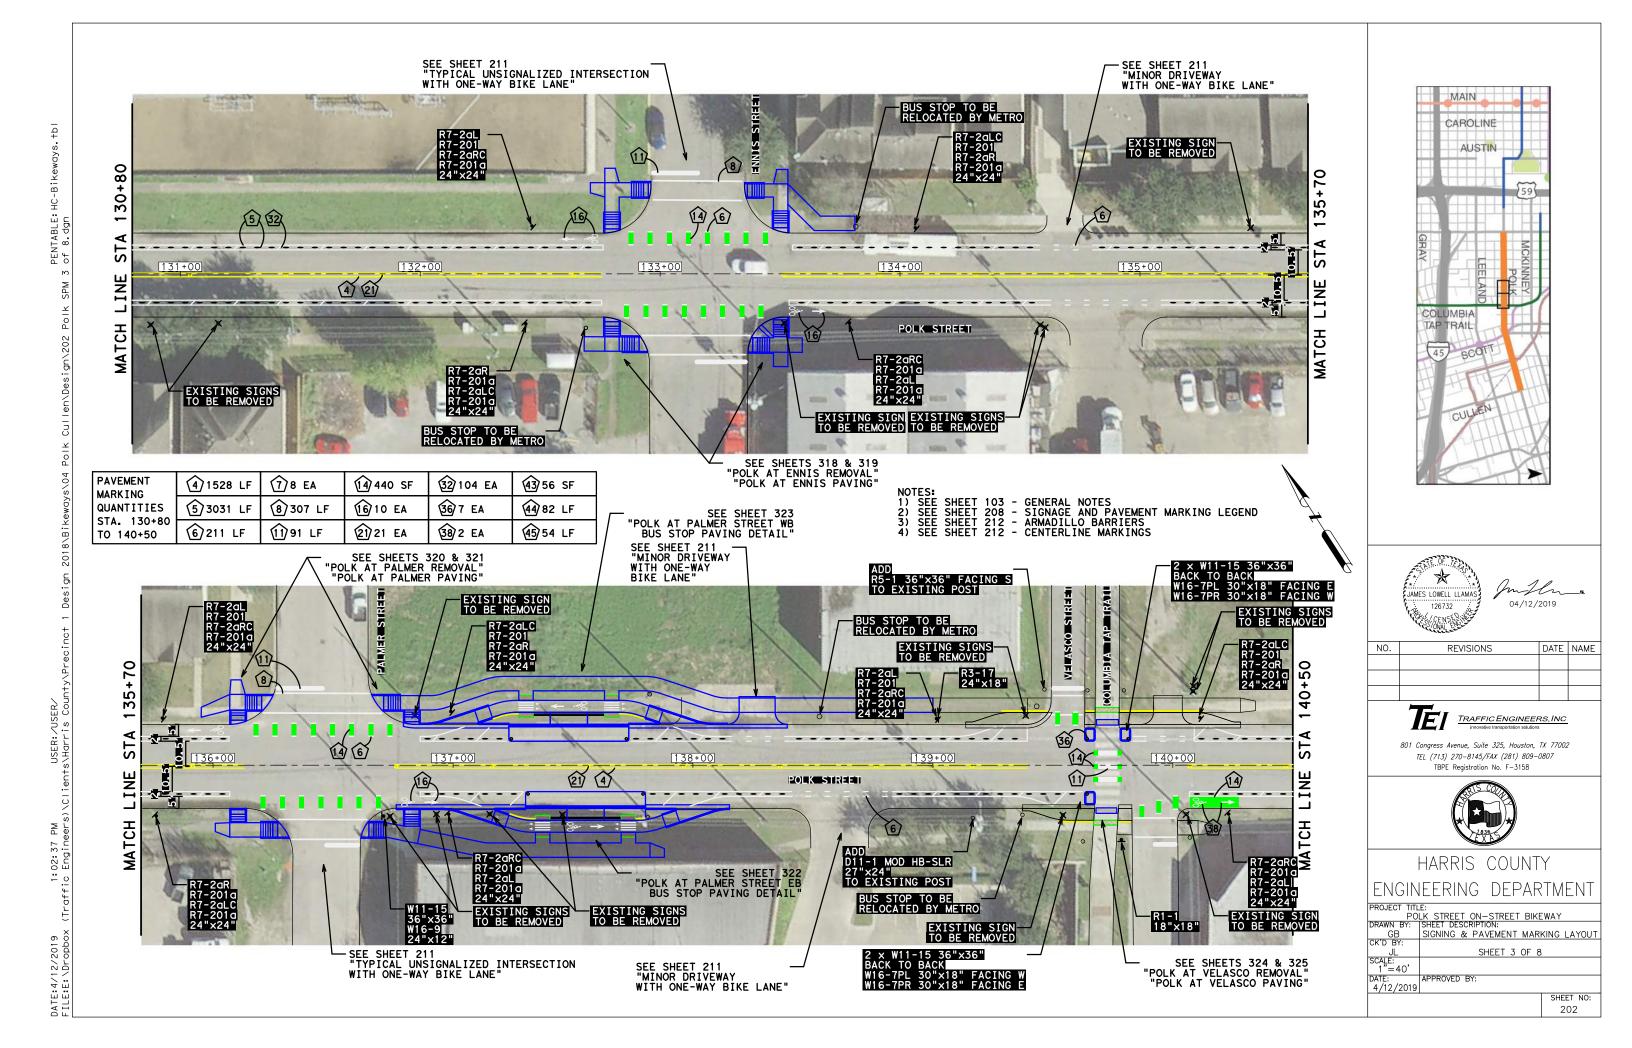



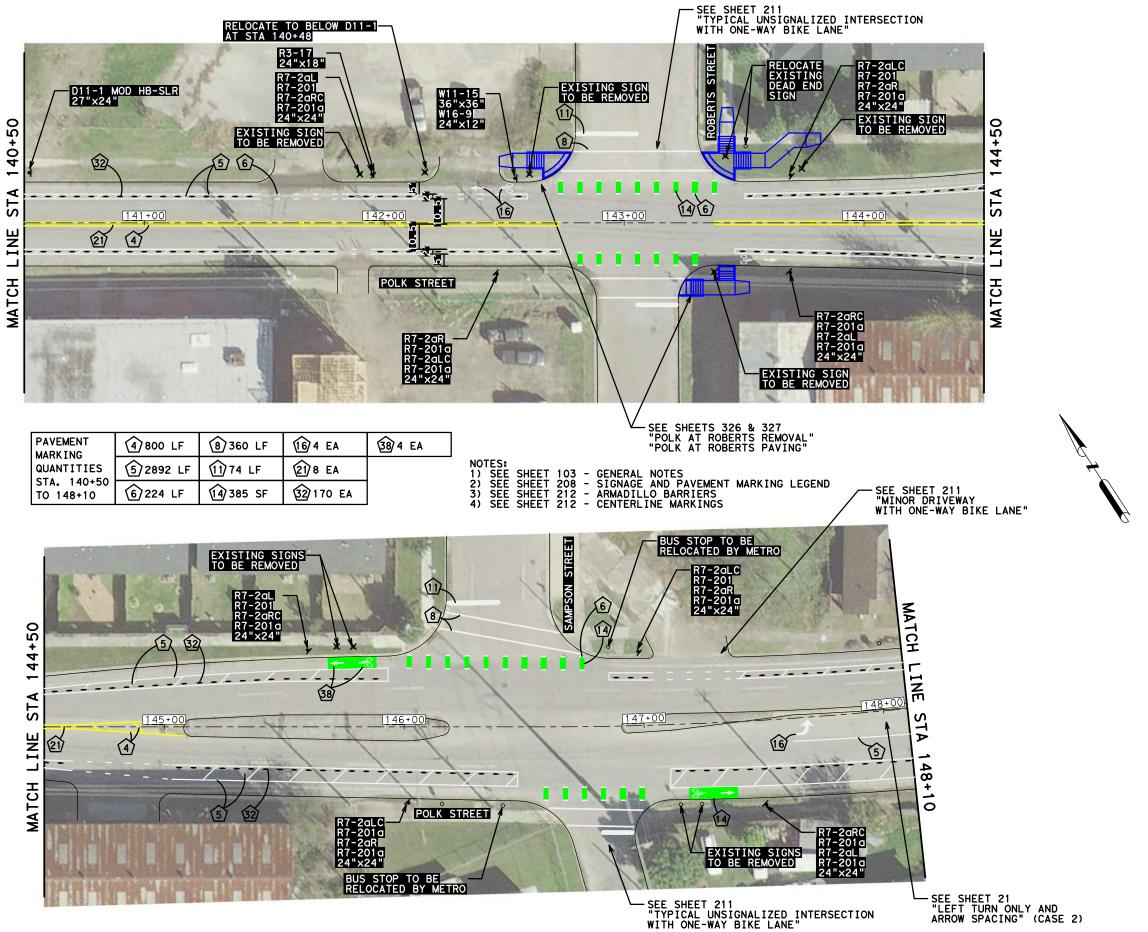





NO.	REVISIONS	DATE	NAME



801 Congress Avenue, Suite 325, Houston, TX 77002 TEL (713) 270-8145/FAX (281) 809-0807 TBPE Registration No. F-3158




PROJECT TITLE:						
	LK STREET ON-STREET BIKE	WAY				
DRAWN BY:	SHEET DESCRIPTION:					
GB	SIGNING & PAVEMENT MARI	KING LAYOUT				
CK'D BY:						
JL	SHEET 4 OF 8					
SCALE: 1"=40'						
DATE:	APPROVED BY:					
4/12/2019						
•		SHEET NO:				
		203				

PAVEMENT MARKING	4 550 LF	√7 4 EA	14) 500 SF	32) 66 EA	43) 48 SF
QUANTITIES	(5)1460 LF	8 600 LF	16)6 EA	36) 2 EA	44 30 LF
STA. 148+10 TO 152+50	€ 80 LF	11) 130 LF	21)9 EA	38) 12 EA	45) 33 LF

NOTES:
1) SEE SHEET 103 - GENERAL NOTES
2) SEE SHEET 208 - SIGNAGE AND PAVEMENT MARKING LEGEND
3) SEE SHEET 212 - ARMADILLO BARRIERS
4) SEE SHEET 212 - CENTERLINE MARKINGS



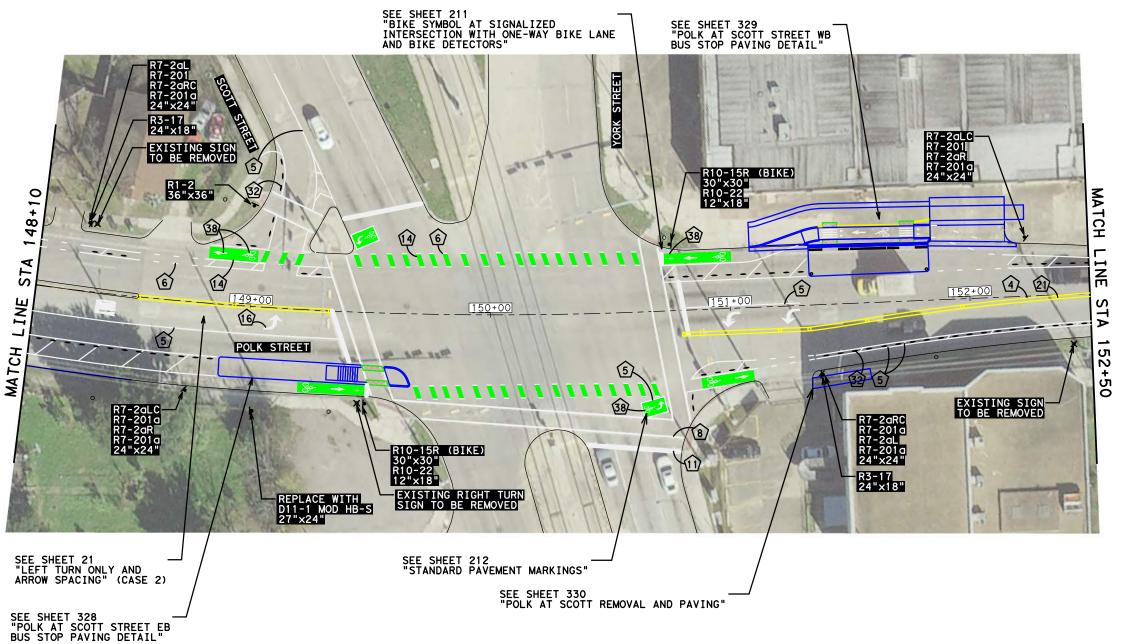





NO.	REVISIONS	DATE	NAME




801 Congress Avenue, Suite 325, Houston, TX 77002 TEL (713) 270-8145/FAX (281) 809-0807 TBPE Registration No. F-3158



HARRIS COUNTY ENGINEERING DEPARTMENT

PROJECT TITLE:
POLK STREET ON—STREET BIKEWAY
DRAWN BY: SHEET DESCRIPTION:
GB SIGNING & PAVEMENT MARKING LAYOUT
CK'D BY:
JL SHEET 5 OF 8

SCALE:
1"=40'
DATE:
4/12/2019
SHEET NO:
204

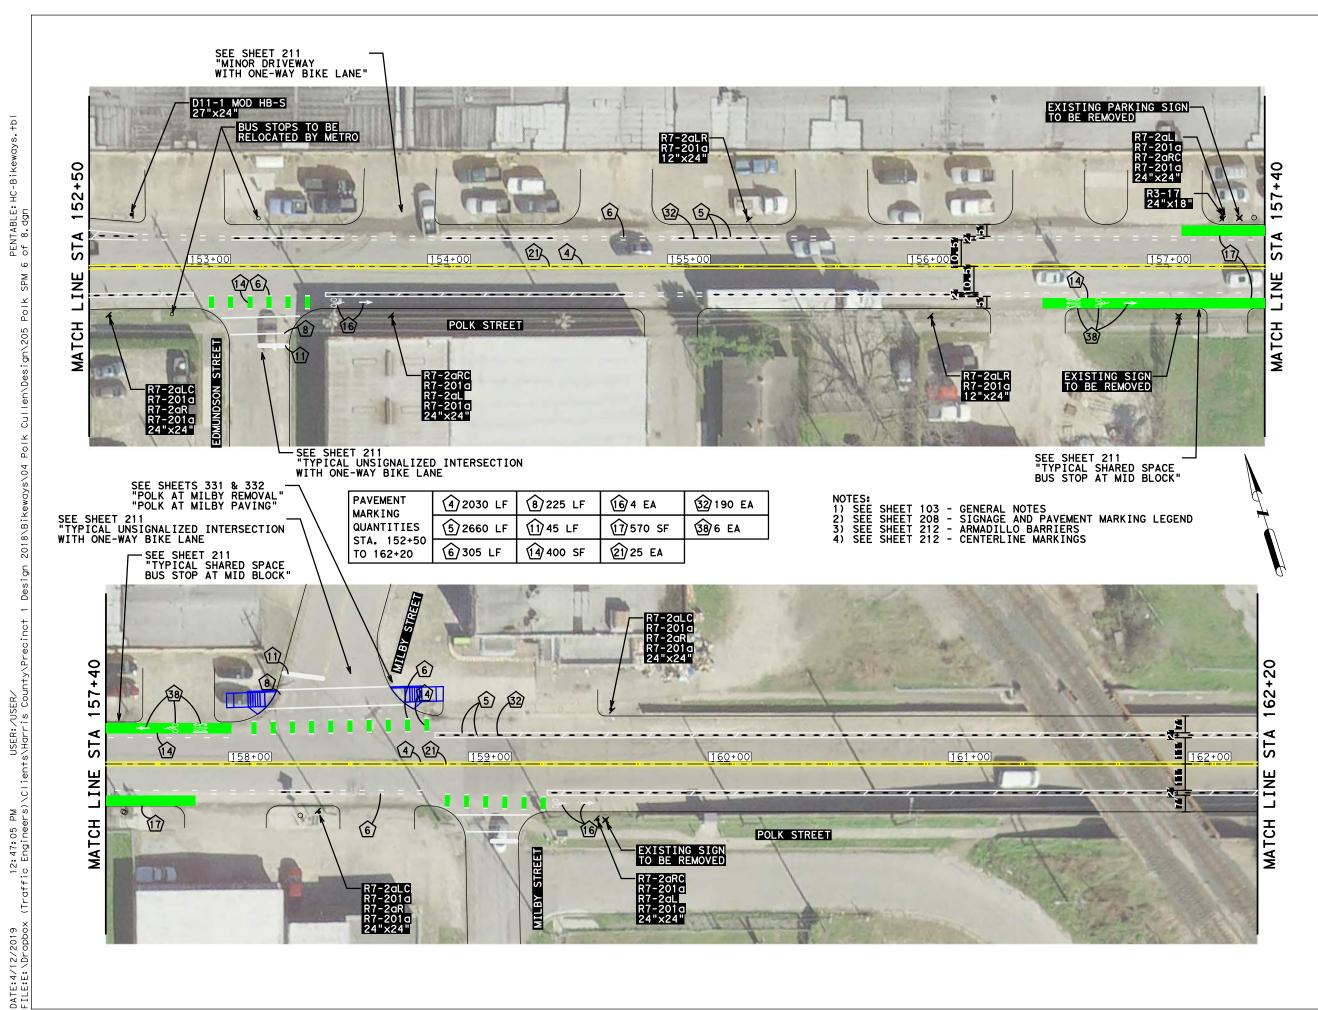





NO.	REVISIONS	DATE	NAME



TEL (713) 270-8145/FAX (281) 809-0807 TBPE Registration No. F-3158



HARRIS COUNTY ENGINEERING DEPARTMENT

PROJECT TITLE:
POLK STREET ON—STREET BIKEWAY

DRAWN BY: SHEET DESCRIPTION:
GB SIGNING & PAVEMENT MARKING LAYOUT

CK'D BY:
JL SHEET 6 OF 8

SCALE:
1"=40'


DATE: APPROVED BY:
4/12/2019

SHEET NO:
205

PAVEMENT MARKING QUANTITIES STA. 162+20 TO 167+10	4 980 LF	8 46 LF	16/4 EA
	⑤ 1373 LF	11)12 LF	21)12 EA
	⑥ 176 LF	14)66 SF	32)106 EA

NOTES:
1) SEE SHEET 103 - GENERAL NOTES
2) SEE SHEET 208 - SIGNAGE AND PAVEMENT MARKING LEGEND
3) SEE SHEET 212 - ARMADILLO BARRIERS
4) SEE SHEET 212 - CENTERLINE MARKINGS



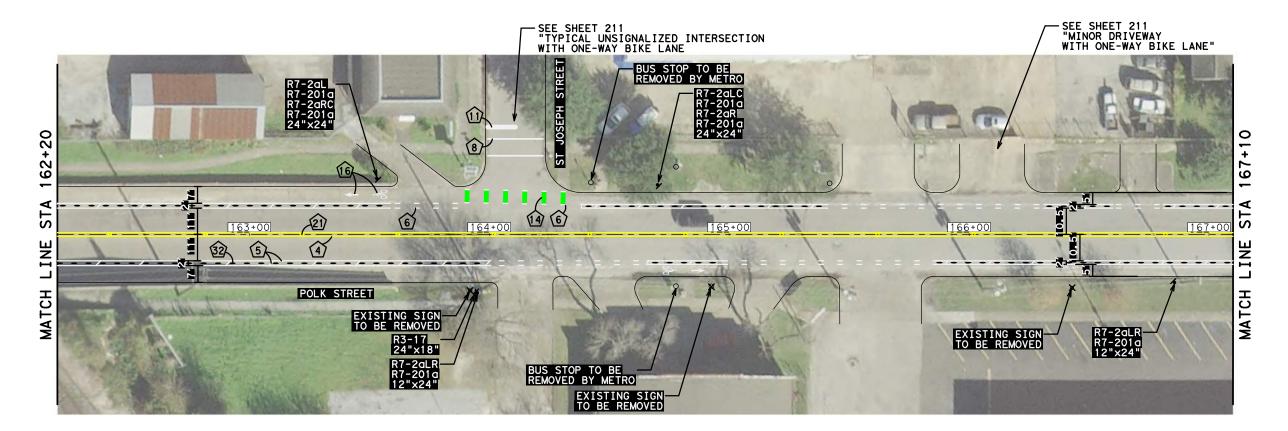






NO.	REVISIONS	DATE	NAME




801 Congress Avenue, Suite 325, Houston, TX 77002 TEL (713) 270-8145/FAX (281) 809-0807 TBPE Registration No. F-3158




LINGIIN	ILLKING DEPAR	IVILIVI
ROJECT TITL		
	LK STREET ON-STREET BIKE	.WAY
RAWN BY:	SHEET DESCRIPTION:	
GB	SIGNING & PAVEMENT MAR	KING LAYOUT
CK'D BY:		
JL	SHEET 7 OF 8	
SCALE:		
1"=40'		
ATE:	APPROVED BY:	
4/12/2019		
		SHEET NO:
		206

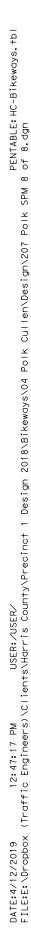

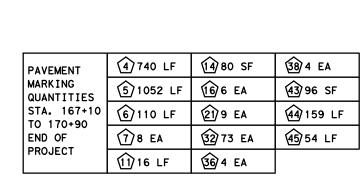

1) SEE SHEET 103 - GENERAL NOTES
2) SEE SHEET 208 - SIGNAGE AND PAVEMENT MARKING LEGEND
3) SEE SHEET 212 - ARMADILLO BARRIERS
4) SEE SHEET 212 - CENTERLINE MARKINGS

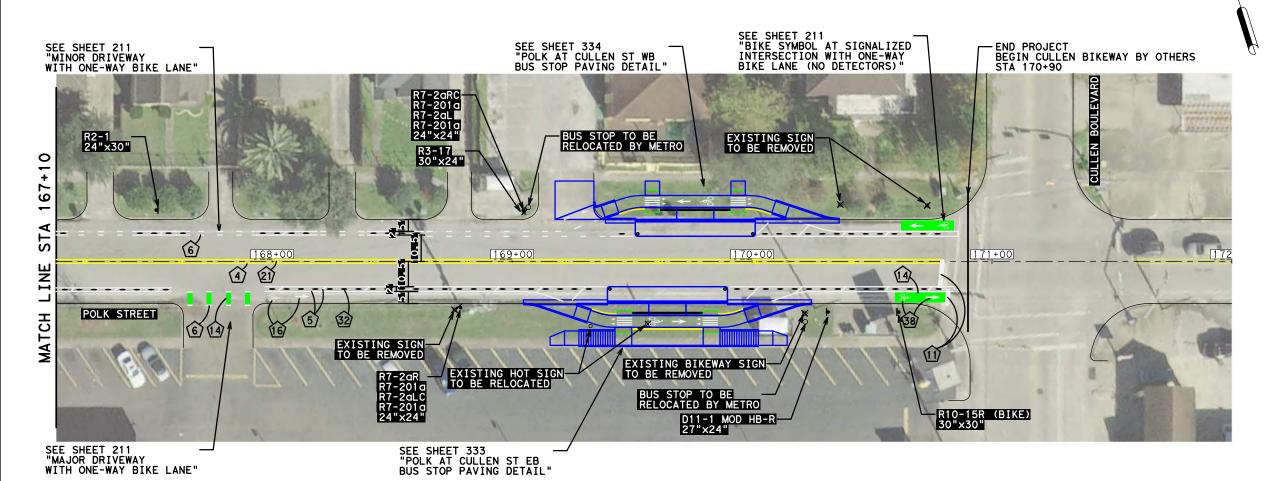





NO.	REVISIONS	DATE	NAME



801 Congress Avenue, Suite 325, Houston, TX 77002

TEL (713) 270-8145/FAX (281) 809-0807

TBPE Registration No. F-3158



LINGIIN	CERING DEPAR	.	
PROJECT TITL	E:		
	LK STREET ON-STREET BIKE	WAY	
DRAWN BY:	SHEET DESCRIPTION:		
GB	SIGNING & PAVEMENT MARI	KING LAYOUT	
CK'D BY:			
JL	SHEET 8 OF 8		
SCALE:			
1"=40'			
DATE:	APPROVED BY:		
4/12/2019			
		SHEET NO:	
		207	



R10-15L(BIKE)(MOD) 30x30 SEE DETAIL SHEET 222



R10-15R(BIKE)(MOD) 30x30 SEE DETAIL SHEET 222



R1 - 636x12



R4 - 436x30



R4-11 30x30



R3-17 30x24



R5-1 36x36



R5-1a 36x24



R10-10b 18X24



R7-2aL R7-201a 12x24



R7-2aRR7-201a



R7-2aLR





R7-2aRC



LEFT ON **GREEN** ARROW ONLY

R10-5L 30X36



W11-15 36x36



W11-1

30x30

WAY

R5-1b

12x18

R2 - 124X30



D11-1 (MOD)24x27 SEE DETAIL SHEET 209



R1-5L (COH MOD) 36x36 SEE DETAIL SHEET 222



12x24



R7-201a 12x24



R7-2aLC R7-201a 12x24



R7-201a 12x24

<u>PR</u> NG LEGEND

ROPOSED SIGNING & PAVEMENT MARKIN
^
1) TYPE I - 4" BROKEN WHITE
2) TYPE I - 4" SOLID WHITE
3) TYPE I - 4" BROKEN YELLOW
TYPE I - 4" SOLID YELLOW
5 TYPE I - 6" SOLID WHITE
6 TYPE I - 6" GUIDE WHITE
7) TYPE I - 8" YIELD TRIANGLES WHITE
8 TYPE I - 12" SOLID WHITE
1) TYPE I - 4" BROKEN WHITE 2) TYPE I - 4" SOLID WHITE 3) TYPE I - 4" BROKEN YELLOW 4) TYPE I - 4" SOLID YELLOW 5) TYPE I - 6" SOLID WHITE 6) TYPE I - 6" GUIDE WHITE 7) TYPE I - 8" YIELD TRIANGLES WHITE 8) TYPE I - 12" SOLID WHITE 9) TYPE I - 12" SOLID WHITE 10) TYPE I - 18" YIELD TRIANGLES WHITE 11) TYPE I - 24" SOLID WHITE 12) TYPE I - 24" SOLID WHITE 13) TYPE I - 36" YIELD TRIANGLES WHITE 14) REFLECTIVE PM TY C PREFORM SOLID GREEN
10) TYPE I - 18" YIELD TRIANGLES WHITE
1) TYPE I - 24" SOLID WHITE
12) TYPE I - 24" SOLID YELLOW
13) TYPE I - 36" YIELD TRIANGLES WHITE
14) REFLECTIVE PM TY C PREFORM SOLID GREEN
15) TYPE II - MEDIAN NOSE CURR YELLOW

(15) TYPE II - MEDIAN NOSE CURB YELLOW (6) TYPE I - WHITE WORD, SYMBOL, ARROW, RR CROSSING OR SHARROW

METHYL METHACRYLATE PAVEMENT MARKING EPOXY PAVEMENT MARKING

RESIN BONDED AGGREGATE SURFACING

REFL PAV MRKR - TYPE I-C REFL PAV MRKR - TYPE II-A-A

REFL PAV MRKR - TYPE II-C-R

TRAFFIC BUTTON WHITE

TRAFFIC BUTTON WHITE (METRO BUTTONS)

TRAFFIC BUTTON YELLOW

TRAFFIC BUTTON YELLOW (METRO BUTTONS)

RUBBER SPEED CUSHION

ASPHALT SPEED CUSHION - ASPHALT PAVEMENT

ASPHALT SPEED CUSHION - CONCRETE PAVEMENT

CHANNELIZATION DEVICE SEPARATORS

FLEXIBLE POST DELINEATORS

CYCLE LANE SEPARATOR "ARMADILLO"

COLLAPSABLE BOLLARD

CONCRETE PLANTER

OMITTED

FLEXIBLE DELINEATOR POST

OMITTED

REFLECTIVE PM TY C PREFORM SYMBOL (WHITE/GREEN)

OMITTED

OMITTED

TYPE I - 6" SOLID YELLOW

TYPE I - 6" GUIDE YELLOW

CAST-IN-PLACE DETECTABLE WARNING MATERIAL

SURFACE-APPLIED DIRECTIONAL TACTILE MATERIAL

PEDESTRIAN RAILING

PROPOSED RAISED MARKERS

PROPOSED BUTTONS

PROPOSED PAVEMENT MARKINGS

EXISTING SIGN (TO REMAIN)

EXISTING SIGN (TO BE REMOVED)

PROPOSED SIGN

PROPOSED CURB AND PAVEMENT REPAIR

PROPOSED CURB AND CONCRETE

— PROPOSED REMOVAL



NO.	REVISIONS	DATE	NAME



801 Congress Avenue, Suite 325, Houston, TX 77002 TEL (713) 270-8145/FAX (281) 809-0807



	ROJECT TITLE:				
	LK STREET ON-STREET BIKE	EWAY			
RAWN BY:	SHEET DESCRIPTION:				
GB	SIGNING AND PAVEMENT	MARKING			
K'D BY:					
JL	LEGEND				
CALE:					
NONE					
ATE:	APPROVED BY:				
4/12/2019					
•		SHEET NO:			
		208			












[BIKE] C; [ROUTE] C 90% spacing;


Double Headed Arrow 1 - 12.0" 0°;









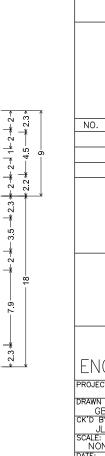

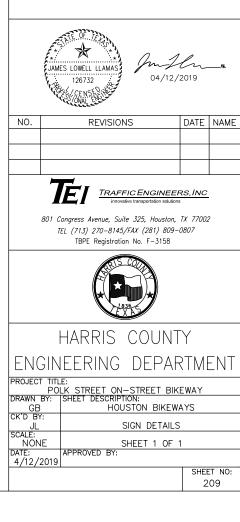


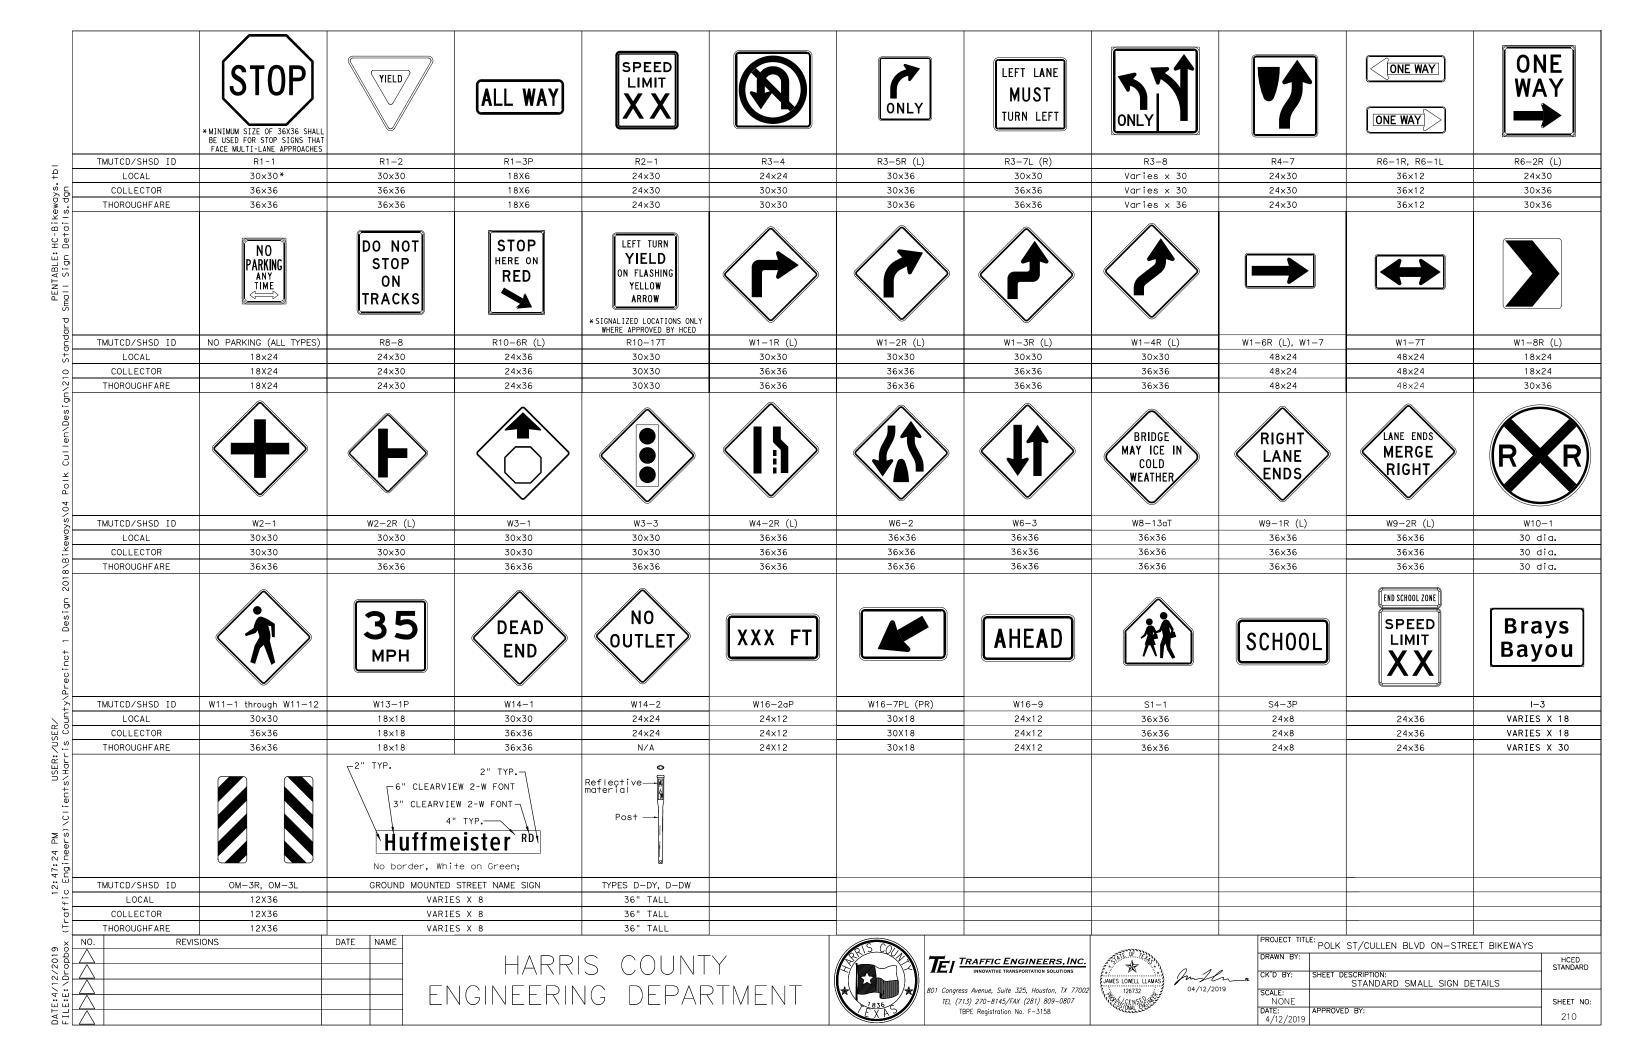

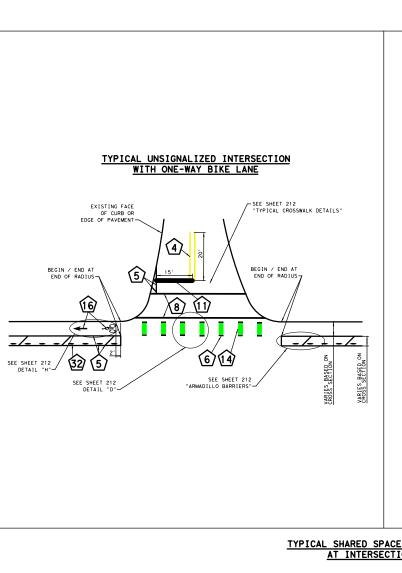


PENTABLE: HC-Bikeways. †bl

DATE:4/12/2019 FILE:E:\Dropbox

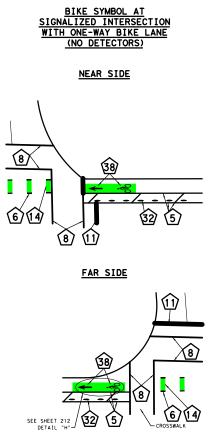

MINOR DRIVEWAY WITH ONE-WAY BIKE LANE EXISTING FACE OF CURB OR EDGE OF PAVEMENT-<u></u> SEE SHEET 212-"ARMADILLO BARRIERS" BEGIN / END AT \ MAJOR DRIVEWAY WITH ONE-WAY BIKE LANE

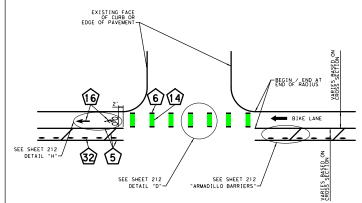



NO.	REVISIONS	DATE	NAME

TRAFFIC ENGINEERS, INC innovative transportation solutions


801 Congress Avenue, Suite 325, Houston, TX 77002 TEL (713) 270-8145/FAX (281) 809-0807 TBPE Registration No. F-3158




HARRIS COUNTY ENGINEERING DEPARTMENT

LINGINLLINING DLI ANTIVILINI				
ROJECT TITLE:				
	LK STREET ON-STREET BIKEWAY			
RAWN BY:	SHEET DESCRIPTION:			
GB	SIGNING & PAVEMENT MARKING			
CK'D BY:				
JL	DETAIL			
CALE:				
NONE	SHEET 1 OF 4			
ATE:	APPROVED BY:			
4/12/2019				
	SHEET NO:			
	011			

TYPICAL SHARED SPACE BUS STOP AT INTERSECTION

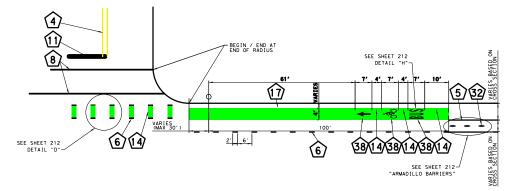


TYPICAL SHARED SPACE BUS STOP AT MID BLOCK

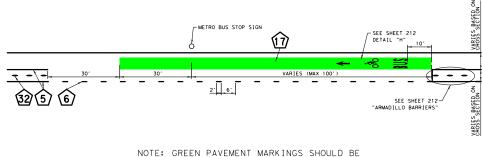


ADJACENT TO THE BUFFER LANE LINE


BIKE SYMBOL AT SIGNALIZED INTERSECTION WITH ONE-WAY BIKE LANE AND BIKE DETECTORS

NEAR SIDE

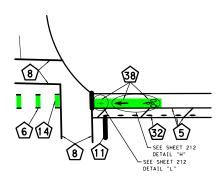

FAR SIDE

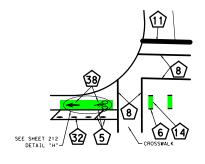

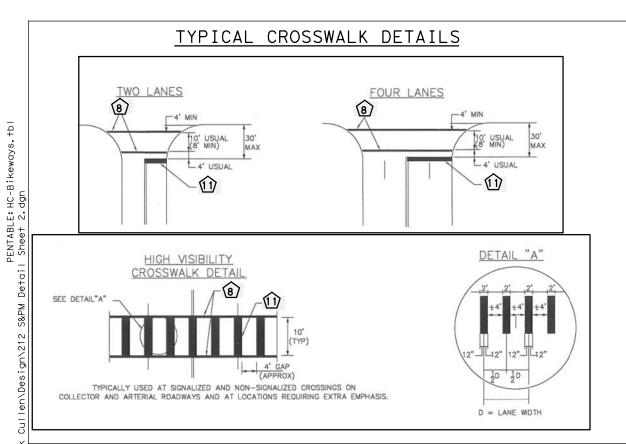

ARMADILLO BARRIERS

SECTION A

3" MAX 7

35 MAX-25 MIN

SURFACE


REFLECTIVE RAISED PAVEMENT MARKERS

REFLECTORIZED SURFACE

ROADWAY _

SURFACE

TYPE 1-C

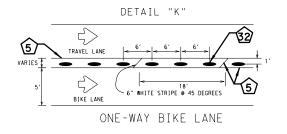


STANDARD PAVEMENT MARKINGS

SECTION B


TYPE II-A-A OR II-R-C


ADHESIVE

14

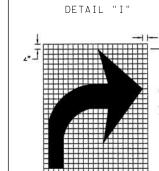

6.0' (±.5') 4"> |

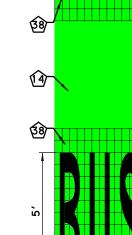

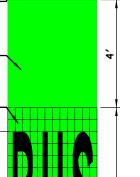

DETAIL "H"



REVISIONS DATE NAME NO.

TRAFFIC ENGINEERS, INC

801 Congress Avenue, Suite 325, Houston, TX 77002 TEL (713) 270-8145/FAX (281) 809-0807




HARRIS COUNTY ENGINEERING DEPARTMENT


PROJECT TITL	PROJECT TITLE:				
	LK STREET ON-STREET BIKE	WAY			
DRAWN BY:	SHEET DESCRIPTION:				
GB	SIGNING & PAVEMENT	MARKING			
CK'D BY:					
JL	DETAIL				
SCALE:					
NONE	SHEET 2 OF 4				
DATE:	APPROVED BY:				
4/12/2019					
		SHEET NO:			

212

CENTERLINE MARKINGS

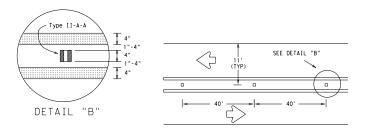



BIKE LANE CONFLICT MARKINGS

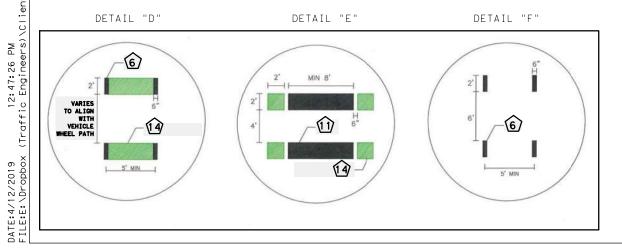


NOTE:

- 6 EDGE LINES ARE IN LINE WITH BIKE LANE EDGE
- (14) RUNS BETWEEN THE VEHICLE WHEEL PATH

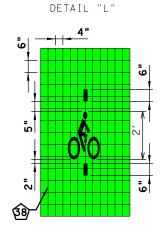

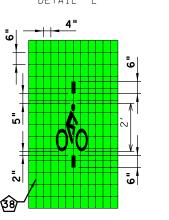



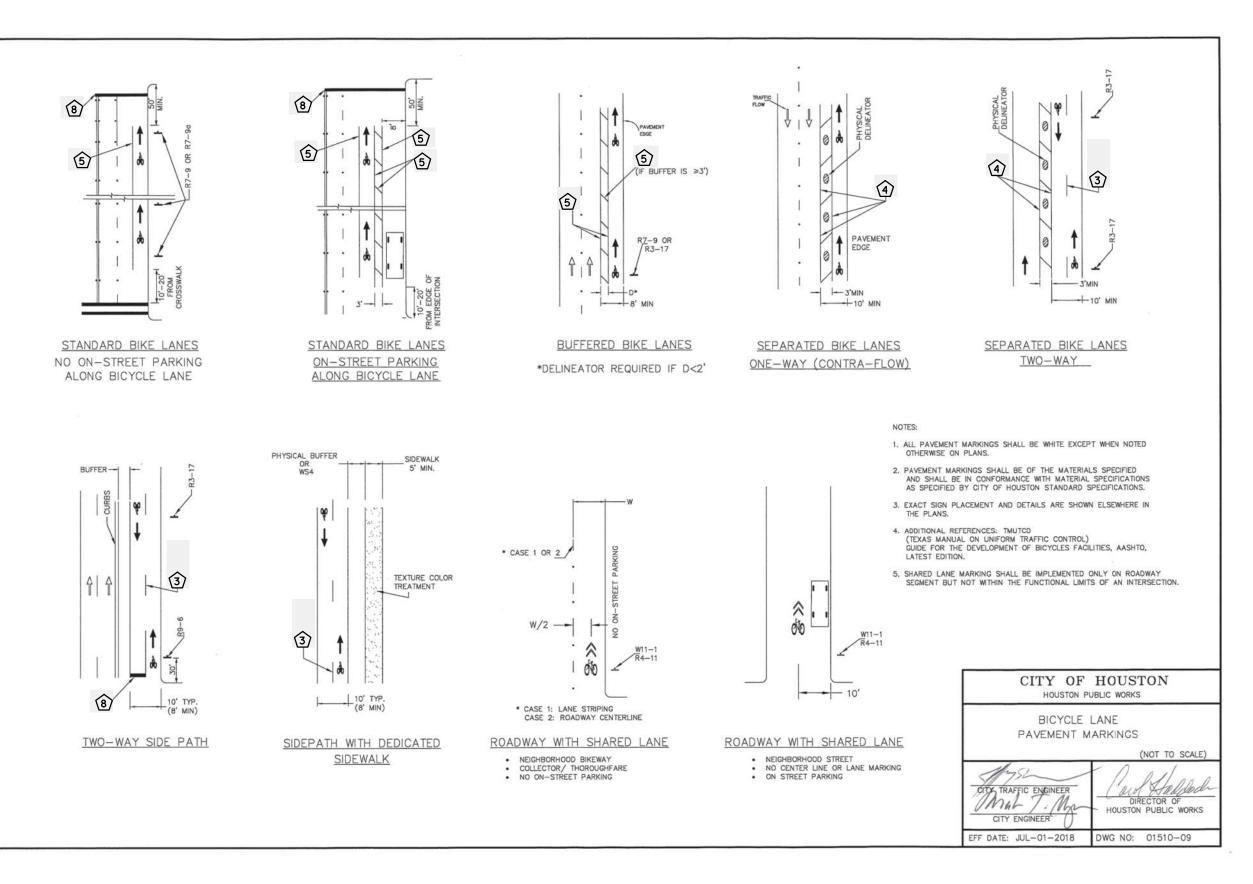



04/12/2019

NO. REVISIONS DATE NAME




801 Congress Avenue, Suite 325, Houston, TX 77002 TEL (713) 270-8145/FAX (281) 809-0807 TBPE Registration No. F-3158



HARRIS COUNTY ENGINEERING DEPARTMENT

	ROJECT TITLE:				
	LK STREET ON-STREET BIKEWAY				
RAWN BY:	SHEET DESCRIPTION:				
GB	SIGNING & PAVEMENT MARKING				
CK'D BY:					
JL	DETAIL				
CALE:					
NONE	SHEET 3 OF 4				
ATE:	APPROVED BY:				
4/12/2019					
	SHEET NO:				

213

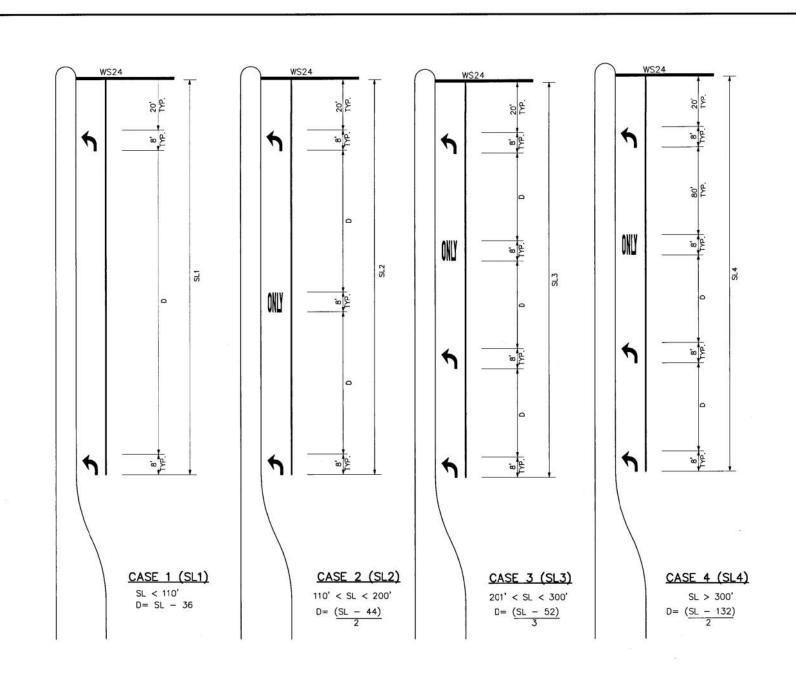

KEY (FOR TURN LANES ONLY):

- SL STORAGE LENGTH (FEET)
- D DISTANCE BETWEEN ARROWS AND/OR WORDS (FEET)

GENERAL NOTES:

- 1. ALL CASES AND DETAILS ALSO APPLY TO RIGHT-TURN LANES.
- 2. FOR DUAL-TURN LANES, DIMENSIONS SHALL BE THE SAME FOR
- 3. SL DIMENSION IS FROM BACK OF STOP LINE TO END OF TURN LANE. NOTE: DO NOT INCLUDE TAPER LENGTH.
- PAVEMENT ARROWS AND "ONLY" LEGEND MARKINGS ARE TYPICALLY USED AT ALL SIGNALIZED INTERSECTIONS AND AT ALL UNSIGNALIZED INTERSECTIONS THAT HAVE TURN LANES.
- 5. MINIMUM SL= 100'. SL MAY BE LESS THAN 100 FEET ONLY BY APPROVAL OF THE CITY TRAFFIC ENGINEER.

* JAMES LOWELL LLAMAS 126732

DATE NAME NO. REVISIONS

04/12/2019



801 Congress Avenue, Suite 325, Houston, TX 77002 TEL (713) 270-8145/FAX (281) 809-0807 TBPE Registration No. F-3158



HARRIS COUNTY ENGINEERING DEPARTMENT

PROJECT TITLE:
POLK STREET ON—STREET BIKEWAY
DRAWN BY: SHEET DESCRIPTION:
GB SIGNING & PAVEMENT MARKING SCALE: NONE DATE: SHEET 4 OF 4
APPROVED BY:

ENGINEERING

DEPARTMENT OF PUBLIC WORKS AND ENGINEERING LEFT/RIGHT-TURN "ONLY" AND ARROW SPACING

CITY OF HOUSTON

WORKS DWG NO:

SHEET NO: 214





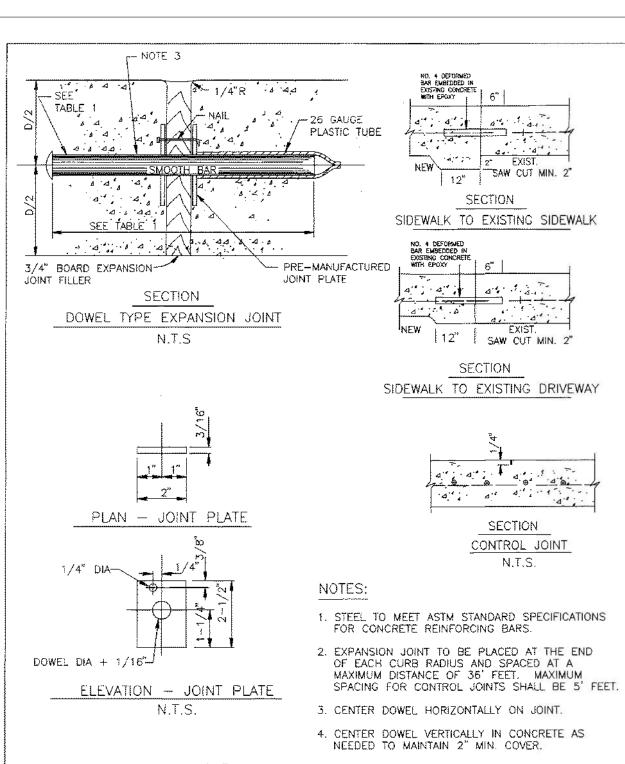


TABLE 1

PAVEMENT	DOWEL	SIZES AND SP	ACINGS
THICKNESS (IN)	DIAMETER (IN)	LENGTH (IN)	SPACING (IN)
4 1/2	1/2	18	12
5	1/2	18	12
6	3/4	18	12
7	1	18	12

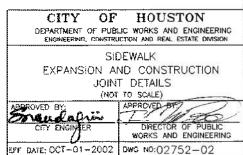

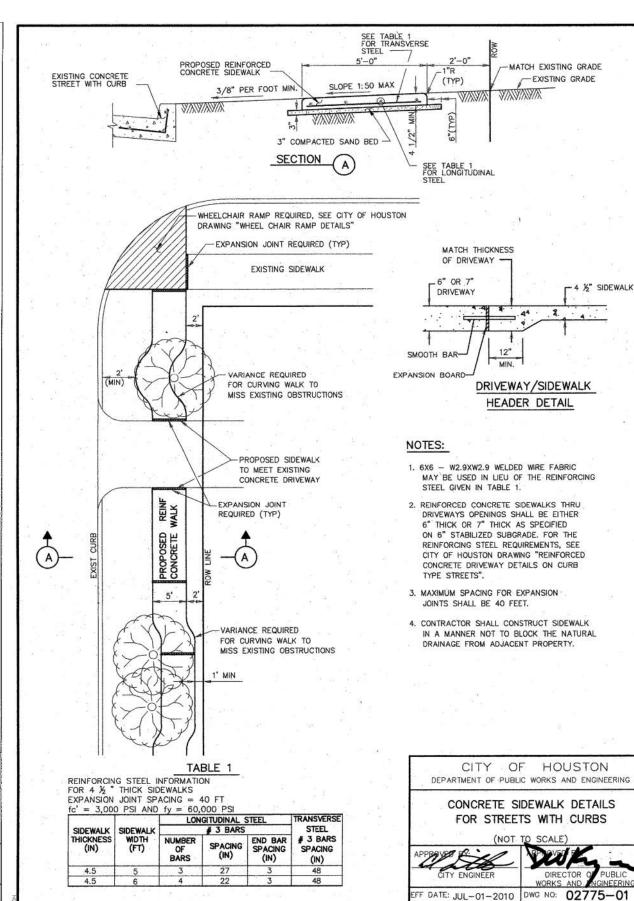

 \Rightarrow JAMES LOWELL LLAMAS 04/12/2019 126732

- 4 ½" SIDEWALK

REVISIONS DATE NAME

NO.

TRAFFIC ENGINEERS, INC


801 Congress Avenue, Suite 325, Houston, TX 77002 TEL (713) 270-8145/FAX (281) 809-0807 TBPE Registration No. F-3158





HARRIS COUNTY engineering departmen⁻

PROJECT TITLE: POLK STREET ON-STREET BIKEWAY
BY: SHEET DESCRIPTION: DRAWN BY: SIDEWALK DETAILS NONE APPROVED BY SHEET NO:

215

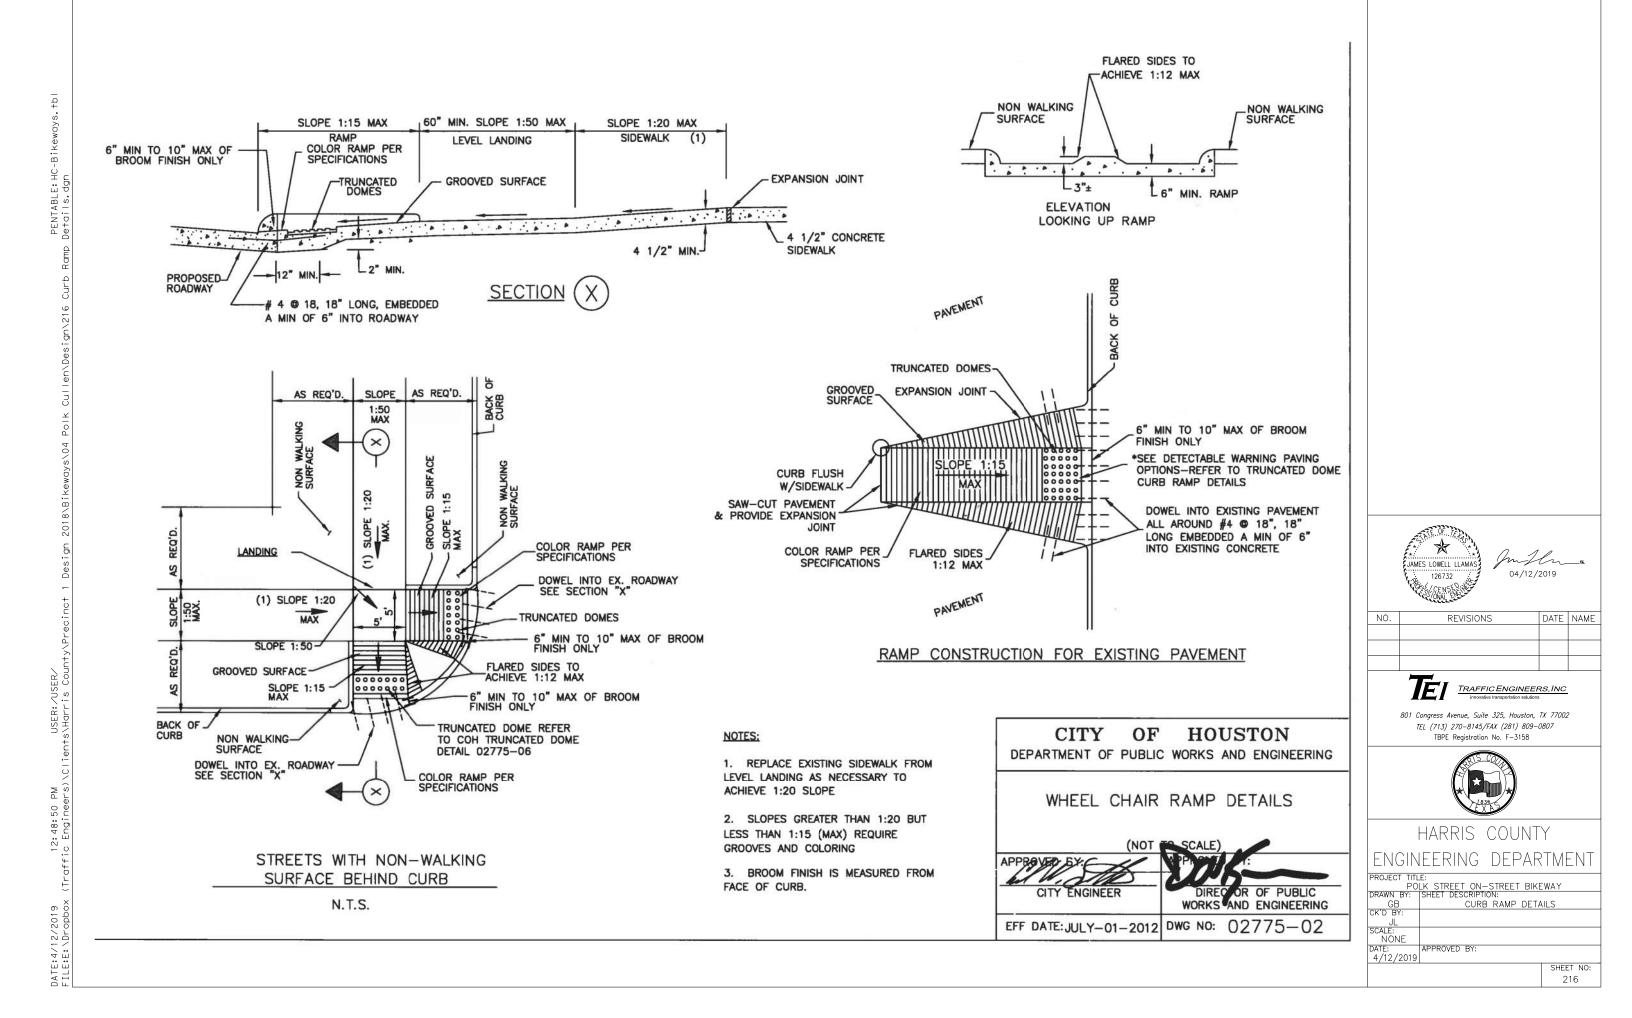

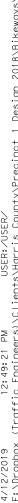

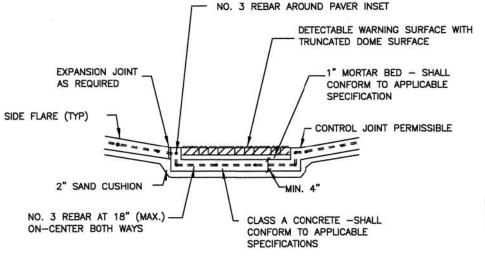

SIDE FLARE (TYPICAL) DETECTABLE WARNING -FACE OF CURB SURFACE WITH TRUNCATED DOME SURFACE 6" MIN TO 10" MAX BROOM FINISH

DETECTABLE WARNING SURFACE


GENERAL NOTES

- 1. FURNISH DETECTABLE WARNING SURFACE UNITS MEETING ALL REQUIREMENTS OF ASTM C-936, C-33. LAY IN A TWO BY TWO UNIT BASKET WEAVE PATTERN OR AS DIRECTED.
- 2. LAY FULL-SIZE UNITS FIRST FOLLOWED BY CLOSURE UNITS CONSISTING OF AT LEAST 25 PERCENT OF A FULL UNIT. CUT DETECTABLE WARNING SURFACE UNITS USING A POWER SAW.

1. FURNISH REQUIREMENTS OF ADAAG (MARCH 2003).


PAVER SECTION (A)


2. OTHER MATERIALS MAY BE USED IF APPROVED BY THE CITY ENGINEER.

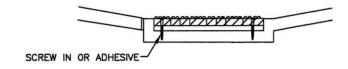

POLYMER CONCRETE

- 1. DETECTABLE WARNING TILES SHALL BE MADE OF POLYMER CONCRETE MATERIALS.
- 2. DETECTABLE WARNING TILES SHALL BE INSTALLED INTO FRESH CONCRETE (CAST-IN-PLACE) UTILIZING AN ANCHORING SYSTEM.
- 3. DETECTABLE WARNING TILES SHALL BE OF TERRACOTTA (BRICK-RED) COLOR AND COLORED THROUGHOUT TO GUARANTEE THE ADA REQUIRED COLOR CONTRAST.
- 4. DETECTABLE WARNING TILES SHALL MEET OR EXCEED THE FOLLOWING ASTM-BASED "STANDARDS" FOR CONCRETE MATERIALS:
- A. COMPRESSION STRENGTH > 12,500PSI PER ASTM C 39-04 B. WATER ABSORPTION < 0.25% PER ASTM C 97-09

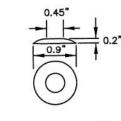

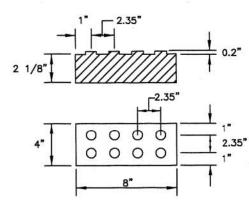

PAVER DETECTABLE WARNING SURFACE DETAIL



SURFACE (OPTIONS)

CITY TRAFFIC ENGINEER HOUSTON PUBLIC WORKS CITY ENGINEER

EFF DATE: JUL-01-2018

(NOT TO SCALE) DWG NO: 02775-07



NO.	REVISIONS	DATE	NAME




801 Congress Avenue, Suite 325, Houston, TX 77002 TEL (713) 270-8145/FAX (281) 809-0807 TBPE Registration No. F-3158



HARRIS COUNTY ENGINEERING DEPARTMENT

POLK STREET ON-STREET BIKEWAY
BY: |SHEET DESCRIPTION: DETECTABLE WARNING DETAILS SCALE: NONE APPROVED BY: SHEET NO:

217

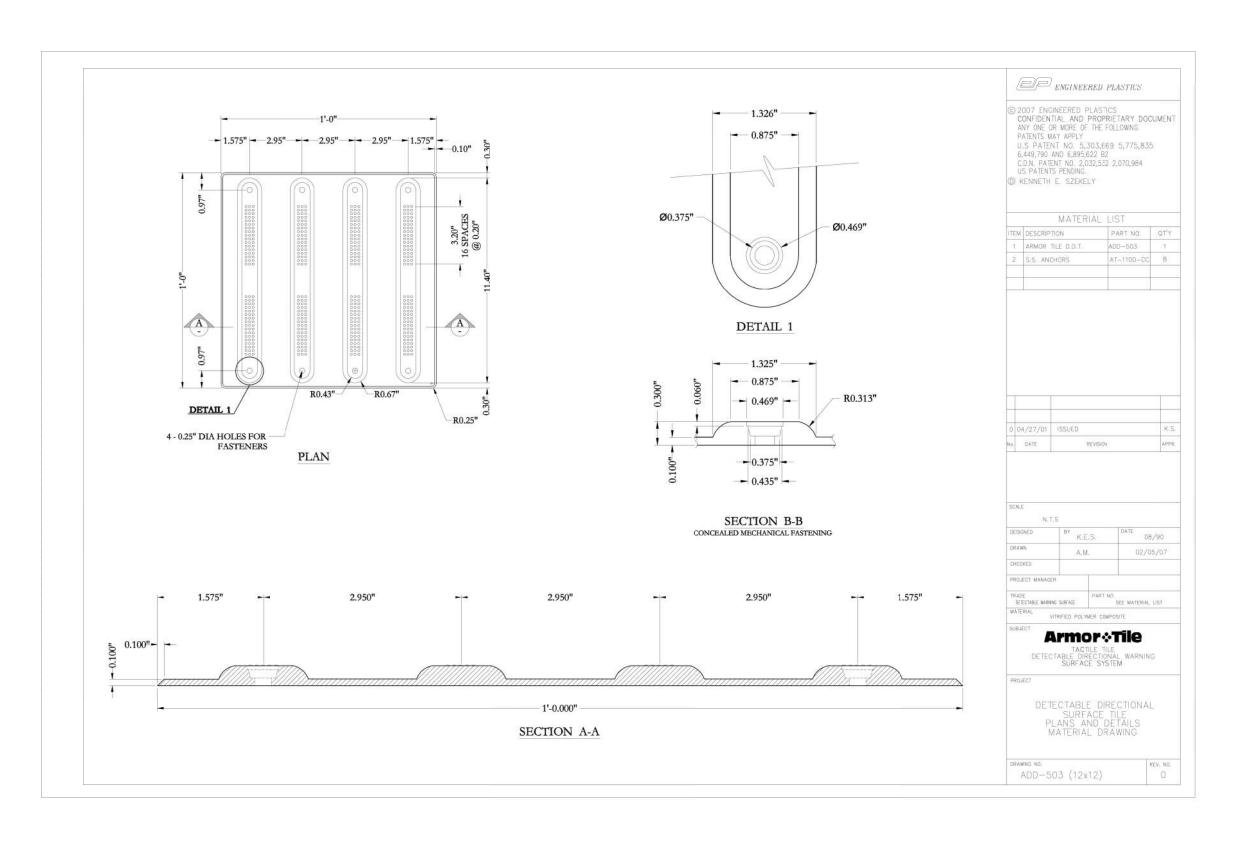





NO.	REVISIONS	DATE	NAME



801 Congress Avenue, Suite 325, Houston, TX 77002 TEL (713) 270-8145/FAX (281) 809-0807 TBPE Registration No. F-3158




PROJECT TITLE:				
	LK STREET ON-STREET BIKE	WAY		
RAWN BY:	SHEET DESCRIPTION:			
GB	DIRECTIONAL TACTILE SURF	ACE-APPLIED		
CK'D BY:				
JL	DETAIL			
SCALE:				
NONE				
DATE:	APPROVED BY:			
4/12/2019				
		SHEET NO:		
		218		

CITY OF HOUSTON

DESIGN MANUAL

Department of Public Works & Engineering

Street Paving Design Requirements

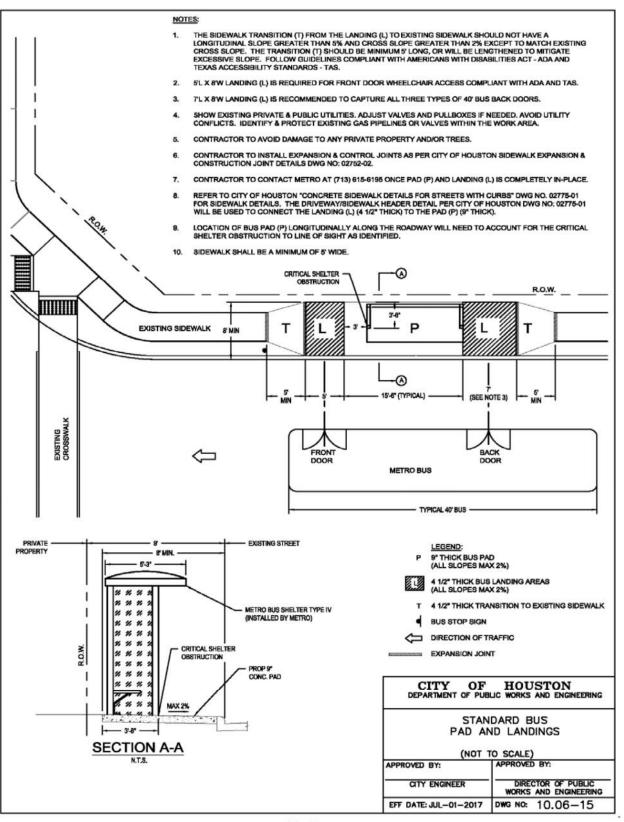

10-60 07-01-2017




NO.	REVISIONS	DATE	NAME





801 Congress Avenue, Suite 325, Houston, TX 77002 TEL (713) 270-8145/FAX (281) 809-0807 TBPE Registration No. F-3158



PROJECT TITLE:				
PO	LK STREET ON-STREET BIKE	-WAY		
DRAWN BY:	SHEET DESCRIPTION:			
GB	METRO BUS STOP D	ETAIL		
CK'D BY:				
JL	SHEET 1 OF 2			
SCALE:				
NONE				
DATE:	APPROVED BY:			
4/12/2019				
		SHEET	NO:	

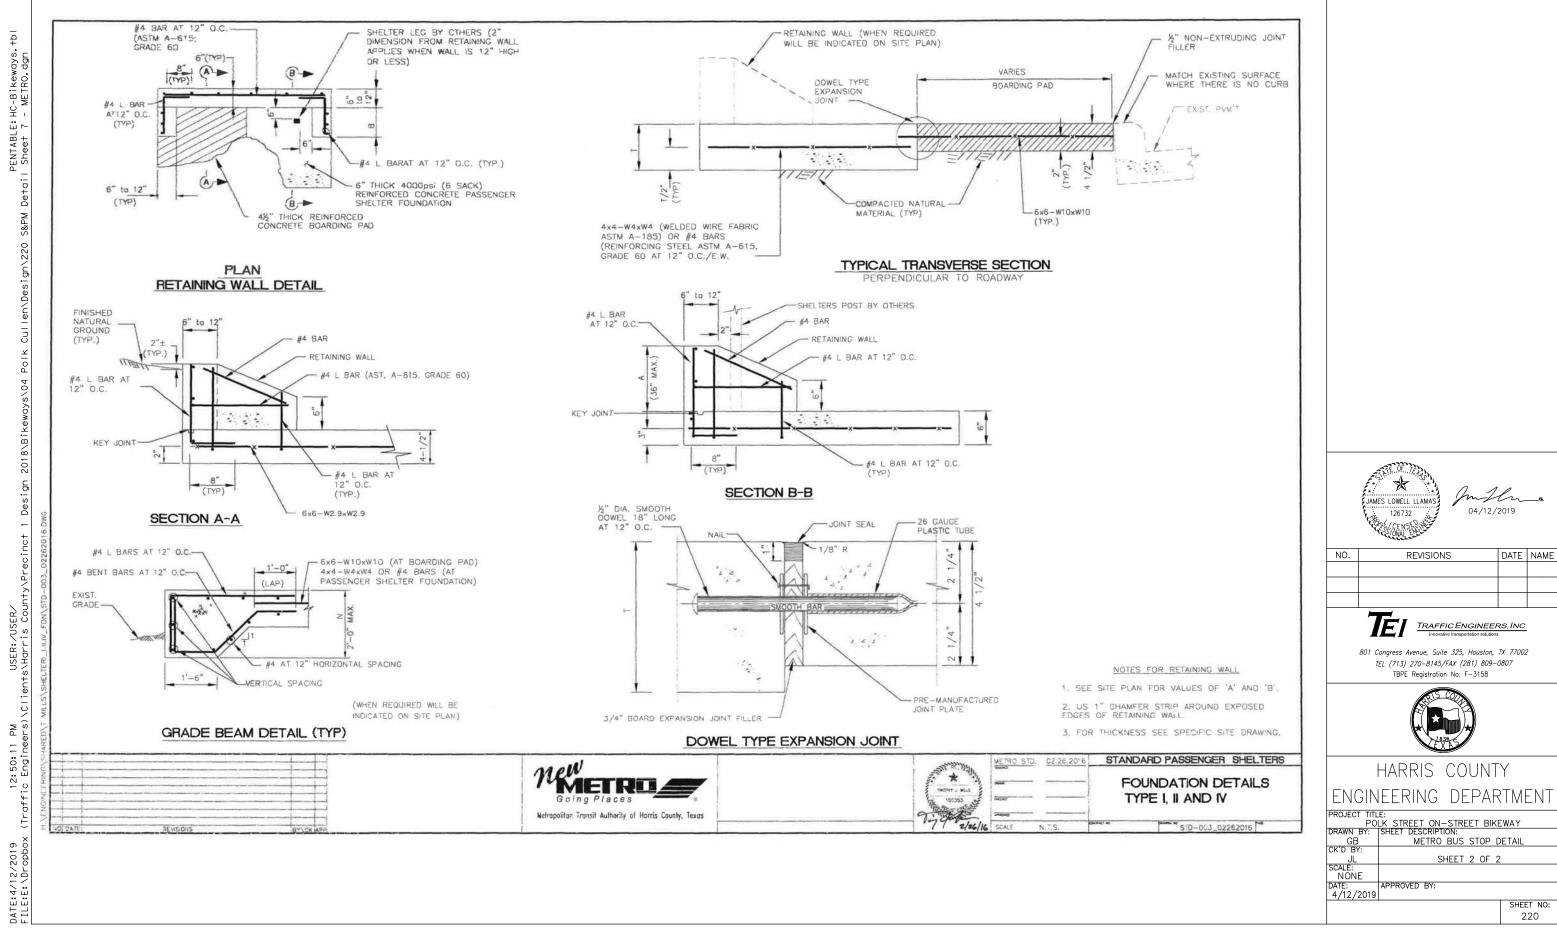

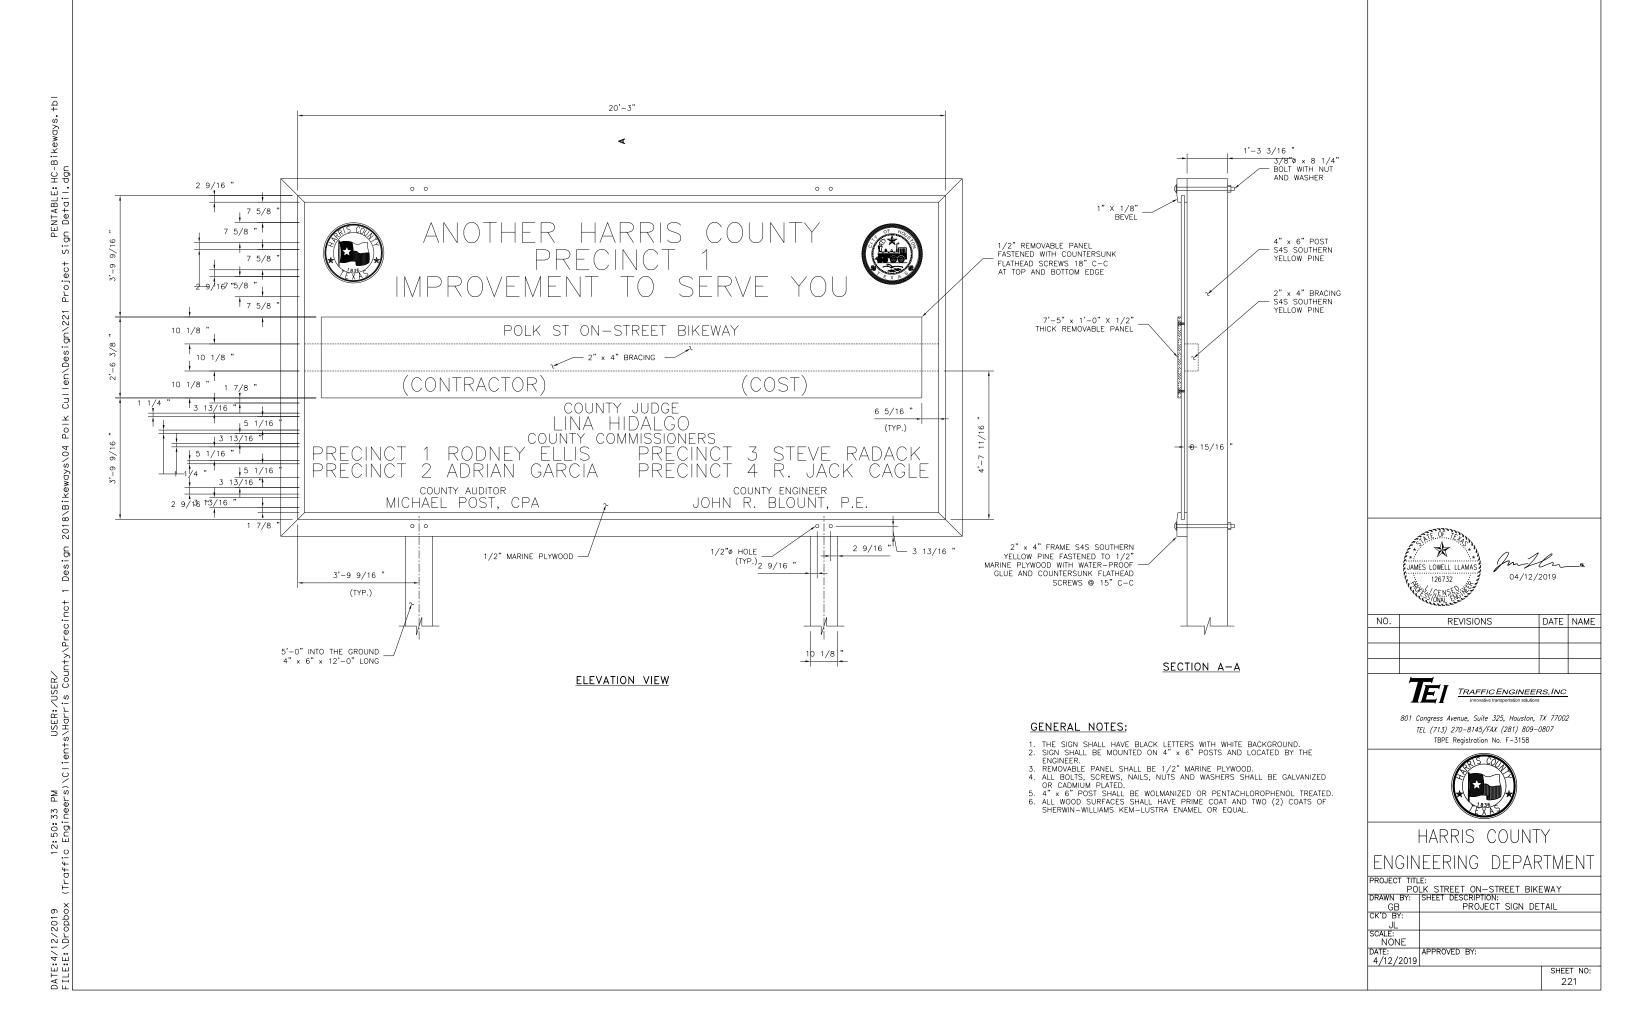

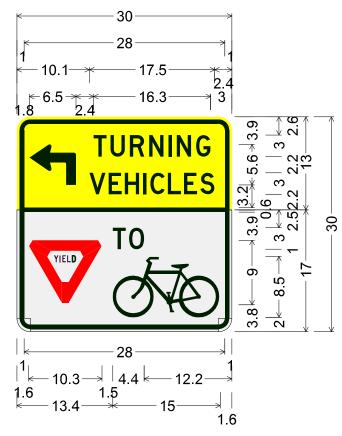

Identifier: R10-15L(BIKE) (MOD);


1.9" Radius, 0.6" Border, 0.4" Indent, Black on Yellow; 90 Deg Advance Turn Arrow Custom 6.5" X 5.7";

[TURNING] D specified length;

[VEHICLES] D specified length;

1.9" Radius, 0.6" Border, 0.4" Indent, Black on White; [TO] D specified length;

Symbol RG025;

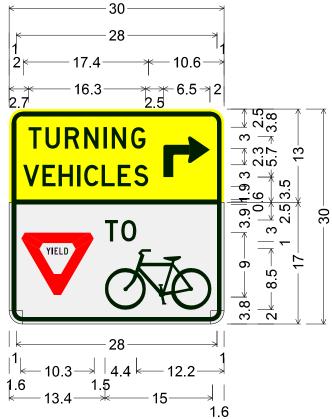

Identifier: R10-15R(BIKE)(MOD);


1.9" Radius, 0.6" Border, 0.4" Indent, Black on Yellow; [TURNING] D specified length;

[VEHICLES] D specified length;

90 Deg Advance Turn Arrow Custom 6.5" X 5.7";

1.9" Radius, 0.6" Border, 0.4" Indent, Black on White; [TO] D specified length;

Symbol RG025;

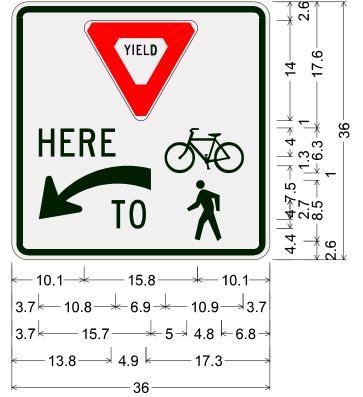

Identifier: R1-5L(BIKE)(MOD);

2.3" Radius, 0.9" Border, 0.6" Indent, Black on White; [HERE] C specified length;

[TO] C specified length;

Symbol RG025 White;



NO.	REVISIONS	DATE	NAME



801 Congress Avenue, Suite 325, Houston, TX 77002 TEL (713) 270-8145/FAX (281) 809-0807 TBPE Registration No. F-3158



HARRIS COUNTY ENGINEERING DEPARTMENT

PROJECT TITLE:
POLK STREET ON—STREET BIKEWAY

DRAWN BY: SHEET DESCRIPTION:
GB SPECIAL SIGN DETAILS

CK'D BY:
JL SHEET 1 OF 2

SCALE:
NONE

DATE:
4/12/2019

SHEET NO:
222

COLORS: LEGEND — BLACK
BACKGROUND — WHITE (RETROREFLECTIVE)



NO.	REVISIONS	DATE	NAME



801 Congress Avenue, Suite 325, Houston, TX 77002 TEL (713) 270-8145/FAX (281) 809-0807 TBPE Registration No. F-3158




PROJECT TITLE:			
POLK STREET ON-STREET BIKEWAY			
DRAWN BY:	SHEET DESCRIPTION:		
GB	SPECIAL SIGN DET	AILS	
CK'D BY:			
JL SHEET 2 OF 2			
SCALE:			
NONE			
DATE:	APPROVED BY:		
4/12/2019			
		SHEET NO:	
		223	

NO.	REVISIONS	DATE	NAME	

SHEET NO: 300

PENTABLE: HC-Bikeways. †bl Repair Plan 1 of 8. dgn 12:51:47 PM USER:/USER/ (Traffic Engineers)\Clients\Harris County\Precinct DATE:4/12/2019 FILE:E:\Dropbox

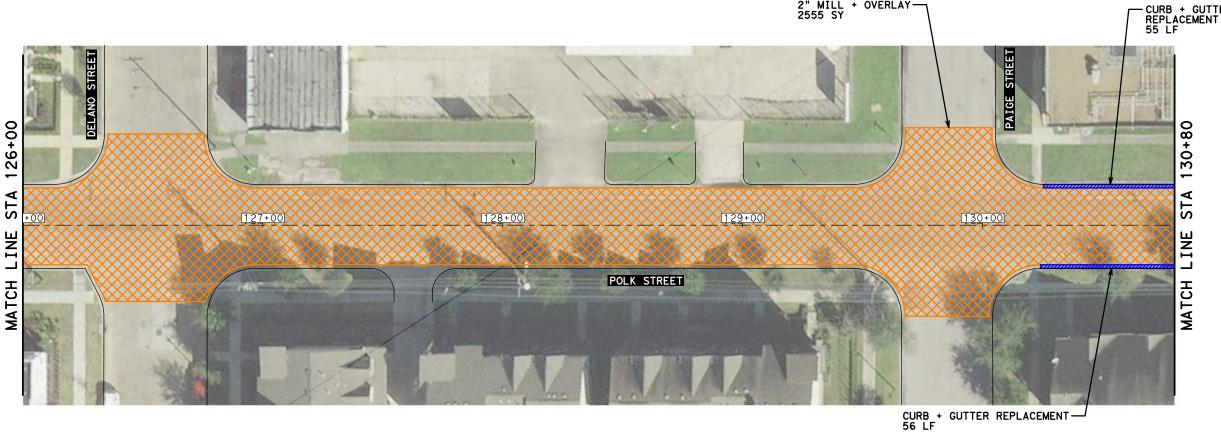






NO.	REVISIONS	DATE	NAME



801 Congress Avenue, Suite 325, Houston, TX 77002 IEL (713) 270-8145/FAX (281) 809-0807 TBPE Registration No. F-3158



, .							
PROJECT TITLE:							
POLK STREET ON-STREET BIKEWAY							
DRAWN BY:	SHEET DESCRIPTION:						
GB	PAVEMENT REPAIR + REMO	VAL LAYOUT					
CK'D BY:							
JL SHEET 2 OF 8							
SCALE:							
1"=40'							
DATE:	APPROVED BY:						
4/12/2019							
		SHEET NO:					
		.301					

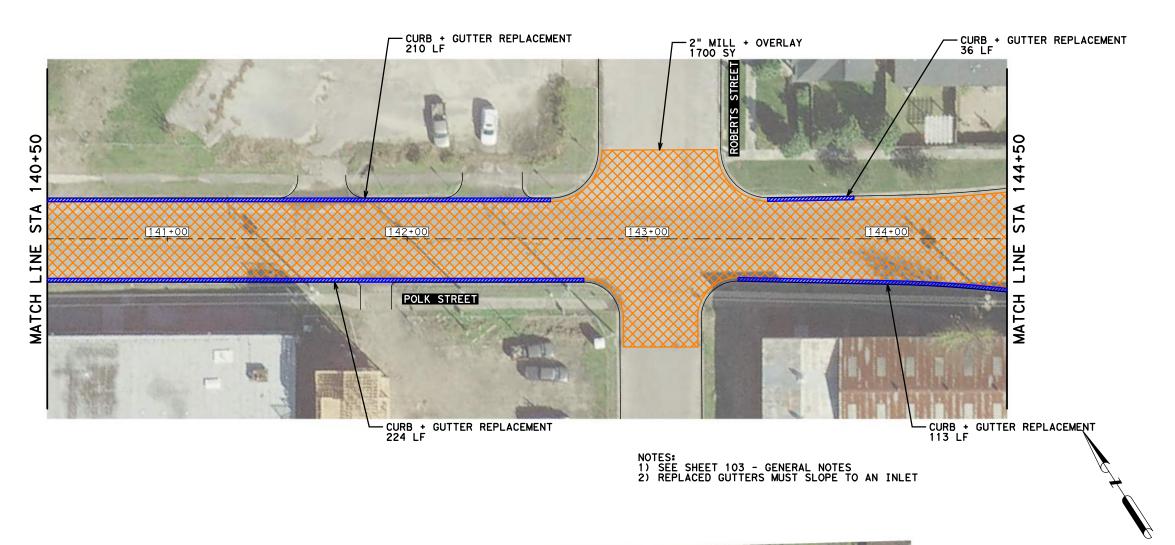






NO.	REVISIONS	DATE	NAME







	PROJECT TITLE:			
	<u>LK STREET ON-STREET BIKE</u>	[WAY]		
DRAWN BY:	SHEET DESCRIPTION:			
GB	PAVEMENT REPAIR + REMO	VAL LAYOUT		
CK'D BY:				
JL	SHEET 4 OF 8			
SCALE:				
1"=40'				
DATE:	APPROVED BY:			
4/12/2019				
		SHEET NO:		
		303		

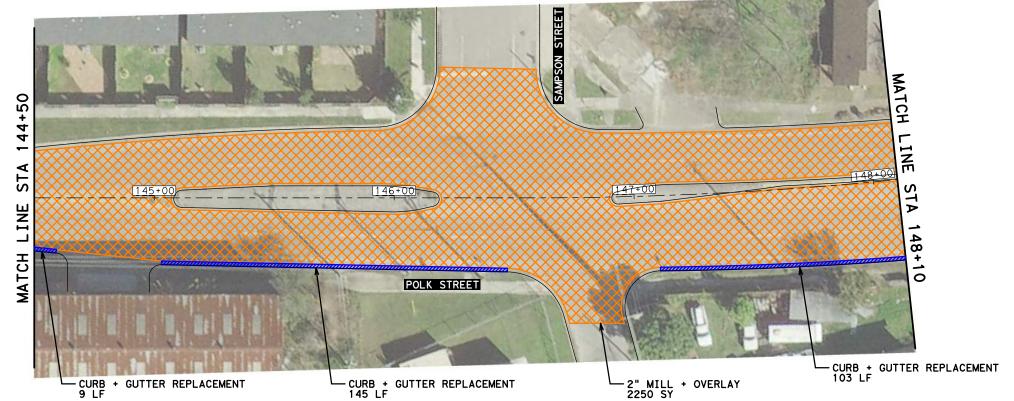

NOTES:
1) SEE SHEET 103 - GENERAL NOTES

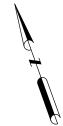

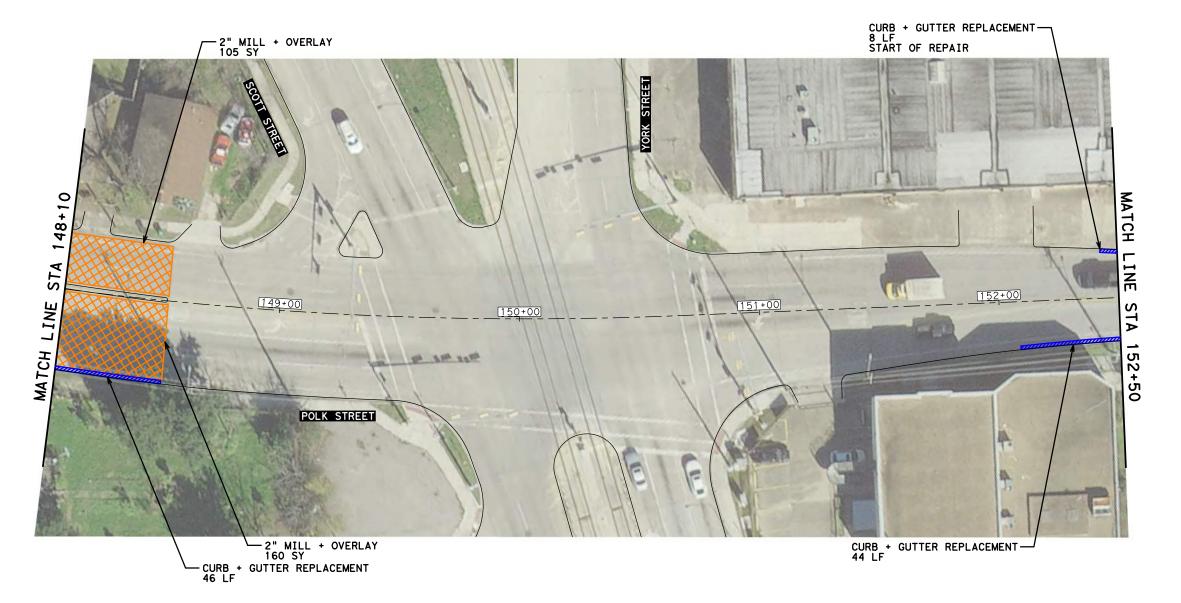





NO.	REVISIONS	DATE	NAME








PROJECT TITL	E:	
	LK STREET ON-STREET BIKE	WAY
DRAWN BY:	SHEET DESCRIPTION:	
GB	PAVEMENT REPAIR + REMO	VAL LAYOUT
CK'D BY:		
JL	SHEET 5 OF 8	
SCALE: 1"=40'		
DATE:	APPROVED BY:	
4/12/2019		
•	-	SHEET NO:
		304

PENTABLE: HC-Bikeways, tbl Repair Plan 6 of 8. dgn

12:52:21 PM USER:/USER/ (Traffic Engineers)\Clients\Harris Cou

DATE:4/12/2019 FILE:E:\Dropbox NOTES:
1) SEE SHEET 103 - GENERAL NOTES
2) REPLACED GUTTERS MUST SLOPE TO AN INLET



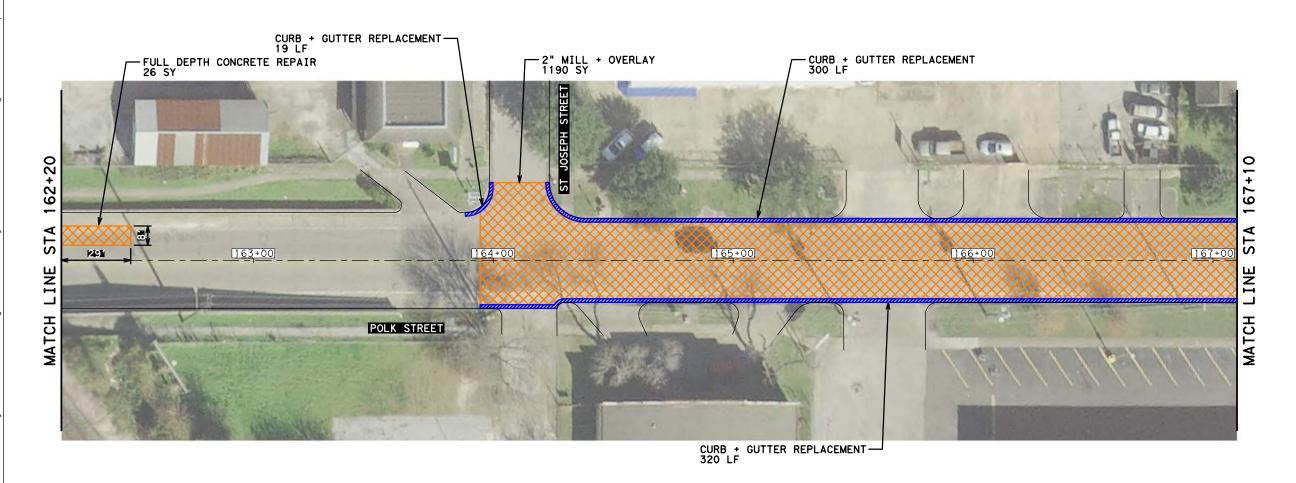





NO.	REVISIONS	DATE	NAME



801 Congress Avenue, Suite 325, Houston, TX 77002 TEL (713) 270-8145/FAX (281) 809-0807 TBPE Registration No. F-3158



PROJECT TITL	E:	
	LK STREET ON-STREET BIKE	WAY
DRAWN BY:	SHEET DESCRIPTION:	
GB	PAVEMENT REPAIR + REMO	VAL LAYOUT
CK'D BY:		
JL	SHEET 7 OF 8	
SCALE:		
1"=40'		
DATE:	APPROVED BY:	
4/12/2019		
		SHEET NO:
		306





NO.	REVISIONS	DATE	NAME	
				1





ENGINEERING DEPARTMENT

PROJECT TITLE:				
POI	LK STREET ON-STREET BIKE	WAY		
RAWN BY:	SHEET DESCRIPTION:			
GB	PAVEMENT REPAIR + REMO	VAL LAYOUT		
K'D BY:				
JL	SHEET 8 OF 8			
CALE:				
1"=40'				
ATE:	APPROVED BY:			
4/12/2019				
		SHEET NO:		
		307		
		1 55,		



REMOVE CONCRETE - 23 SY

PAVING



NOTES:
1) LANDING AREAS MARKED "L" 2% MAX SLOPE FOR DRAINAGE
2) SIDEWALK AREAS MARKED "T" TRANSITION TO EXISTING
3) SEE SHEET 215 FOR SIDEWALK DETAIL
4) SEE SHEET 216 FOR TY COH RAMP DETAIL





NO. REVISIONS DATE NAME



801 Congress Avenue, Suite 325, Houston, TX 77002 TEL (713) 270-8145/FAX (281) 809-0807 TBPE Registration No. F-3158



HARRIS COUNTY ENGINEERING DEPARTMENT


PROJECT TITLE:
POLK STREET ON—STREET BIKEWAY

DRAWN BY: SHEET DESCRIPTION:
GB POLK © ST. CHARLES

CK'D BY:
JL CONCRETE REMOVAL & PAVING

SCALE:
1"=20'
DATE:
4/12/2019
SHEET NO:
309

PENTABLE: HC-Bikewdys. +bl es Concrete Removal & Paving. DATE:4/12/2019 FILE:E:\Dropbox

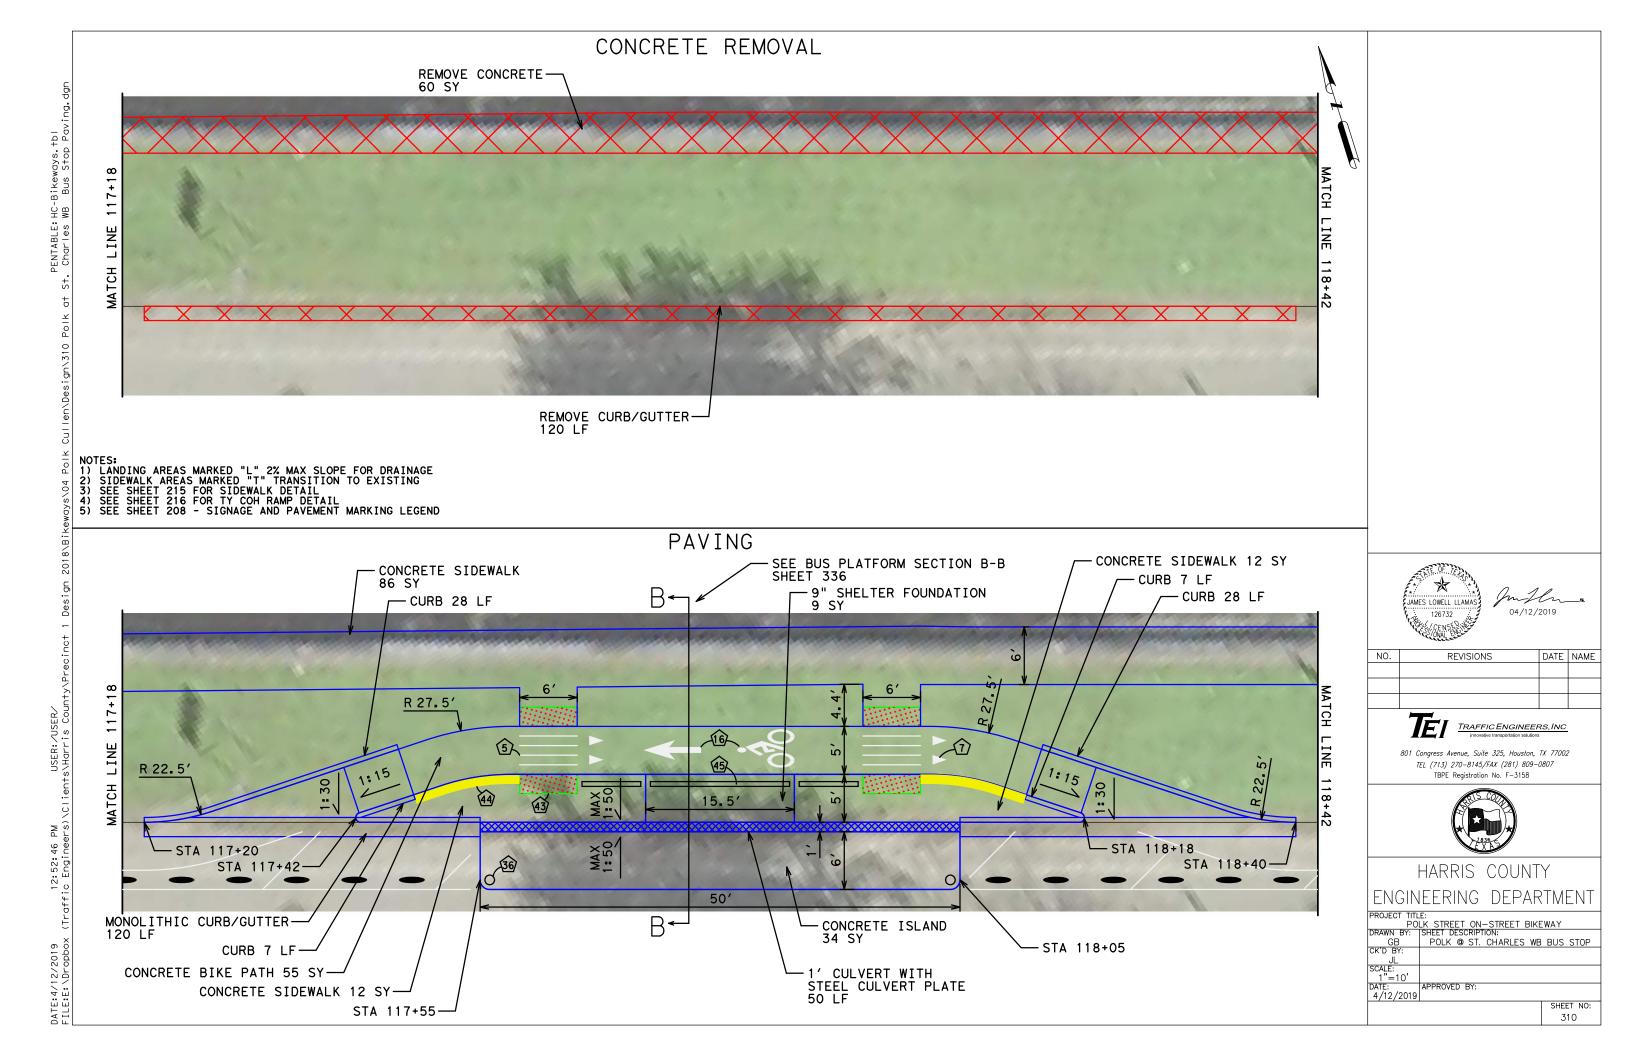

REMOVE CONCRETE 74 SY







NO.	REVISIONS	DATE	NAME




801 Congress Avenue, Suite 325, Houston, TX 77002 TEL (713) 270-8145/FAX (281) 809-0807 TBPE Registration No. F-3158



HARRIS COUNTY ENGINEERING DEPARTMENT

PROJECT TITLE:				
POLK STREET ON-STREET BIKEWAY				
DRAWN BY:	SHEET DESCRIPTION:			
GB	POLK @ LIVE OAK			
CK'D BY:				
JL	CONCRETE REMOVAL			
SCALE:				
1"=20'				
DATE:	APPROVED BY:			
4/12/2019				

SHEET NO: 311 NOTES:
1) LANDING AREAS MARKED "L" 2% MAX SLOPE FOR DRAINAGE
2) SIDEWALK AREAS MARKED "T" TRANSITION TO EXISTING
3) SEE SHEET 215 FOR SIDEWALK DETAIL
4) SEE SHEET 216 FOR TY COH RAMP DETAIL

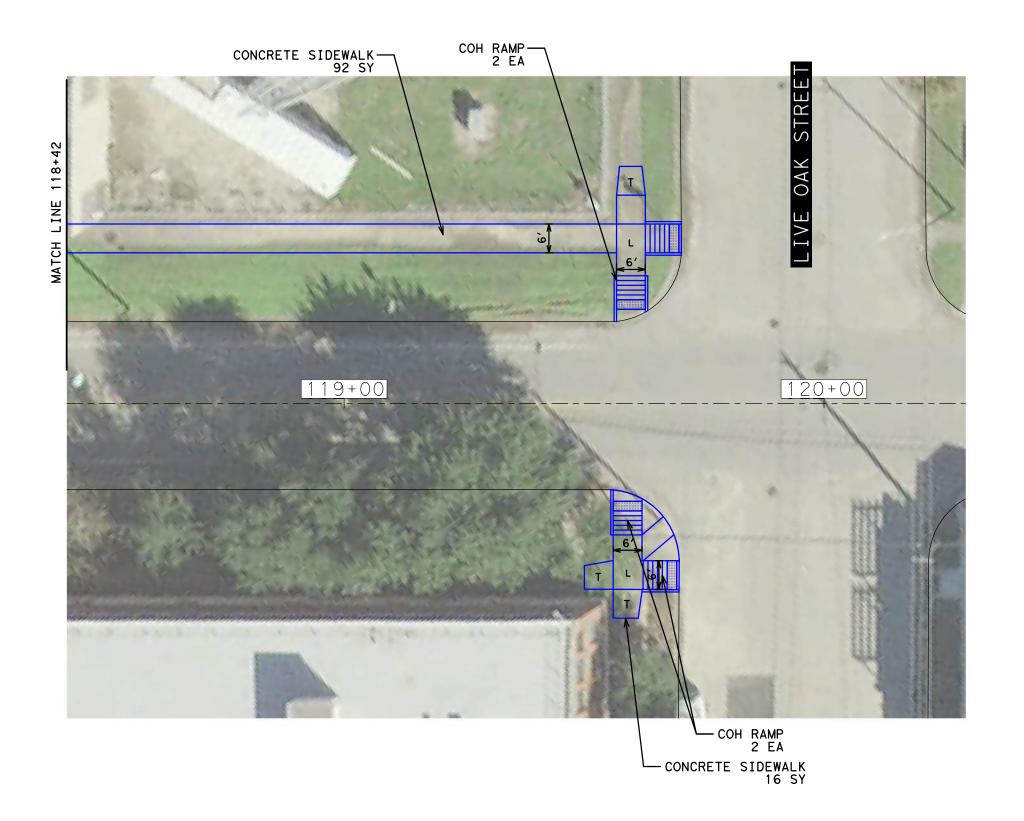






NO.	REVISIONS	DATE	NAME



801 Congress Avenue, Suite 325, Houston, TX 77002 TEL (713) 270-8145/FAX (281) 809-0807 TBPE Registration No. F-3158



OJECT TITL	OJECT TITLE:			
	LK STREET ON-STREET BIKE	EWAY		
AWN BY:	SHEET DESCRIPTION:			
GB	POLK @ LIVE OA	١K		
'D BY:				
JL	PAVING			
ALE:				
1"=20'				
ΓE:	APPROVED BY:			
/12/2019				
		SHEET NO:		
		312		

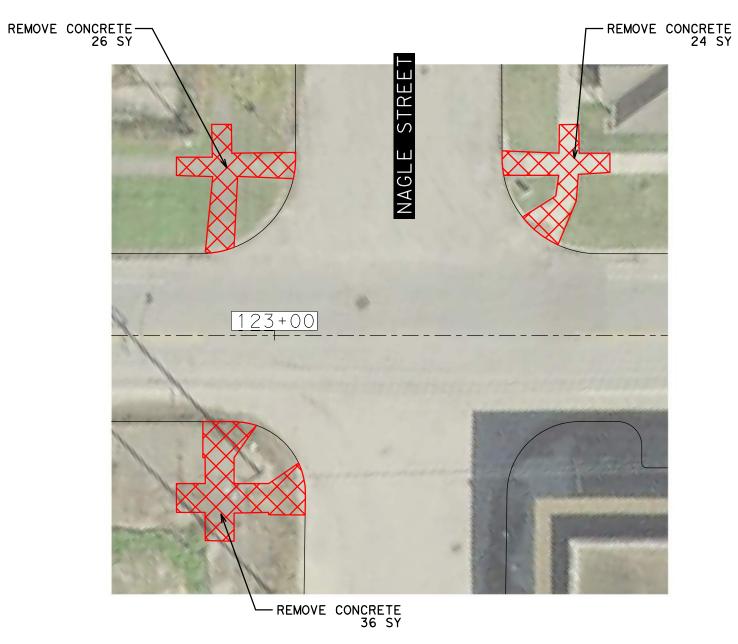



NO.	REVISIONS	DATE	NAME	






, .					
PROJECT TITL	E:				
	LK STREET ON-STREET BIKE	EWAY			
DRAWN BY:	SHEET DESCRIPTION:				
GB	POLK @ NAGLE	-			
CK'D BY:					
JL	CONCRETE REMO\	/AL			
SCALE:					
1"=20'					
DATE:	APPROVED BY:				
4/12/2019					
		SHEET NO:			
		313			
		0.0			

NOTES:
1) LANDING AREAS MARKED "L" 2% MAX SLOPE FOR DRAINAGE
2) SIDEWALK AREAS MARKED "T" TRANSITION TO EXISTING
3) SEE SHEET 215 FOR SIDEWALK DETAIL
4) SEE SHEET 216 FOR TY COH RAMP DETAIL



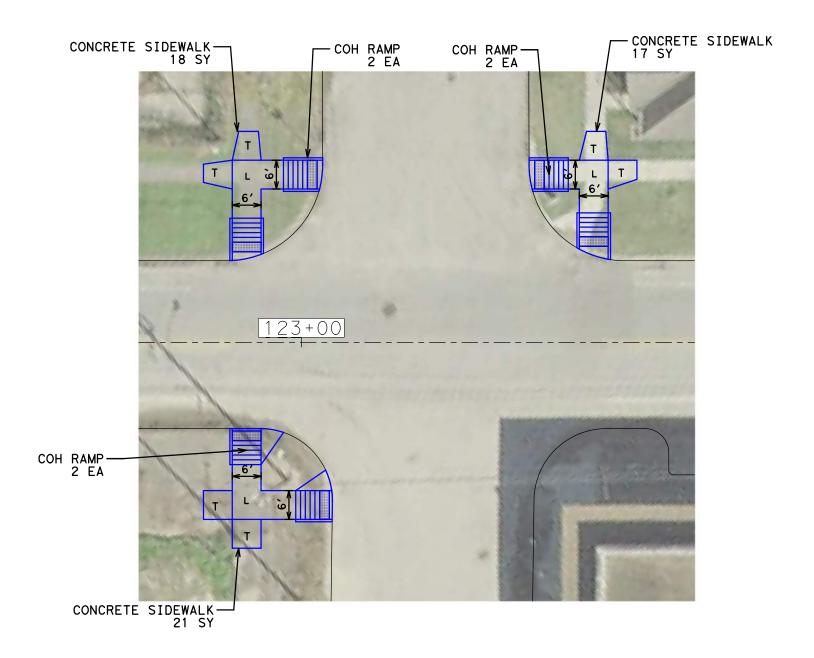



NO.	REVISIONS	DATE	NAME




801 Congress Avenue, Suite 325, Houston, TX 77002 TEL (713) 270-8145/FAX (281) 809-0807 TBPE Registration No. F-3158



ROJECT TITLE:				
PO	LK STREET ON-STREET BIKE	WAY		
RAWN BY:	SHEET DESCRIPTION:			
GB	POLK @ NAGLE	•		
K'D BY:				
JL	PAVING			
CALE:				
1"=20'				
ATE:	APPROVED BY:			
4/12/2019				
		SHEET NO:		
		314		

PAVING



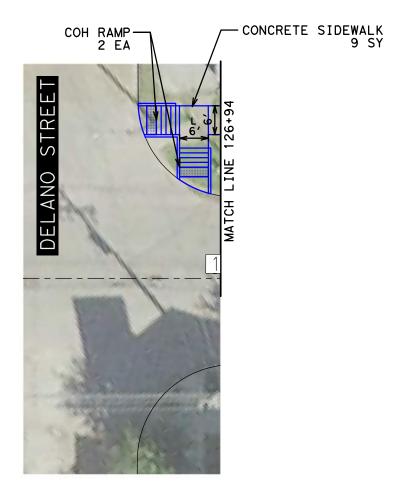



NO.	REVISIONS	DATE	NAME



801 Congress Avenue, Suite 325, Houston, TX 77002 TEL (713) 270-8145/FAX (281) 809-0807 TBPE Registration No. F-3158




HARRIS COUNTY ENGINEERING DEPARTMENT


SHEET NO:

315

NOTES:
1) LANDING AREAS MARKED "L" 2% MAX SLOPE FOR DRAINAGE
2) SIDEWALK AREAS MARKED "T" TRANSITION TO EXISTING
3) SEE SHEET 215 FOR SIDEWALK DETAIL
4) SEE SHEET 216 FOR TY COH RAMP DETAIL

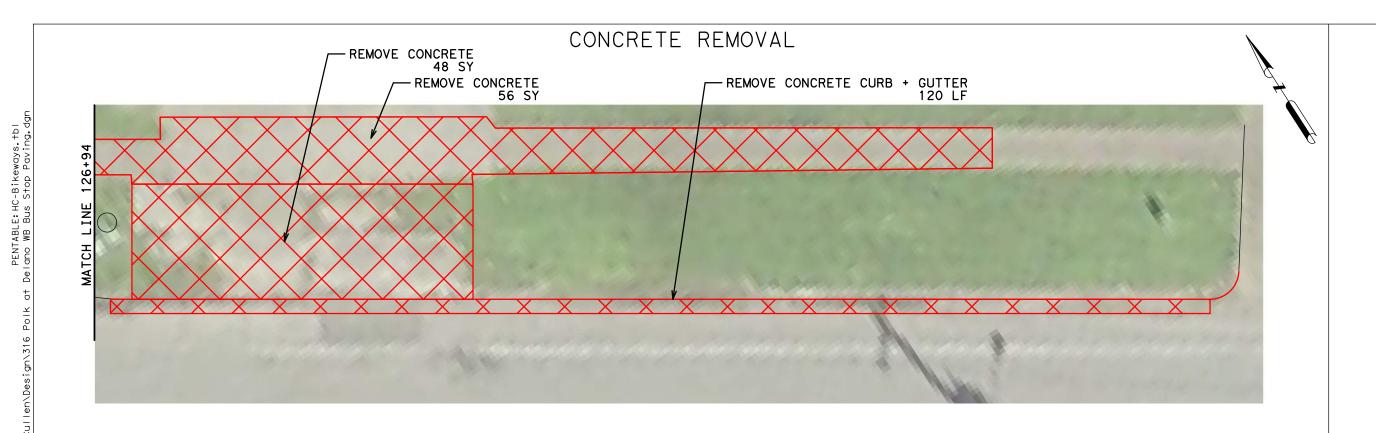

NOTES:
1) LANDING AREAS MARKED "L" 2% MAX SLOPE FOR DRAINAGE
2) SIDEWALK AREAS MARKED "T" TRANSITION TO EXISTING
3) SEE SHEET 215 FOR SIDEWALK DETAIL
4) SEE SHEET 216 FOR TY COH RAMP DETAIL
5) SEE SHEET 208 - SIGNAGE AND PAVEMENT MARKING LEGEND

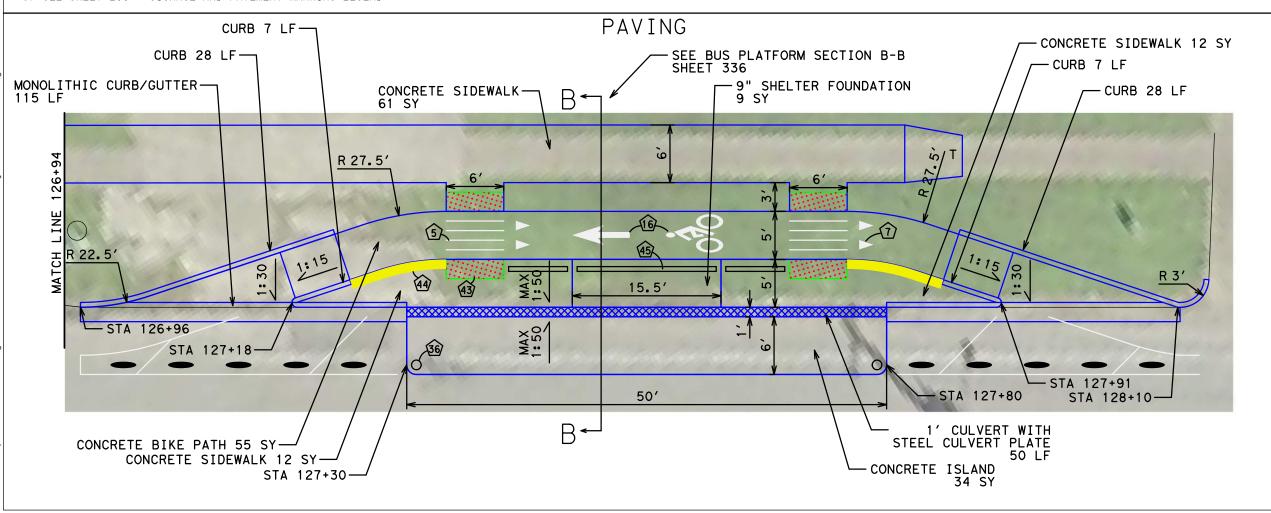



REVISIONS DATE NAME NO.




801 Congress Avenue, Suite 325, Houston, TX 77002 TEL (713) 270-8145/FAX (281) 809-0807




PROJECT TITLE:				
	LK STREET ON-STREET BIKE	WAY		
DRAWN BY:	SHEET DESCRIPTION:			
GB	POLK @ DELANO WB B	US STOP		
CK'D BY:				
JL				
SCALE:				
1"=10'				
DATE:	APPROVED BY:			
4/12/2019				
	·	SHEET NO:		
		316		

CONCRETE REMOVAL

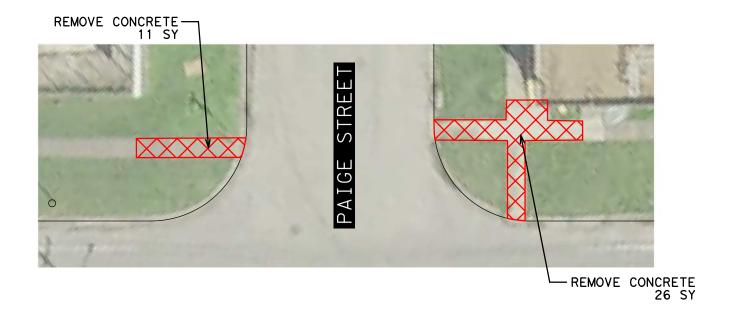



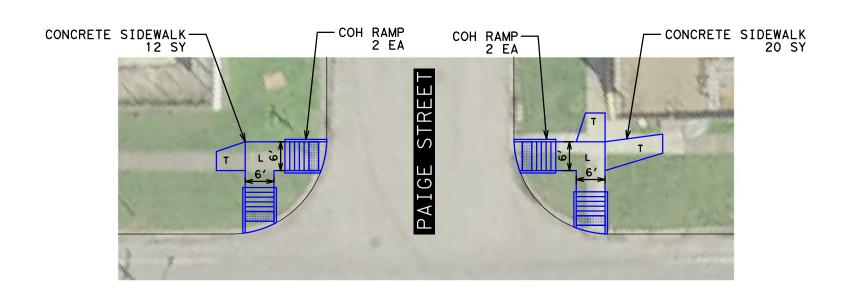

NOTES:
1) LANDING AREAS MARKED "L" 2% MAX SLOPE FOR DRAINAGE
2) SIDEWALK AREAS MARKED "T" TRANSITION TO EXISTING
3) SEE SHEET 215 FOR SIDEWALK DETAIL
4) SEE SHEET 216 FOR TY COH RAMP DETAIL



NO.	REVISIONS	DATE	NAME



801 Congress Avenue, Suite 325, Houston, TX 77002 TEL (713) 270-8145/FAX (281) 809-0807 TBPE Registration No. F-3158



HARRIS COUNTY ENGINEERING DEPARTMENT

PROJECT TITLE:				
	LK STREET ON-STREET BIKE	WAY		
DRAWN BY:	SHEET DESCRIPTION:			
GB	POLK @ PAIGE			
CK'D BY:				
JL	CONCRETE REMOVAL &	: PAVING		
SCALE:				
1"=20'				
DATE:	APPROVED BY:			
4/12/2019				
•		SHEET NO:		
		317		

PENTABLE: HC-Bikeways. +blete Removal & Paving.dgn DATE:4/12/2019 12:53:11 PM USER:/USER/ FILE:E:\Dropbox (Traffic Engineers)\Clients\Harris County\Precinct REMOVE CONCRETE— 22 SY

REMOVE CONCRETE—11 SY



REMOVE CONCRETE 31 SY

XUCUK

REMOVE CONCRETE 31 SY



NO.	REVISIONS	DATE	NAME



801 Congress Avenue, Suite 325, Houston, TX 77002 TEL (713) 270-8145/FAX (281) 809-0807 TBPE Registration No. F-3158



PROJECT TITLE:						
	LK STREET ON-STREET BIKE	- WAY				
DRAWN BY:	SHEET DESCRIPTION:					
GB	POLK @ ENNIS					
CK'D BY:						
JL	CONCRETE REMOV	/AL				
SCALE:						
1"=20'						
DATE:	APPROVED BY:					
4/12/2019						
		SHEET NO:				
		710				



NO.	REVISIONS	DATE	NAME






HARRIS COUNTY ENGINEERING DEPARTMENT

PROJECT TITLE:
POLK STREET ON—STREET BIKEWAY
DRAWN BY: SHEET DESCRIPTION:
GB POLK @ ENNIS
CK'D BY: DAVANG JL SCALE: 1"=20' DATE: 4/12/2019 PAVING APPROVED BY: SHEET NO:

319

NOTES:
1) LANDING AREAS MARKED "L" 2% MAX SLOPE FOR DRAINAGE
2) SIDEWALK AREAS MARKED "T" TRANSITION TO EXISTING
3) SEE SHEET 215 FOR SIDEWALK DETAIL
4) SEE SHEET 216 FOR TY COH RAMP DETAIL

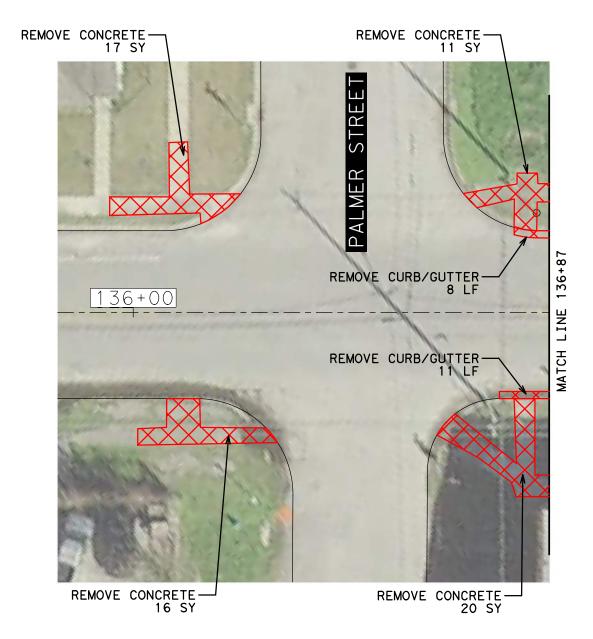




NO.	REVISIONS	DATE	NAME





PROJECT TITLE:						
	POLK STREET ON-STREET BIKEWAY					
DRAWN BY:	SHEET DESCRIPTION:					
GB	POLK @ PALMEI	R				
CK'D BY:						
JL	CONCRETE REMO\	/AL				
SCALE:						
1"=20'						
DATE:	APPROVED BY:					
4/12/2019						
•		SHEET NO:				
		320				

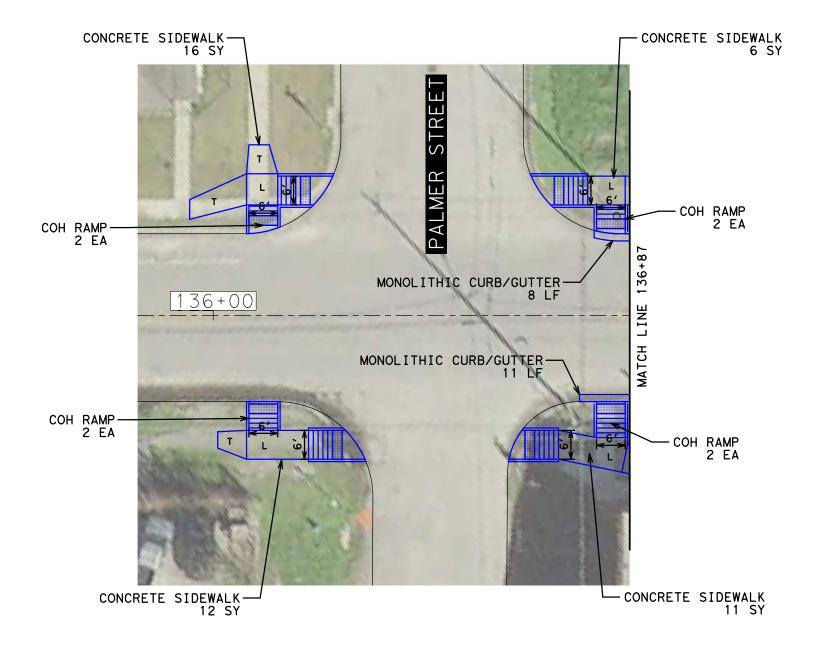



NO.	REVISIONS	DATE	NAME
	NO.	NO. REVISIONS	NO. REVISIONS DATE



801 Congress Avenue, Suite 325, Houston, TX 77002 TEL (713) 270-8145/FAX (281) 809-0807





HARRIS COUNTY ENGINEERING DEPARTMENT


PROJECT TITLE:
POLK STREET ON—STREET BIKEWAY
DRAWN BY: SHEET DESCRIPTION:
GB POLK @ PALMER JL SCALE: 1"=20' DATE: 4/12/2019 PAVING APPROVED BY: SHEET NO:

321

NOTES:
1) LANDING AREAS MARKED "L" 2% MAX SLOPE FOR DRAINAGE
2) SIDEWALK AREAS MARKED "T" TRANSITION TO EXISTING
3) SEE SHEET 215 FOR SIDEWALK DETAIL
4) SEE SHEET 216 FOR TY COH RAMP DETAIL

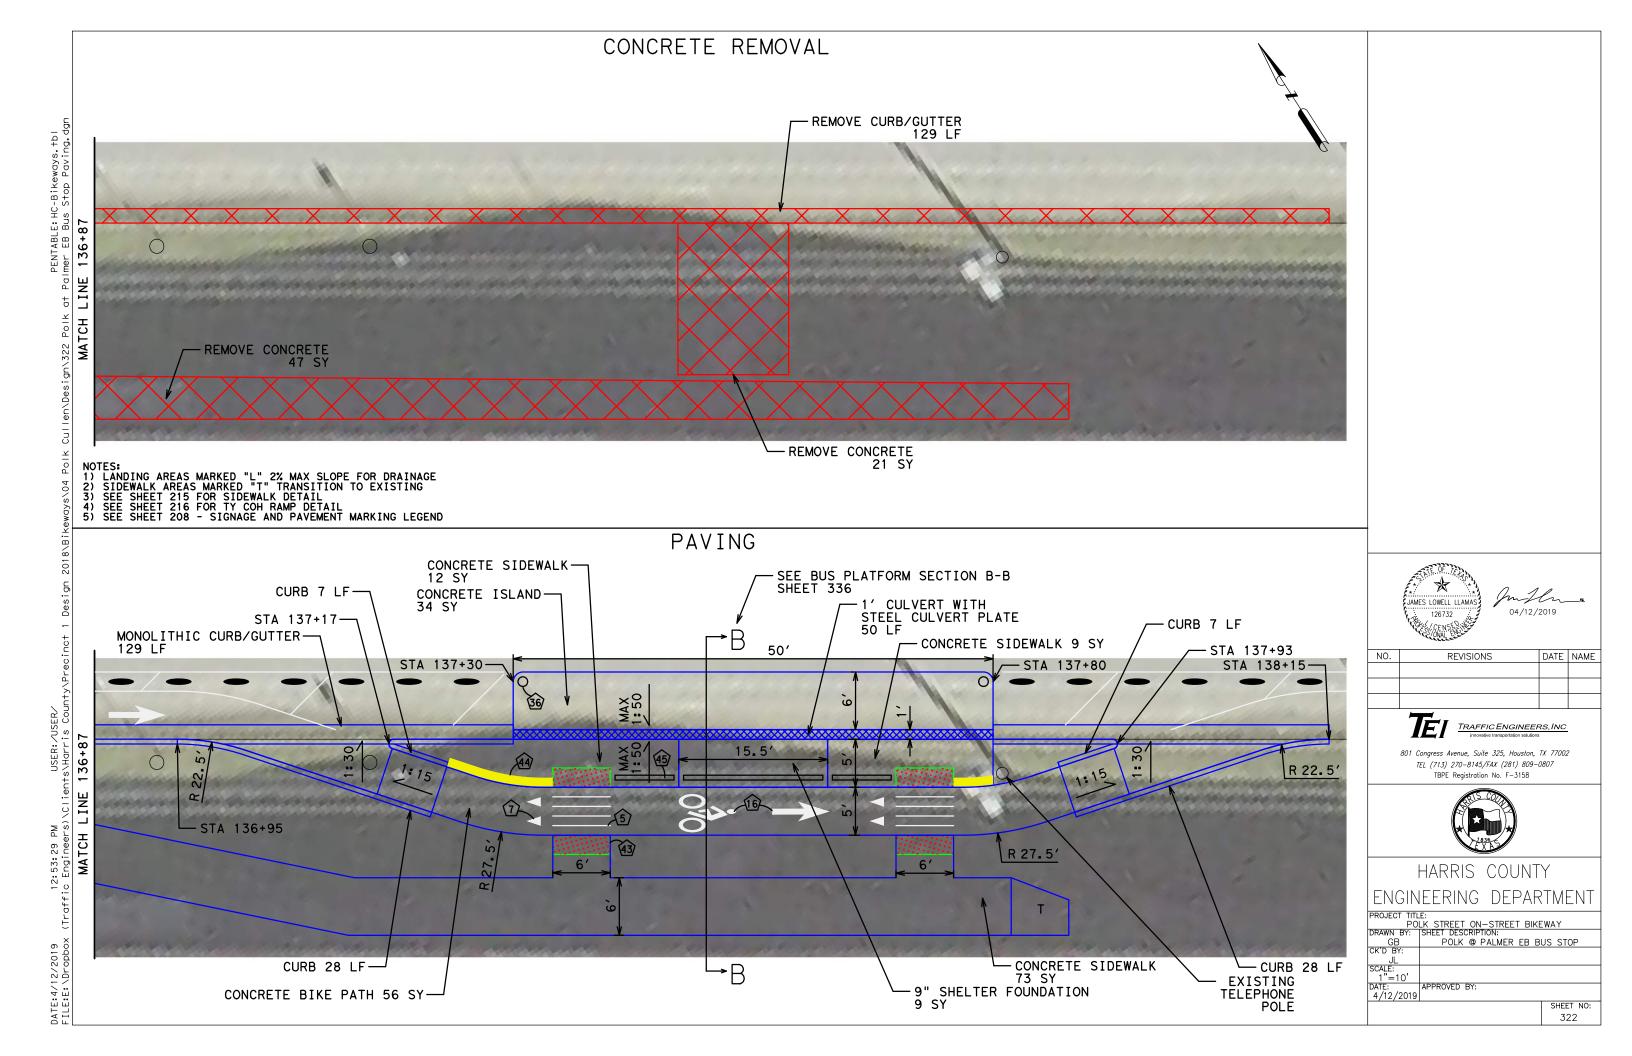

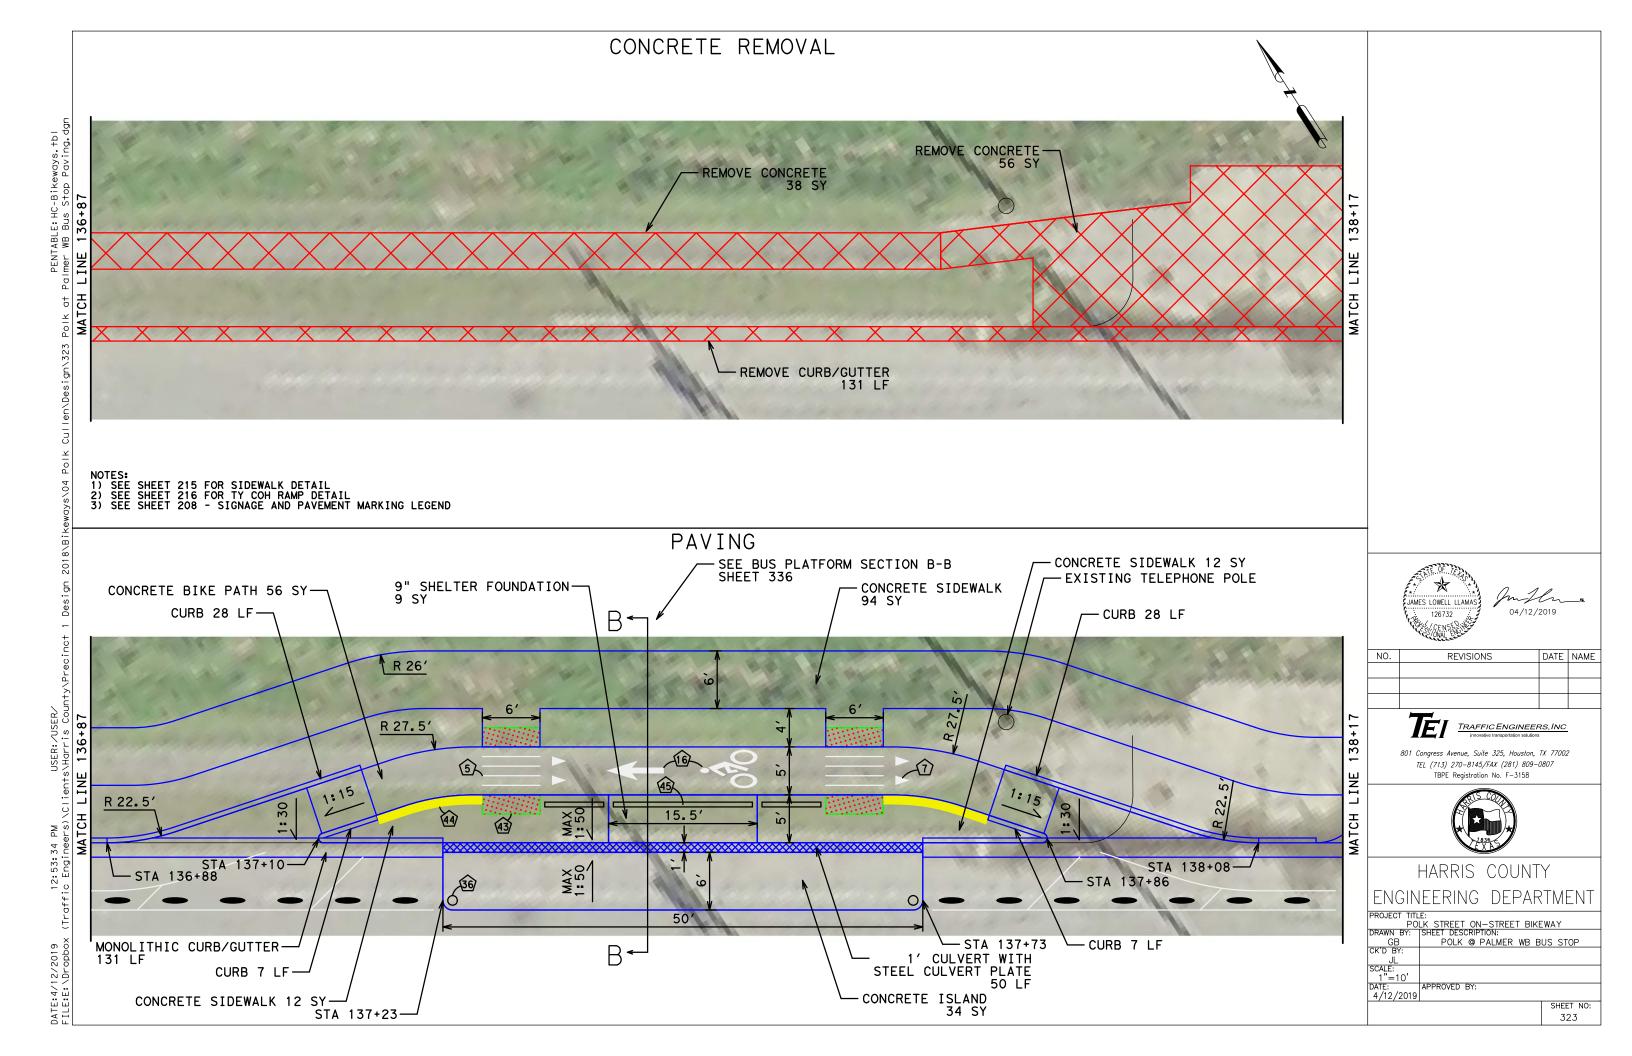

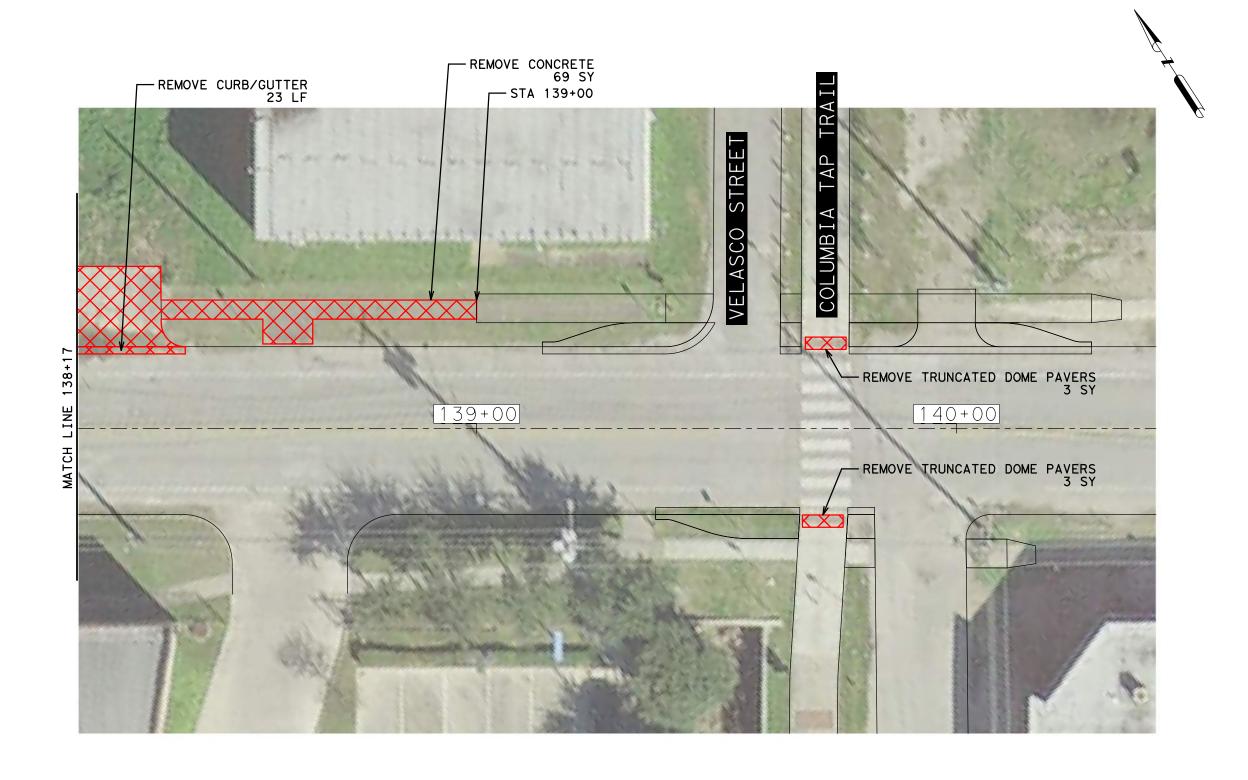




NO.	REVISIONS	DATE	NAME





PROJECT TITLE:				
	LK STREET ON-STREET BIKE	EWAY		
DRAWN BY:	SHEET DESCRIPTION:			
GB	POLK @ VELASC	0		
CK'D BY:				
JL	CONCRETE REMOV	/AL		
SCALE:				
1"=20'				
DATE:	APPROVED BY:			
4/12/2019				
		SHEET NO:		
		324		
		J		

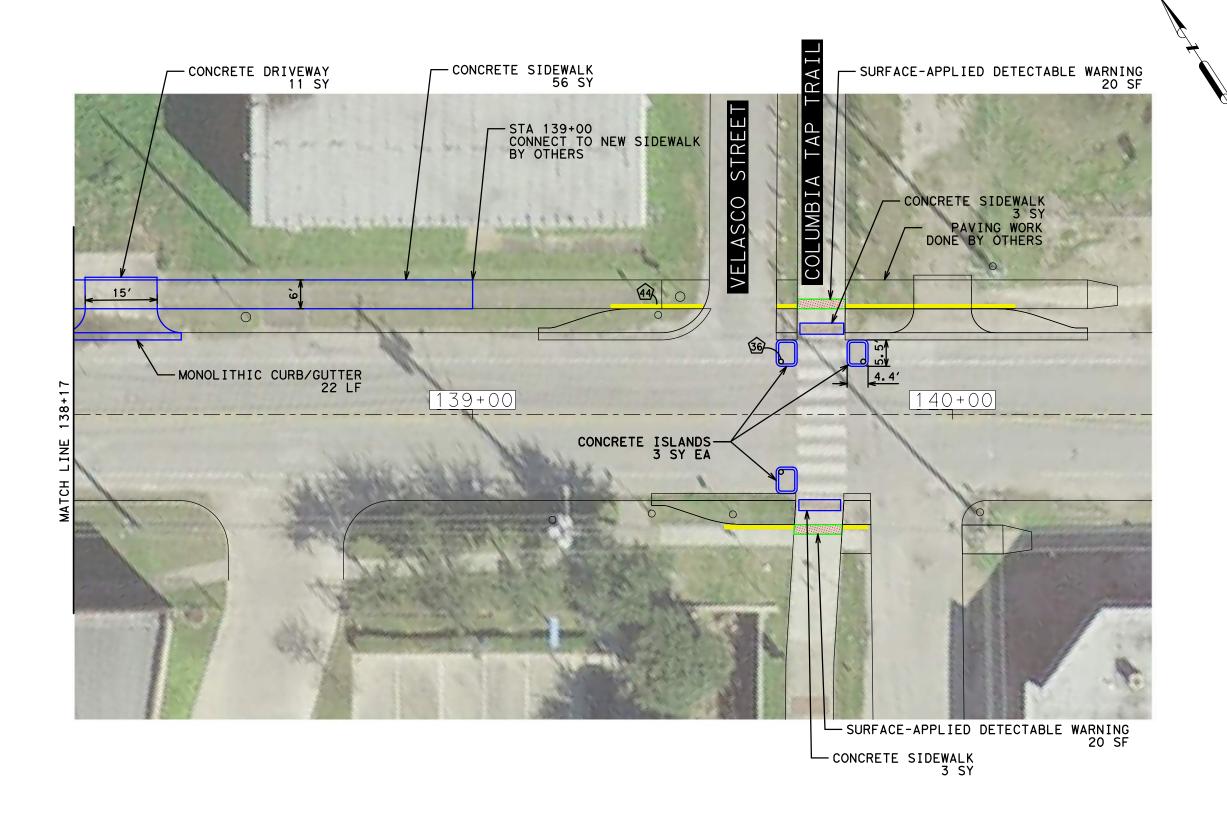



NO.	REVISIONS	DATE	NAME





HARRIS COUNTY ENGINEERING DEPARTMENT

PROJECT TITLE:				
	LK STREET ON-STREET BIK	EWAY		
DRAWN BY:	SHEET DESCRIPTION:			
GB	POLK @ VELASCO F	AVING		
CK'D BY:				
JL				
SCALE:				
1"=20'				
DATE:	APPROVED BY:			
4/12/2019				
		SHEET NO:		
		325		

NOTES:
1) LANDING AREAS MARKED "L" 2% MAX SLOPE FOR DRAINAGE
2) SIDEWALK AREAS MARKED "T" TRANSITION TO EXISTING
3) SEE SHEET 215 FOR SIDEWALK DETAIL
4) SEE SHEET 216 FOR TY COH RAMP DETAIL






NO.	REVISIONS	DATE	NAME





ENOUGEER OF BEITH OF BEITH					
PROJECT TITL					
	<u>LK STREET ON-STREET BIKE</u>	WAY			
DRAWN BY:	SHEET DESCRIPTION:				
GB	POLK @ ROBER1	ΓS			
CK'D BY:					
JL	JL CONCRETE REMOVAL				
SCALE:					
1"=20'					
DATE:	APPROVED BY:				
4/12/2019					
•		SHEET NO:			
		326			
		1 020			

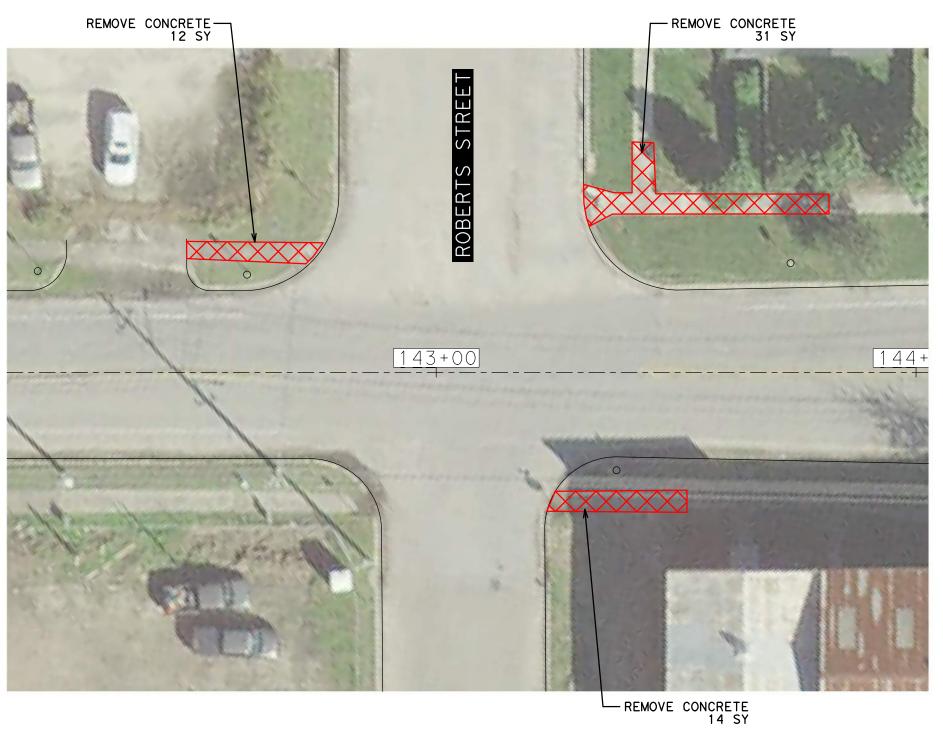

CONCRETE SIDEWALK — 8 SY

CONCRETE SIDEWALK-8 SY

COH RAMP-2 EA

CONCRETE SIDEWALK-21 SY



NO.	REVISIONS	DATE	NAME



801 Congress Avenue, Suite 325, Houston, TX 77002 TEL (713) 270-8145/FAX (281) 809-0807 TBPE Registration No. F-3158



HARRIS COUNTY ENGINEERING DEPARTMENT


PROJECT TITLE:
POLK STREET ON—STREET BIKEWAY
DRAWN BY: SHEET DESCRIPTION:
GB POLK @ ROBERTS
CK'D BY: JL SCALE: 1"=20' DATE: 4/12/2019 PAVING APPROVED BY: SHEET NO: 327

NOTES:
1) LANDING AREAS MARKED "L" 2% MAX SLOPE FOR DRAINAGE
2) SIDEWALK AREAS MARKED "T" TRANSITION TO EXISTING
3) SEE SHEET 215 FOR SIDEWALK DETAIL
4) SEE SHEET 216 FOR TY COH RAMP DETAIL

-CONCRETE SIDEWALK 13 SY

NOTES:



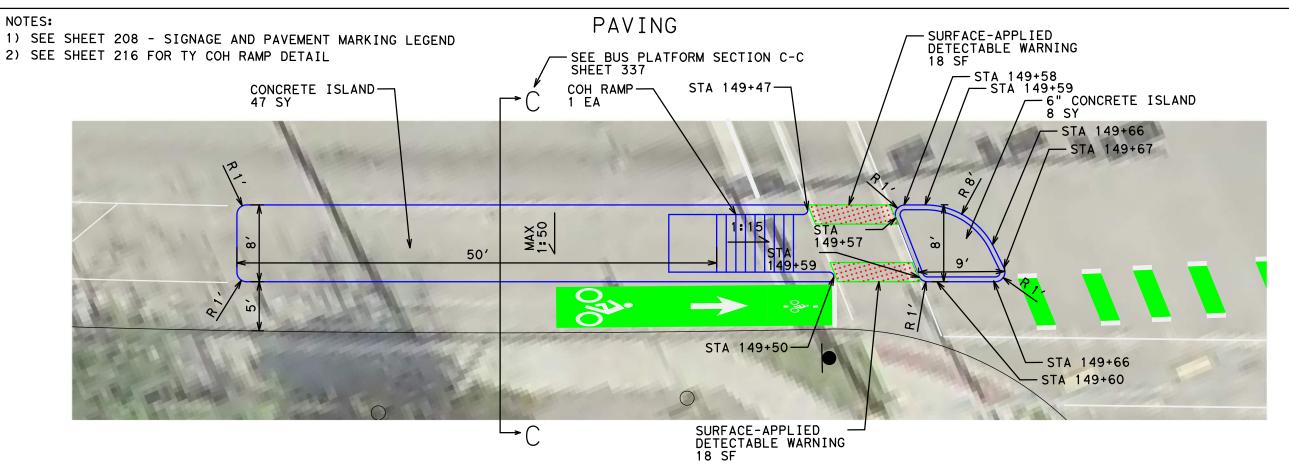






NO.	REVISIONS	DATE	NAME



801 Congress Avenue, Suite 325, Houston, TX 77002 TEL (713) 270-8145/FAX (281) 809-0807




PROJECT TITLE:					
P0	POLK STREET ON-STREET BIKEWAY				
DRAWN BY:	SHEET DESCRIPTION:				
GB	POLK @ SCOTT EB BL	JS STOP			
CK'D BY:					
JL	L PAVING DETAIL				
SCALE:					
1"=10'					
DATE:	APPROVED BY:				
4/12/2019					
		SHEET NO:			
		328			

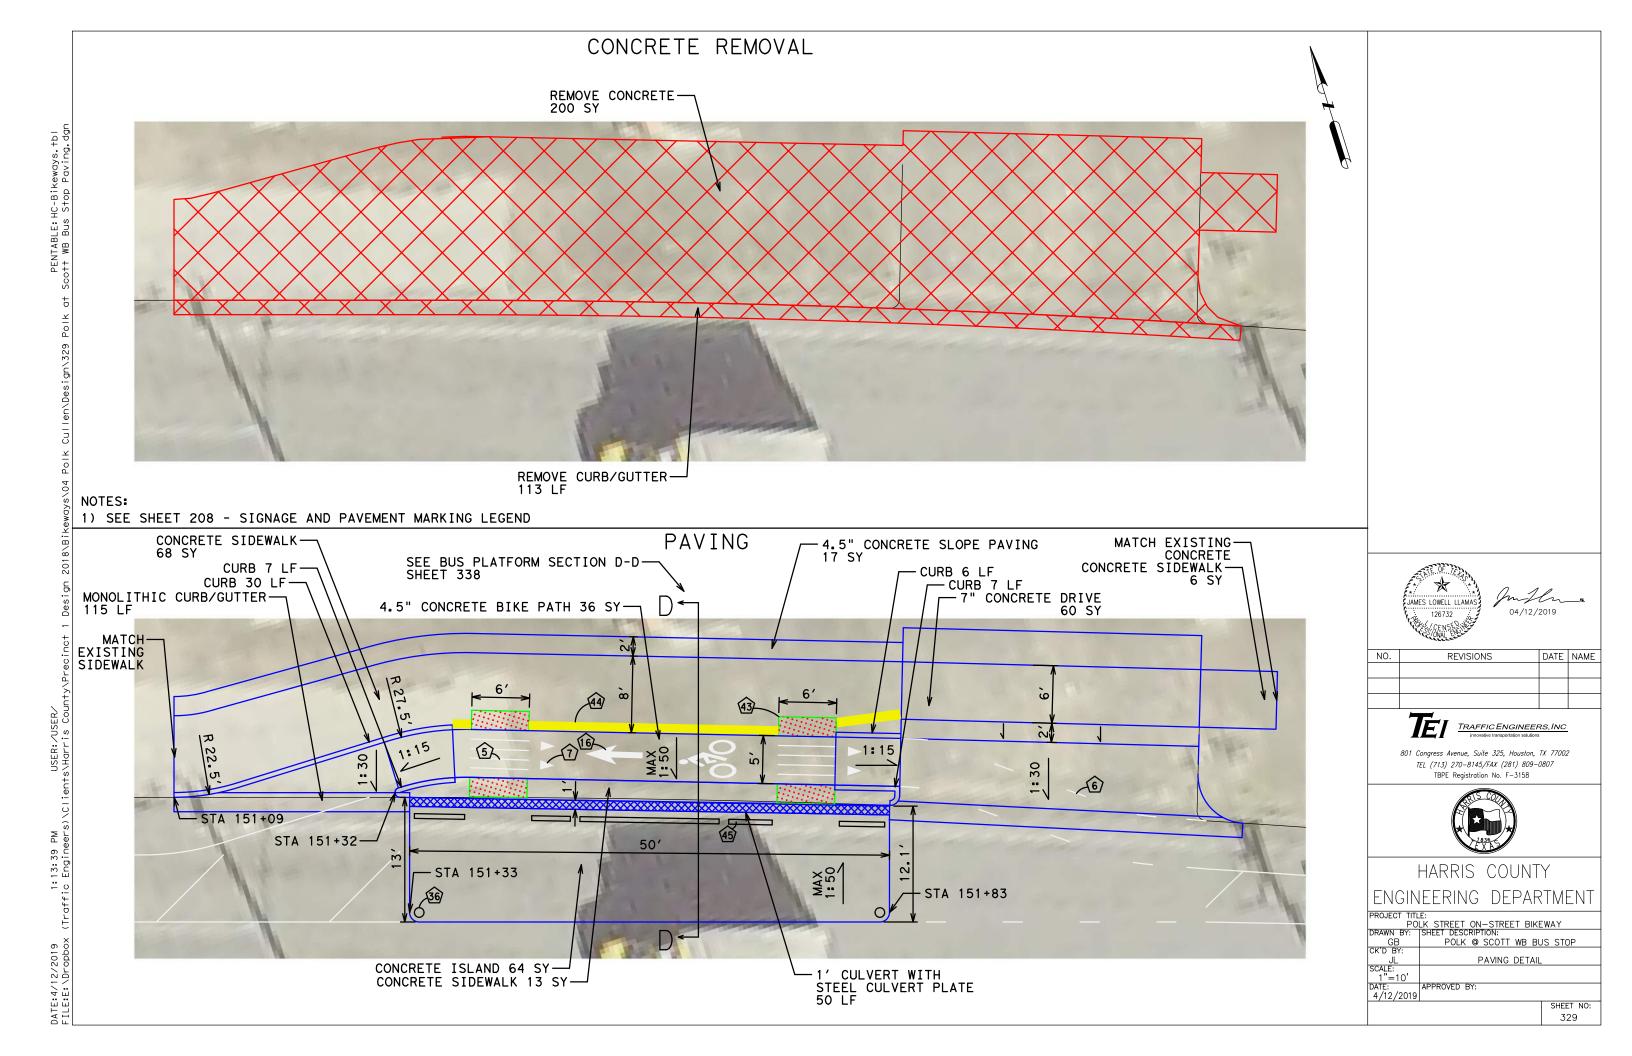



THIS SPACE INTENTIONALLY LEFT BLANK

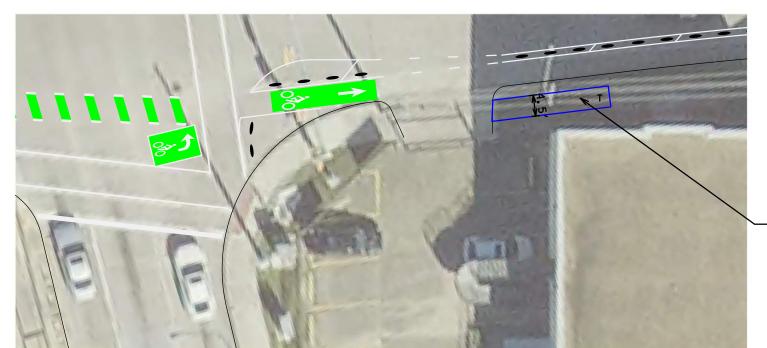

- CONCRETE SIDEWALK 12 SY

NOTES:
1) LANDING AREAS MARKED "L" 2% MAX SLOPE FOR DRAINAGE
2) SIDEWALK AREAS MARKED "T" TRANSITION TO EXISTING
3) SEE SHEET 215 FOR SIDEWALK DETAIL
4) SEE SHEET 216 FOR TY COH RAMP DETAIL



NO. REVISIONS DATE NAME


04/12/2019



801 Congress Avenue, Suite 325, Houston, TX 77002 TEL (713) 270-8145/FAX (281) 809-0807 TBPE Registration No. F-3158



ROJECT TITLE:				
POI	LK STREET ON-STREET BIKE	WAY		
RAWN BY:	SHEET DESCRIPTION:			
GB	POLK @ SCOTT	=		
K'D BY:				
JL	PAVING			
CALE:				
1"=20'				
ATE:	APPROVED BY:			
4/12/2019				
		SHEET NO:		
		330		
		000		

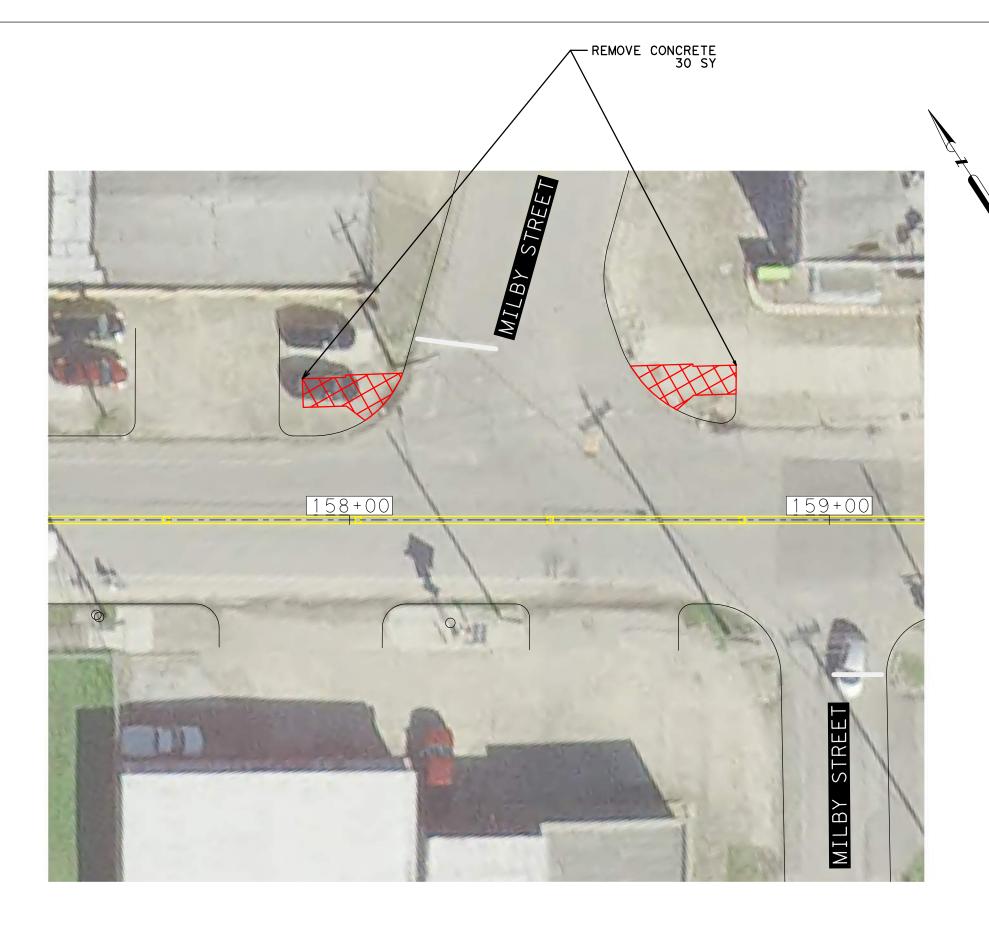





NO.	REVISIONS	DATE	NAME






HARRIS COUNTY

ENGINEERING DEPARTMENT

PROJECT TITL	.E:			
P0	LK STREET ON-STREET BIKE	EWAY		
DRAWN BY:	SHEET DESCRIPTION:			
GB	POLK @ MILBY			
CK'D BY:				
JL	CONCRETE REMOV	/AL		
SCALE:				
1"=20'				
DATE:	APPROVED BY:			
4/12/2019				
		SHEET NO:		
		331		

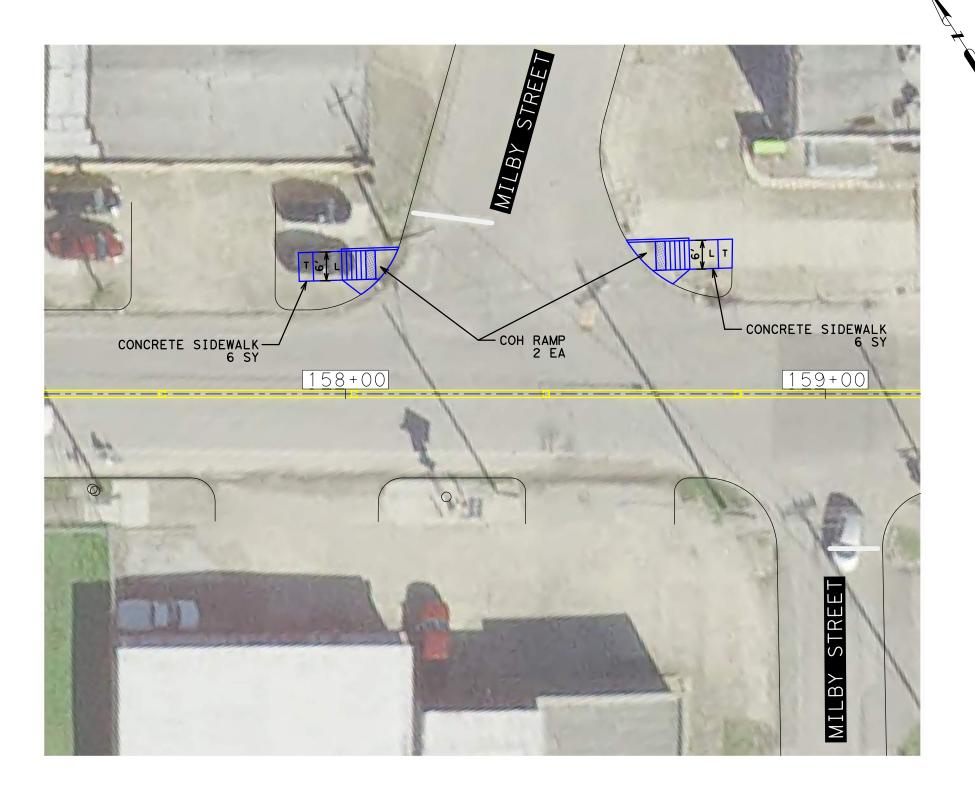



REVISIONS	DATE	NAME
_	REVISIONS	REVISIONS DATE







HARRIS COUNTY

ENGINEERING DEPARTMENT


NOTES:
1) LANDING AREAS MARKED "L" 2% MAX SLOPE FOR DRAINAGE
2) SIDEWALK AREAS MARKED "T" TRANSITION TO EXISTING
3) SEE SHEET 215 FOR SIDEWALK DETAIL
4) SEE SHEET 216 FOR TY COH RAMP DETAIL

PROJECT TITLE:				
	LK STREET ON-STREET BIKE	WAY		
DRAWN BY:	SHEET DESCRIPTION:			
GB	POLK @ MILBY			
CK'D BY:				
JL	PAVING			
SCALE:				
1"=20'				
DATE:	APPROVED BY:			
4/12/2019				
		SHEET NO:		
		332		
		002		

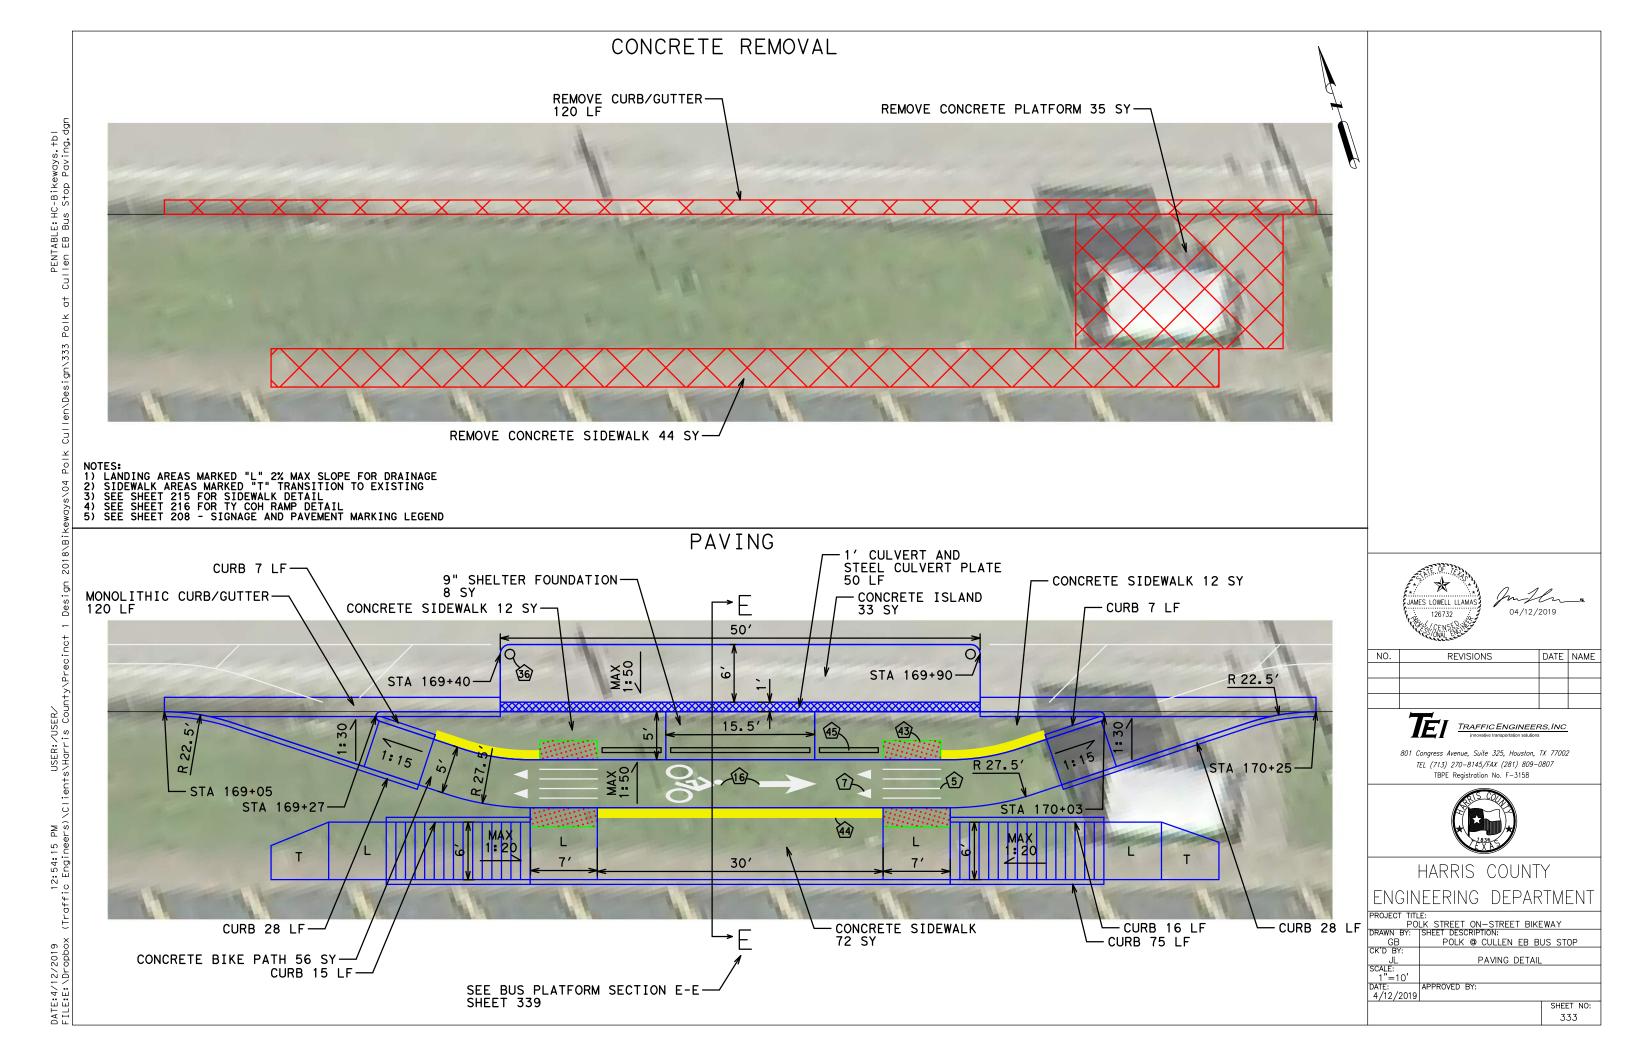

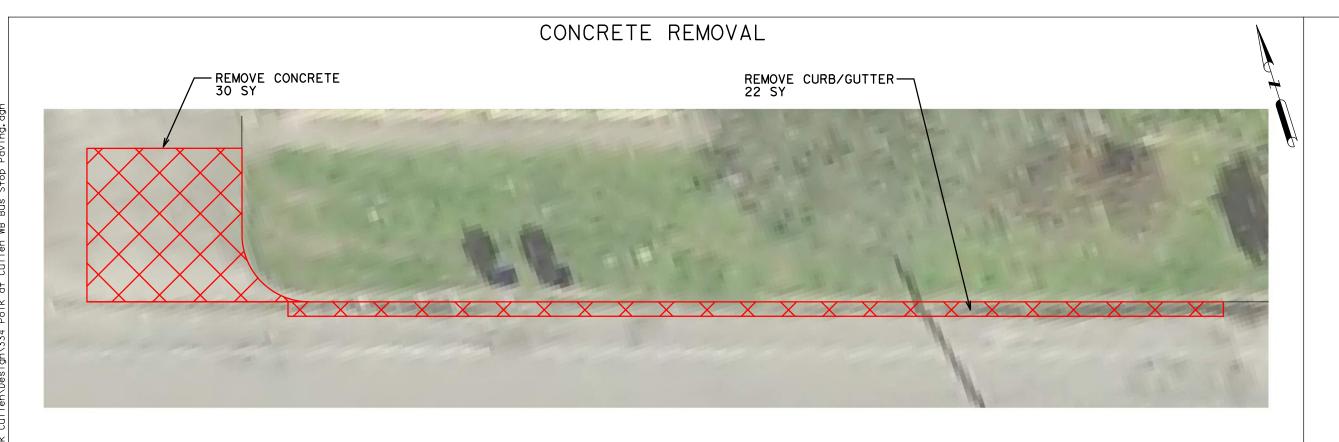

NOTES:
1) SIDEWALK AREAS MARKED "T" TRANSITION TO EXISTING
2) SEE SHEET 215 FOR SIDEWALK DETAIL
3) SEE SHEET 216 FOR TY COH RAMP DETAIL
4) SEE SHEET 208 - SIGNAGE AND PAVEMENT MARKING LEGEND

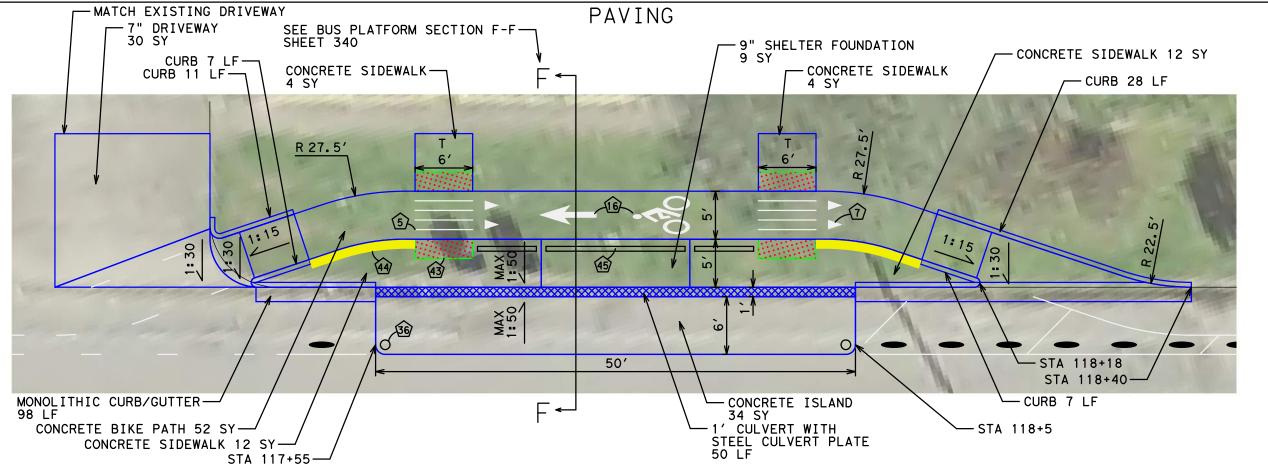



04/12/2019

NO.	REVISIONS	DATE	NAME



801 Congress Avenue, Suite 325, Houston, TX 77002 TEL (713) 270-8145/FAX (281) 809-0807




HARRIS COUNTY ENGINEERING DEPARTMENT


PROJECT TITLE:			
P0	LK STREET ON-STREET BIKE	WAY	
DRAWN BY:	SHEET DESCRIPTION:		
GB	POLK @ CULLEN WB B	JS STOP	
CK'D BY:			
JL	JL PAVING DETAIL		
SCALE:			
1"=10'			
DATE:	APPROVED BY:		
4/12/2019			
		SHEET NO:	
		334	

DATE:4/12/2019 FILE:E:\Dropbox

SECTION A-A

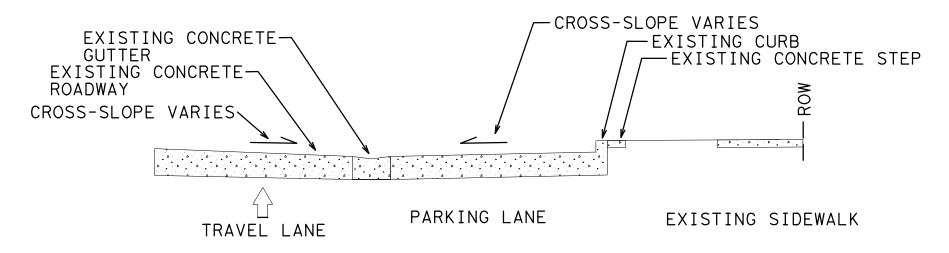

EXISTING SECTION N.T.S.

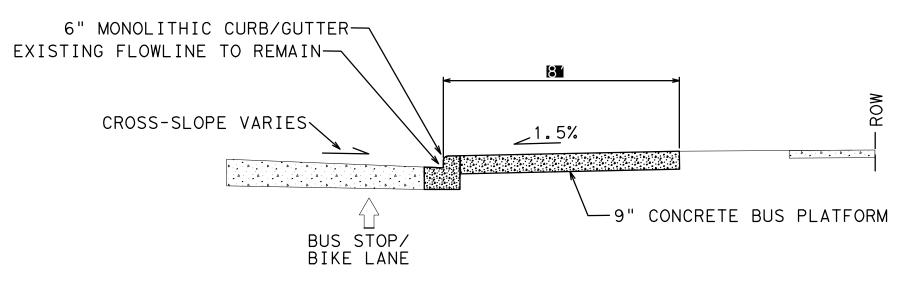

ST. CHARLES EB BUS PLATFORM N.T.S.

NOTE: SEE PAVING SHEETS FOR DIMENSIONS



NO.	REVISIONS	DATE	NAME




801 Congress Avenue, Suite 325, Houston, TX 77002 TEL (713) 270-8145/FAX (281) 809-0807 TBPE Registration No. F-3158




ROJECT TITL	ROJECT TITLE:			
	LK STREET ON-STREET BIKE	WAY		
RAWN BY:	SHEET DESCRIPTION:			
GB	BUS PLATFORM SECTION	ON A-A		
K'D BY:				
JL				
CALE:				
NONE				
ATE:	APPROVED BY:			
4/12/2019				
		SHEET NO:		
		335		

SECTION B-B

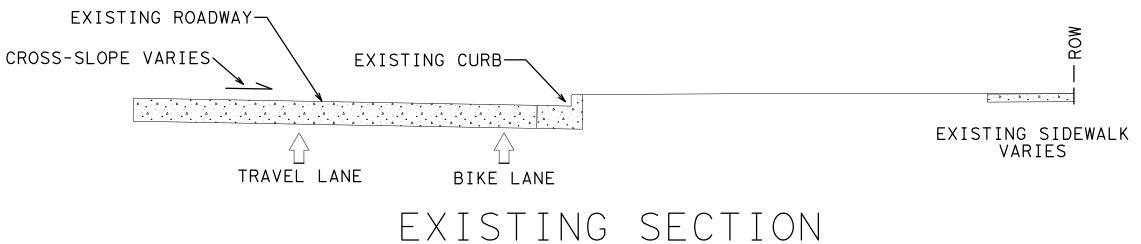



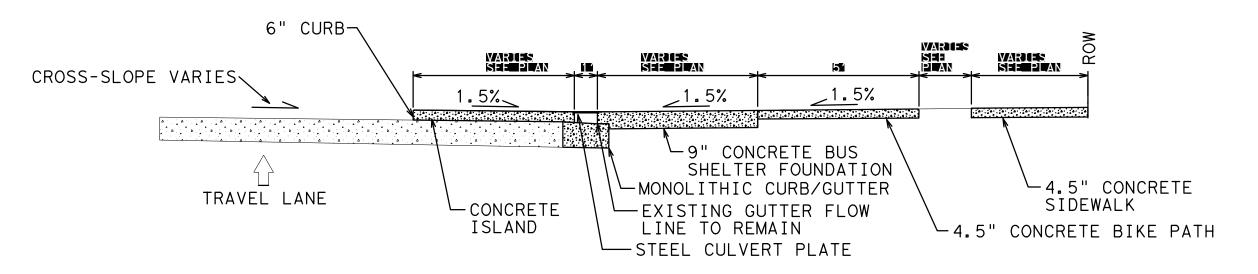

TYPICAL BUS PLATFORM N.T.S.

NOTE: SEE PAVING SHEETS FOR DIMENSIONS



NO.	REVISIONS	DATE	NAME




TEL (713) 270–8145/FAX (281) 809–0807
TBPE Registration No. F–3158




ROJECT TITL	E:	
	LK STREET ON-STREET BIKE	WAY
RAWN BY:	SHEET DESCRIPTION:	
GB	BUS PLATFORM SECTION	ON B-B
K'D BY:		
JL		
CALE:		
NONE		
ATE:	APPROVED BY:	
4/12/2019		
•		SHEET NO:
		336

SECTION C-C

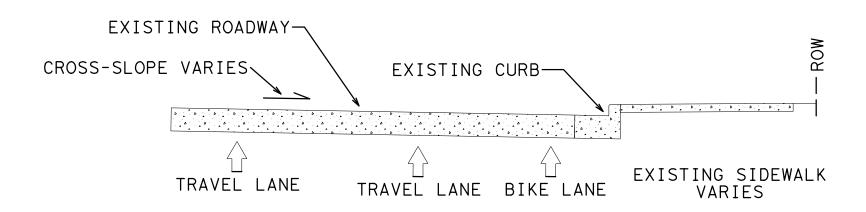

EXISTING SECTION N.T.S.

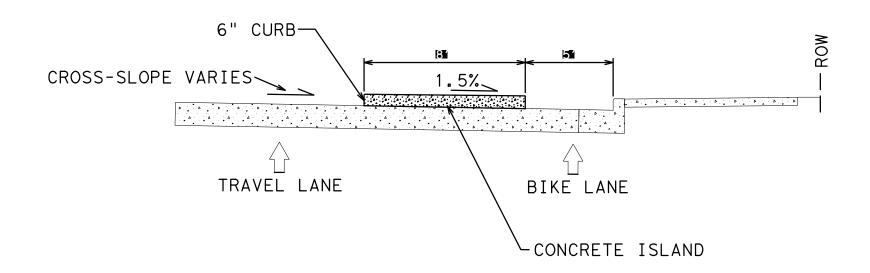

SCOTT EB BUS PLATFORM N.T.S.

NOTE: SEE PAVING SHEETS FOR DIMENSIONS



NO.	REVISIONS	DATE	NAME




801 Congress Avenue, Suite 325, Houston, TX 77002 TEL (713) 270-8145/FAX (281) 809-0807 TBPE Registration No. F-3158




ROJECT TITL	E:	
PO	LK STREET ON-STREET BIKE	WAY
RAWN BY:	SHEET DESCRIPTION:	
GB	BUS PLATFORM SECTION	ON C-C
K'D BY:		
JL		
CALE:		
NONE		
ATE:	APPROVED BY:	
4/12/2019		
•		SHEET NO:
		337

SECTION D-D

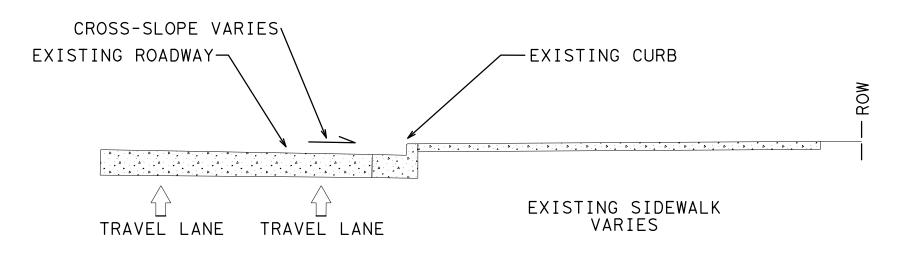

EXISTING SECTION N.T.S.

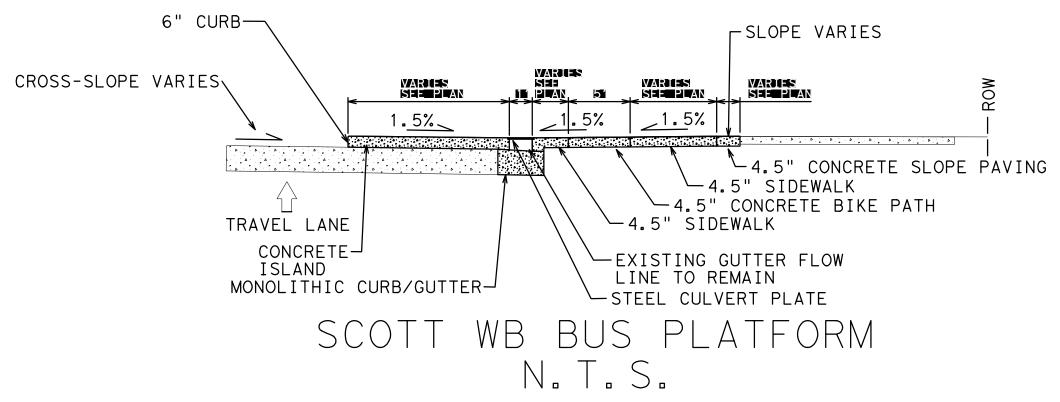

NOTE: SEE PAVING SHEETS FOR DETAILS



NO.	REVISIONS	DATE	NAME




801 Congress Avenue, Suite 325, Houston, TX 77002 TEL (713) 270-8145/FAX (281) 809-0807 TBPE Registration No. F-3158




PROJECT TITL		
	LK STREET ON-STREET BIKE	EWAY
DRAWN BY:	SHEET DESCRIPTION:	
GB	BUS PLATFORM SECTION	ON D-D
CK'D BY:		
JL		
SCALE:		
NONE		
DATE:	APPROVED BY:	
4/12/2019		
		SHEET NO:
		338

SECTION E-E

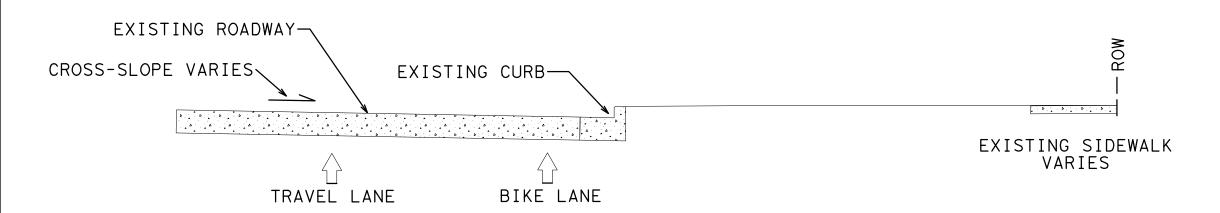

EXISTING SECTION N.T.S.

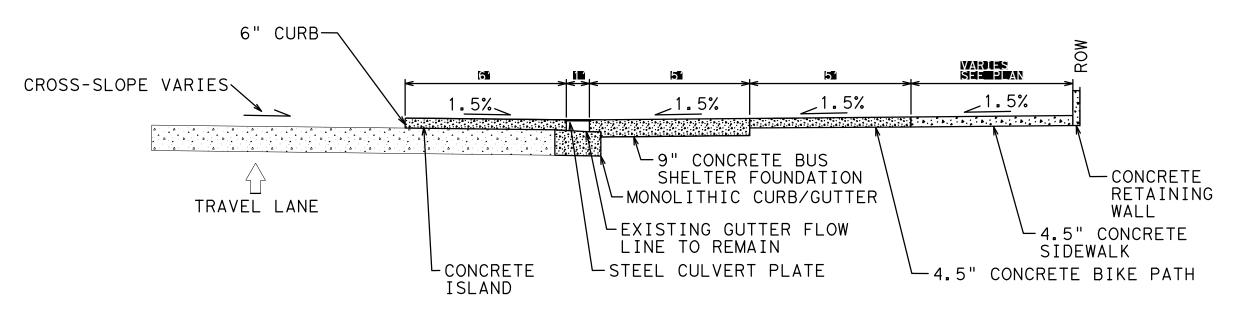

CULLEN EB BUS PLATFORM N.T.S.

NOTE: SEE PAVING SHEETS FOR DIMENSIONS



NO.	REVISIONS	DATE	NAME




801 Congress Avenue, Suite 325, Houston, TX 77002 TEL (713) 270-8145/FAX (281) 809-0807 TBPE Registration No. F-3158




ROJECT TITLE:										
POLK STREET ON-STREET BIKEWAY										
RAWN BY:	SHEET DESCRIPTION:									
GB	BUS PLATFORM SECTI	ON E-E								
K'D BY:										
JL										
CALE:										
NONE										
ATE:	APPROVED BY:									
4/12/2019										
		SHEET NO:								
		770								

SECTION F-F

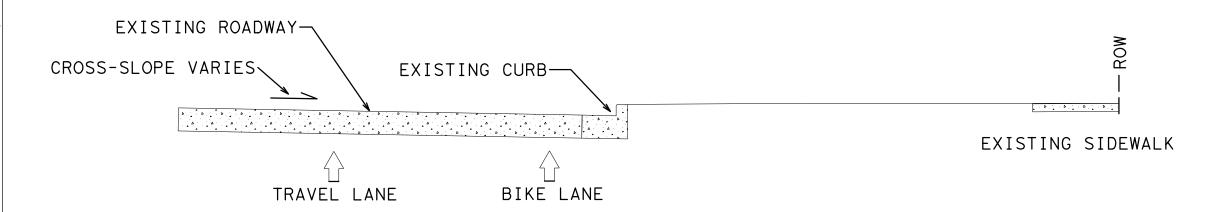

EXISTING SECTION N.T.S.

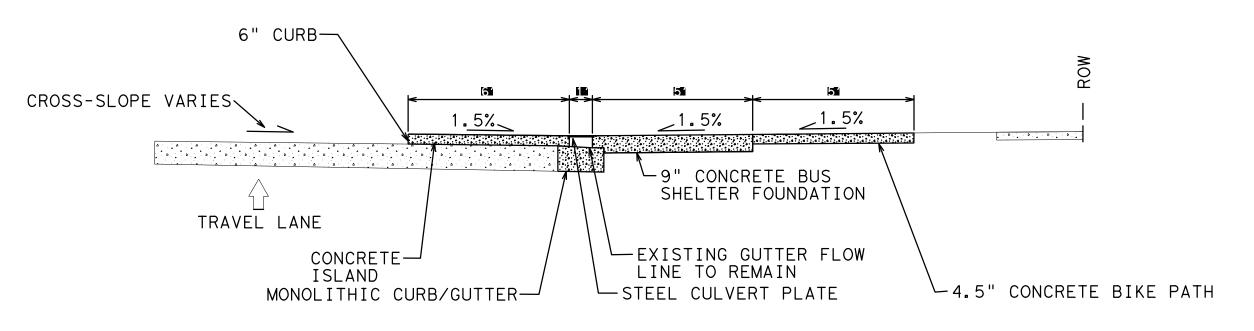

CULLEN WB BUS PLATFORM N.T.S.

NOTE: SEE PAVING SHEETS FOR DIMENSIONS




NO.	REVISIONS	DATE	NAME



801 Congress Avenue, Suite 325, Houston, TX 77002 TEL (713) 270-8145/FAX (281) 809-0807 TBPE Registration No. F-3158



DJECT TITLE:								
	LK STREET ON-STREET BIKE	WAY						
AWN BY:	SHEET DESCRIPTION:							
GB	BUS PLATFORM SECTION	ON F-F						
D BY:								
JL								
ALE: NONE								
TE: /12/2019	APPROVED BY:							
		SHEET NO:						
		740						

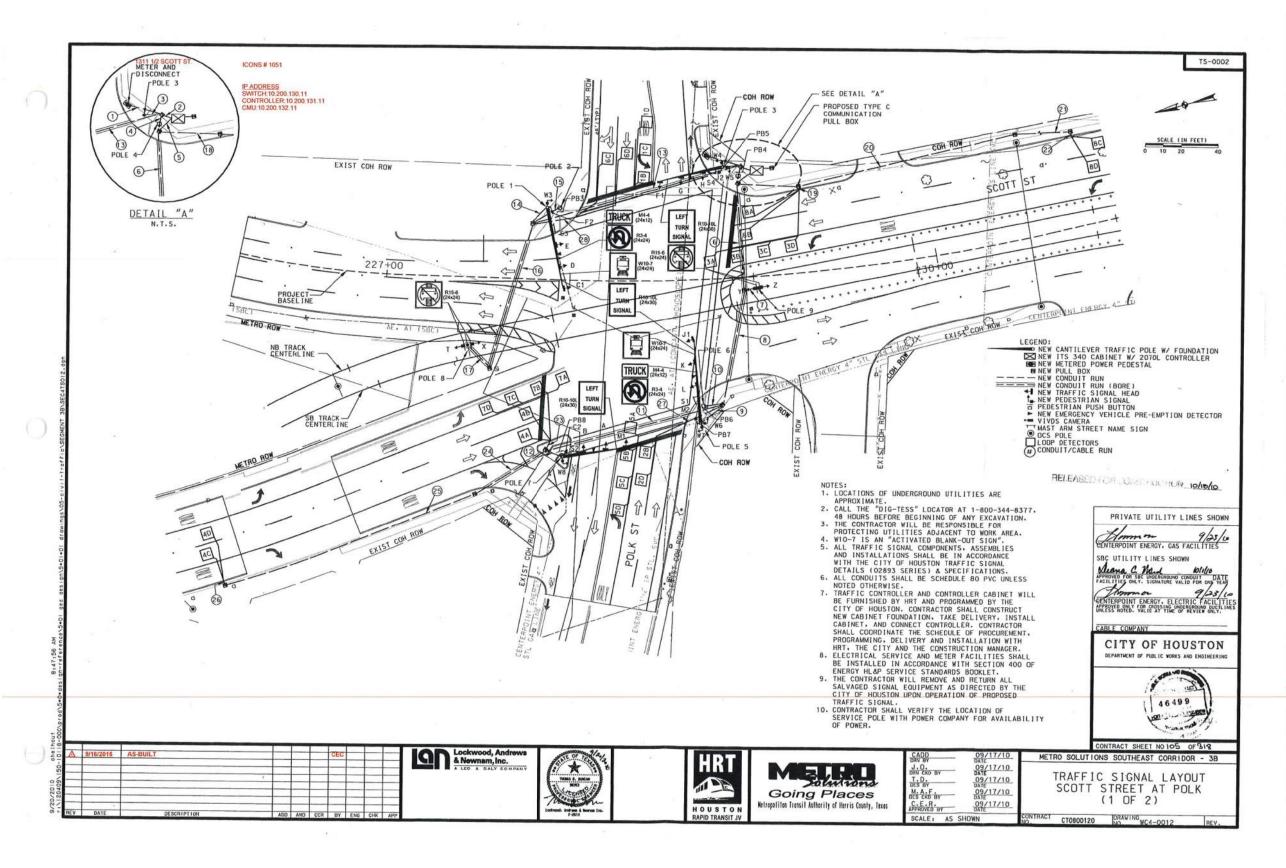

PENTABLE: HC-Bikeways. +bl

USER: /USER/

12:54:28 F (Traffic Engineer



Two Wante PEI TO 04/12/2019

NO.	REVISIONS	DATE	NAME



801 Congress Avenue, Suite 325, Houston, TX 77002 TEL (713) 270-8145/FAX (281) 809-0807 TBPE Registration No. F-3158




HARRIS COUNTY

ENGINEERING DEPARTMENT

PROJECT TITLE:									
	POLK STREET ON-STREET BIKEWAY								
DRAWN BY:	SHEET DESCRIPTION:								
DQ	POLK ST AT SCOT	r st							
CK'D BY:									
JL	EXISTING TRAFFIC SIGNA	L LAYOUT							
SCALE:									
NONE	SHEET 1 OF 1								
DATE:	APPROVED BY:								
4/12/2019									
	-	SHEET NO:							

400

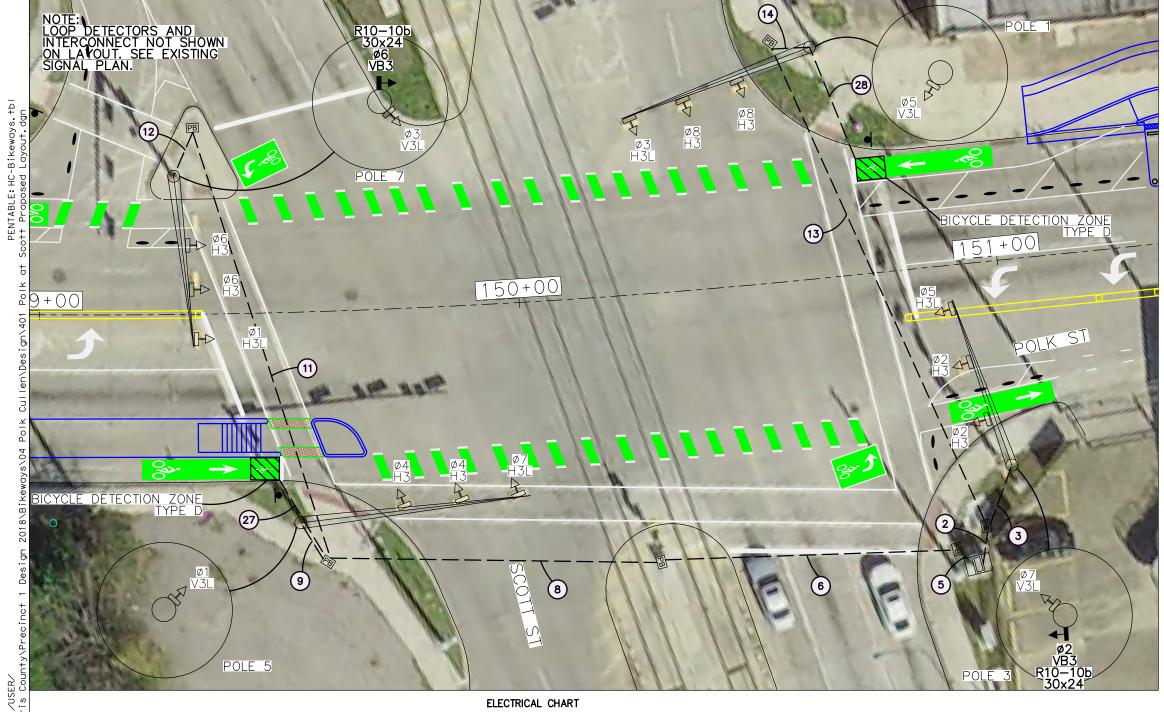

	ITEM	RUN NUMBER	1	2	3	4	(5)	6	7	8	9	10	①	12	(3)	14)	(15)	(16)	17)	(18)	(19)	20	(21)	(22)	23	24)	25)	26	Ø	28)
	POWER GROUND PED. PUSH BUTTON PED./TAIN/BLINKOUT VEHICLE SIGNAL VIVIDS CABLE VIVIDS POWER	#6 TXHHW #8 BARE COPPER 3/C #14 5/C #14 7/C #14 RG-59 COAX 3/C-#16	5 1	5 2 3 5 8	1 2 3	1	3 4 8	3 4 8	1 2	3 4 6	1 3 3	1	1 1 1 3	1 1 1 3	1 1 3 5	1 3 3	1	1 2	1 2	1	1	1	1	1	1	1	1	1	1	1
EXISTING	EMER. PRE-EMPTION LOOP DETECTOR	3/C SHIELDED #14 2/C-#14 SHIELDED		8	1		24	16		16	1		8	1	8	1					12	2	2	4	12	2	2	4	16	16
	CONDUIT	1" PVC (SCHD. 80) 2" PVC (SCHD. 80) 2" RMC (BORE) 3" PVC (SCHD. 80)	1	2	1	1	2		1		1	1		1		1	1		1	1	1	1	1	1	1	1	1	1	1	1
	VEHICLE SIGNAL	3" RMC (BORE) 4" PVC (SCHD. 80) 2" RMC (BORE)		1	1		2	1		1			1	1	1			1												
PROPOSED	14 AWG IMSA 51-5-1985			1			1	1		1					1	1													1	1

DATE:4/12/2019 FILE:E:\Dropbo>

NOTE:
EXISTING WIRING SHOWN IN ELECTRICAL CHART IS PER
RECORD DRAWINGS.

THE EXISTING WIRING HAS NOT BEEN FIELD VERIFIED.

POLE SCHEDULE

POLE 1 - EXISTING 42' STEEL MAST ARM & POLE POLE 3 - EXISTING 36' STEEL MAST ARM & POLE POLE 5 - EXISTING 48' STEEL MAST ARM & POLE POLE 7 - EXISTING 36' STEEL MAST ARM & POLE

ITS NOTES

ANY INTERRUPTION OF ITS OPERATIONS REQUIRES CITY OF HOUSTON TRANSPORTATION & DRAINAGE OPERATIONS / ITS SECTION APPROVAL AT A MINIMUM OF ONE (1) WEEK IN ADVANCE AT 713-881-3172 OR 713-881-3179.

ALL EXISTING ITS INFRASTRUCTURE AND TRAFFIC SIGNAL COMMUNICATIONS SHALL BE KEPT OPERATIONAL DURING

ANY QUESTIONS OR CONCERNS RELATED TO DEPLOYMENT OF ANY ITS DEVICE SHALL CALL CITY OF HOUSTON TRANSPORTATION AND DRAINAGE OPERATIONS / ITS SECTION AT 713-881-3172 OR 713-881-3179.

ALL ITS DEVICES REMOVED SHALL BE GIVEN TO TRANSPORTATION & DRAINAGEOPERATIONS / ITS SECTION STAFF IMMEDIATELY UPON REMOVAL.

EXISTING SIGNAL HEAD SCHEDULE



Н3



H3L





V3L PROPOSED SIGNAL HEAD SCHEDULE



VB3





NO.	REVISIONS	DATE	NAME



TRAFFIC ENGINEERS, INC innovative transportation solutions

801 Congress Avenue, Suite 325, Houston, TX 77002 TEL (713) 270-8145/FAX (281) 809-0807 TBPE Registration No. F-3158




HARRIS COUNTY


401

ENGINEERING DEPARTMENT


PROJECT TITLE:									
	LK STREET ON-STREET BIKEWAY								
DRAWN BY:	SHEET DESCRIPTION:								
DQ	POLK ST AT SCOTT ST								
CK'D BY:									
JL	PROPOSED TRAFFIC SIGNAL LAYOUT								
SCALE: 1"=20'	011557 4 05 4								
	SHEET 1 OF 1								
DATE:	APPROVED BY:								
4/12/2019									
	SHEET NO:								

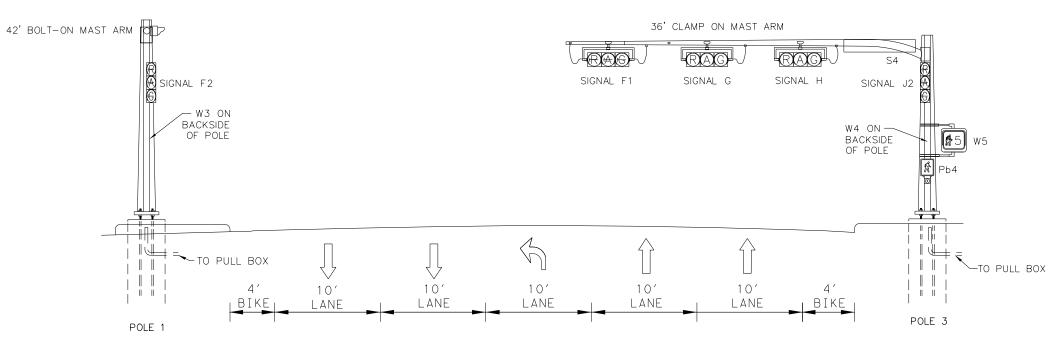

EXISTING EASTBOUND POLK ST AT SCOTT ST

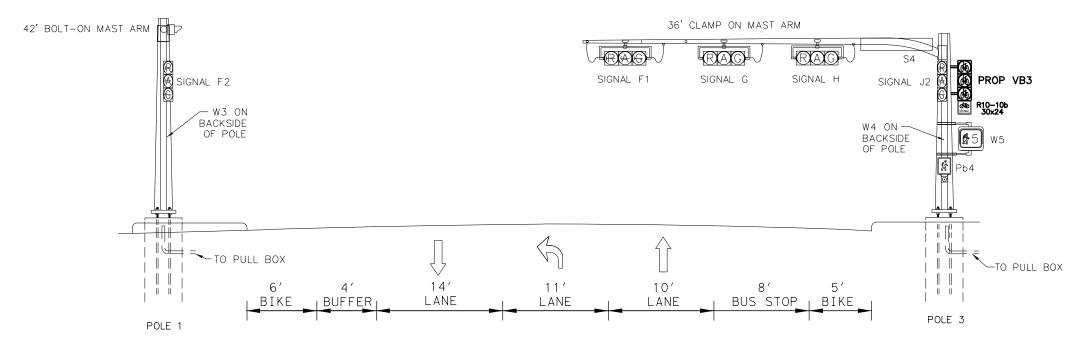

PROPOSED EASTBOUND POLK ST AT SCOTT ST

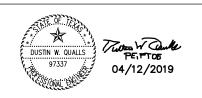

NO.	REVISIONS	DATE	NAME







HARRIS COUNTY ENGINEERING DEPARTMENT

PROJECT TITLE:				
POLK STREET ON-STREET BIKEWAY				
DRAWN BY:	SHEET DESCRIPTION:			
DQ	POLK ST AT SCOT	T ST		
CK'D BY:				
JL	PROPOSED SIGNAL ELE	EVATION		
SCALE: "=10'(H),NTS(V)	SHEET 1 OF 2			
	APPROVED BY:			
4/12/2019				
		SHEET NO:		

402

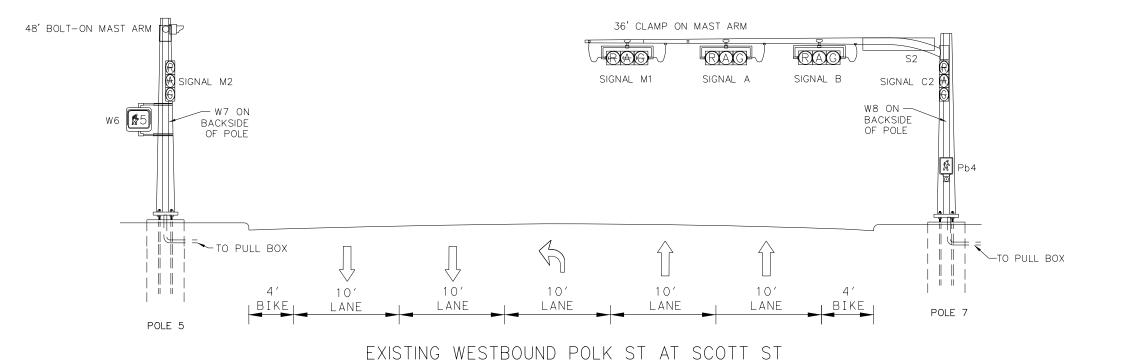

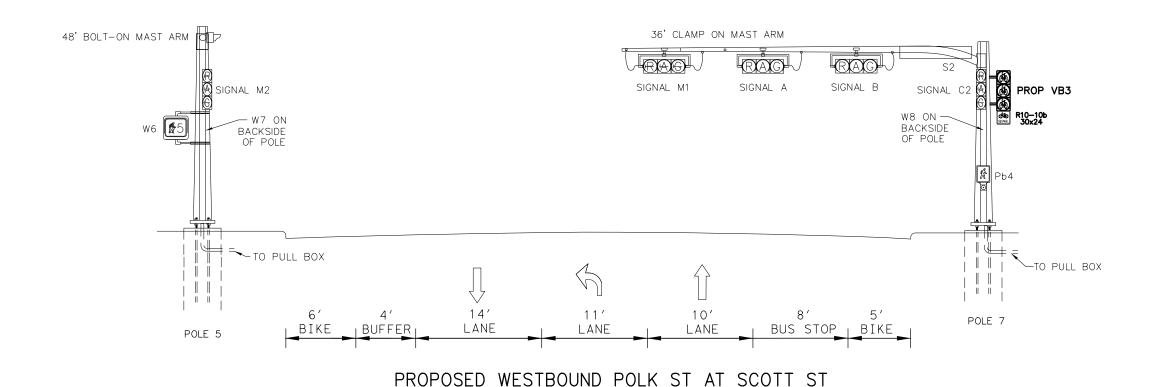



NO.	REVISIONS	DATE	NAME







HARRIS COUNTY ENGINEERING DEPARTMENT


PROJECT TITLE:		
POLK STREET ON-STREET BIKEWAY		
DRAWN BY:	SHEET DESCRIPTION:	
DQ	POLK ST AT SCOTT ST	
CK'D BY:		
JL	PROPOSED SIGNAL ELEVATION	
SCALE:		
1"=10'(H),NTS(V)		
	APPROVED BY:	
1 /12 /2010		

2/2019

SHEET NO: 403

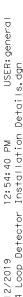

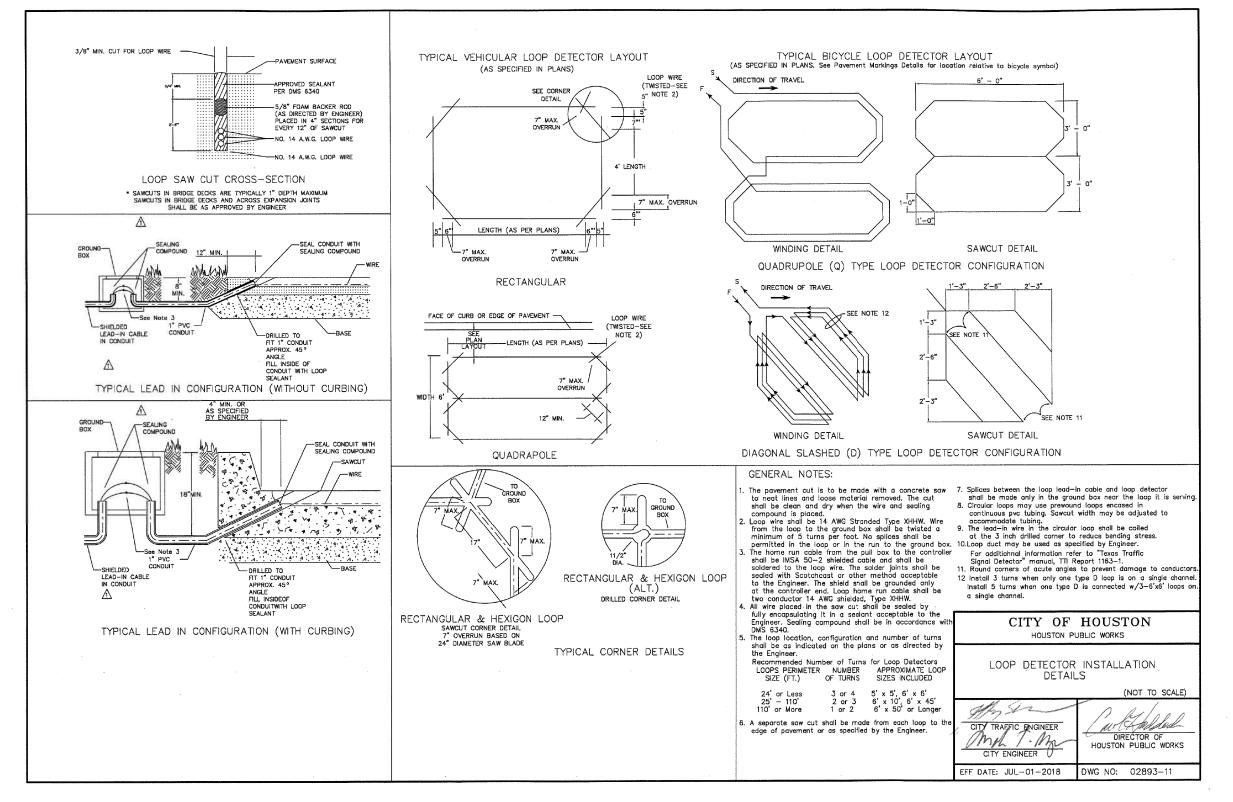

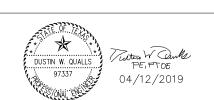

NO.	REVISIONS	DATE	NAME

TEI TRAFFICENGINEERS, INC innovative transportation solutions

801 Congress Avenue, Suite 325, Houston, TX 77002 TEL (713) 270-8145/FAX (281) 809-0807 TBPE Registration No. F-3158



PROJECT TITLE:				
POLK STREET ON-STREET BIKEWAY				
DRAWN BY:	SHEET DESCRIPTION:			
GB	LOOP DETECTOR INSTALLAT	TION DETAILS		
CK'D BY:				
JL				
SCALE:				
NONE				
DATE:	APPROVED BY:			
4/12/2019				
	-	SHEET NO:		
		404		

TRAFFIC SIGNAL GENERAL NOTES:

- 1. ALL EQUIPMENT / MATERIALS AND CONSTRUCTION SHALL MEET OR EXCEED THE REQUIREMENTS CONTAINED IN THE CURRENT CITY OF HOUSTON STANDARD SPECIFICATIONS AND STANDARD DRAWINGS, THE PROJECT SPECIFIC SPECIFICATIONS AND THE PLANS.
- 2. ALL ELECTRICAL WORK SHALL BE IN CONFORMANCE WITH THE PROVISIONS AND REQUIREMENTS OF THE CITY ELECTRICAL CODE.
- 3. ALL SIGNS SHALL BE MANUFACTURED IN ACCORDANCE WITH THE TEXAS MANUAL ON UNIFORM TRAFFIC CONTROL DEVICES.
- 4. THE CONTRACTOR SHALL ARRANGE THE INSTALLATION OF SIGNALS, POLES AND CONDUIT SO AS TO PERMIT THE CONTINUOUS MOVEMENT OF TRAFFIC IN ALL DIRECTIONS AT ALL TIMES. THE CONTRACTOR SHALL NOT CLOSE MORE THAN ONE LANE OF A ROADWAY AT ONE TIME WITHOUT PRIOR APPROVAL OF THE CITY.
- 5. THE CONTRACTOR SHALL CLEAN UP AND REMOVE FROM THE WORK AREA ALL LOOSE MATERIAL RESULTING FROM CONTRACT OPERATIONS EACH DAY PRIOR TO WORK BEING SUSPENDED FOR THAT DAY.
- 6. THE CONTRACTOR SHALL CONTACT THE ENGINEER AND/OR THE APPROVED CITY OF HOUSTON REPRESENTATIVE TO ARRANGE FOR METER AND ELECTRICAL SERVICE CONNECTION FROM THE POWER COMPANY.
- 7. ALL PEDESTRIAN PUSH BUTTON ASSEMBLIES SHALL MEET ADA REQUIREMENTS. THE SIGNS THAT SHALL BE USED ARE IDENTIFIED IN THE TMUTCD AS R10-3E. CITY OF HOUSTON STANDARDS FOR PEDESTRIAN FACILITIES SHALL BE MET IN ADDITION TO ANY TEXAS ACCESSIBILITY STANDARDS BY THE TEXAS DEPARTMENT OF LICENSING AND REGULATION (TDLR).
- 8. PEDESTRIANS PUSH BUTTONS SHALL BE SEPARATED BY A MINIMUM OF 10 FEET. EXCEPTIONS ONLY AS SPECIFIED BY THE ENGINEER WITH AUTHORIZATION FROM THE APPROVED CITY OF HOUSTON REPRESENTATIVE.
- 9. OVERHEAD STREET NAME SIGNS SHALL BE INSTALLED SUCH THAT THE BOTTOM OF THE SIGN IS NO LESS THAN 17 FEET ABOVE THE ROADWAY PAVEMENT OR NO LESS THAN 16 FEET ABOVE THE FINISHED GRADE BEYOND THE SHOULDER.
- 10. THE LOCATION OF EACH NEW POLE FOUNDATION, PULL BOX, CONTROLLER CABINET FOUNDATION, UPS CABINET FOUNDATION AND ELECTRIC SERVICE PEDESTAL FOUNDATION SHALL BE MARKED IN THE FIELD AS SHOWN ON THE PLANS. THE EXACT LOCATION SHALL BE APPROVED BY THE ENGINEER AND/OR THE APPROVED CITY OF HOUSTON REPRESENTATIVE PRIOR TO BEGINNING INSTALLATION OF THE FOUNDATION.
- 11. NO POLES SHALL BE LOCATED IN WHEELCHAIR RAMPS OR SUCH THAT THEY ARE AN OBSTRUCTION TO PEDESTRIANS OR WHEELCHAIRS.
- 12. THE TOP OF THE POLE FOUNDATION SHALL BE LEVELED WITH THE FINISHED GRADE. IF THE SLOPE OR SHOULDER DROPS OFF FROM FINISHED GRADE, THE CONTRACTOR SHALL GRADE AROUND POLE FOUNDATION. THE TOP OF THE FOUNDATION SHALL EXTEND NO MORE THAN 4 INCHES ABOVE SURROUNDING GRADE. GROUTING SHALL BE USED TO FILL ANY GAP BETWEEN THE POLE BASE AND FOUNDATION.
- 13. POLES SHALL BE LOCATED SUCH THAT ALL PORTIONS OF THE POLES AND ATTACHED EQUIPMENT HAVE CLEARANCES FROM OVERHEAD UTILITIES IN ACCORDANCE WITH THE REQUIREMENTS OF THE LOCAL UTILITY AND THE NATIONAL ELECTRICAL SAFETY CODE (NESC).
- 14. ALL CONCRETE USED FOR TRAFFIC SIGNAL POLE AND CABINET FOUNDATIONS SHALL BE CLASS "A" (REFER TO THE CITY OF HOUSTON SPECIFICATION FOR CONCRETE).
- 15. MAST ARM AND STRAIN POLES SHALL NOT BE INSTALLED ON THE FOUNDATIONS LESS THAN SEVEN DAYS AFTER THE PLACEMENT OF THE CONCRETE FOR THE FOUNDATION.
- 16. ANCHOR BOLTS FOR SIGNAL POLES SHALL BE SET SO THAT TWO ARE IN COMPRESSION AND TWO ARE IN TENSION. PRIOR TO THE INSTALLATION OF THE NUT, THE THREADS OF THE ANCHOR BOLT SHALL BE COATED WITH PIPE JOINT COMPOUND.

- 17. ALL UNDERGROUND CONSTRUCTION (CONDUIT, FOUNDATIONS AND PULL BOXES) FOR THE INTERSECTION SHALL BE COMPLETED PRIOR TO THE INSTALLATION OF POLES, SIGNALS AND CABINETS. THE CONTRACTOR SHALL NOT PROCEED TO ABOVE GROUND WORK UNTIL THE ENGINEER AND/OR APPROVED CITY OF HOUSTON REPRESENTATIVE HAD CONFIRMED THAT THE MATERIALS FOR A COMPLETE INSTALLATION ARE AVAILABLE.
- 18. UNDERGROUND CONDUIT FOR SIGNAL CABLE SHALL BE EITHER RIGID STEEL, HOT-DIPPED GALVANIZED CONDUIT OR SCHEDULE 80 ELECTRICAL PVC CONDUIT OF THE DIAMETER SHOWN ON THE PLANS, UNLESS OTHERWISE NOTED. ALL COUPLINGS AND CONNECTIONS SHALL BE TIGHT AND WATERPROOF.
- 19. ALL ABOVE GROUND CONDUIT FOR SIGNAL CABLE AND INTERCONNECT MEDIA SHALL BE HOT DIPPED GALVANIZED STEEL RIGID METAL CONDUIT OF THE DIAMETERS SHOWN ON THE PLANS, UNLESS OTHERWISE NOTED. ALL COUPLINGS AND CONNECTIONS SHALL BE TIGHT AND WATERPROOF.
- 20. ONLY NEW CONDUIT AND CABLE SHALL BE INSTALLED.
- 21. CONDUIT INSTALLED UNDER EXISTING PAVED DRIVEWAYS, ROADWAYS OR SIDEWALKS, WHICH ARE NOT SCHEDULED TO BE RECONSTRUCTED AS PART OF THIS PROJECT, SHALL BE INSTALLED BY MEANS OF BORING. THE CONTRACTOR SHALL NOT CUT OPEN ANY STREET OR DRIVEWAY FOR CONDUIT INSTALLATION WITHOUT THE PRIOR APPROVAL OF THE ENGINEER AND/OR THE APPROVED CITY OF HOUSTON REPRESENTATIVE.
- 22. CONDUIT NOT PLACED UNDER PAVED DRIVEWAYS, ROADWAY PAVEMENT OR SIDEWALK MAY BE PLACED BY CUTTING A TRENCH, INSTALLING THE CONDUIT AND BACKFILLING. ANY TRENCHING FOR CONDUIT WIDER THAN THREE (3) INCHES SHALL BE RESODDED.
- 23. PULL BOXES SHALL NOT BE INSTALLED WITHIN CONCRETE CURB ACCESS RAMPS. IN ADDITION, ANY PULL BOXES INSTALLED BEHIND CURBS SHALL BE INSTALLED BETWEEN THE CURB AND THE PROPOSED / FUTURE SIDEWALK OR BEYOND THE PROPOSED / FUTURE SIDEWALK. AN EXCEPTION TO THIS NOTE WOULD BE PULL BOXES INSTALLED IN A MEDIAN. ANY PULL BOXES INSTALLED ALONG AN UNCURBED ROADWAY SHALL BE INSTALLED ADJACENT TO, BUT NOT WITHIN, THE SHOULDER. DRAINAGE AREAS SHOULD BE AVOIDED WHEN PLACING JUNCTION BOXES.
- 24. A 5/8 IN. X 10 FT. GROUND ROD SHALL BE INSTALLED IN THE NO. 7 PULL BOX LOCATED ON EACH CORNER. TWO GROUND ROD CLAMPS SHALL BE FURNISHED FOR GROUNDING THE GROUND WIRE.
- 25. ALL CONDUITS SHALL BE CLEANED BY COMPRESSED AIR AND A PROPERLY SIZED CONDUIT PISTON OR MANDREL SHALL BE PULLED THROUGH THE CONDUIT PRIOR TO CABLE INSTALLATION.
- 26. WHEN PULLING TRAFFIC SIGNAL SYSTEM CABLES THROUGH CONDUIT, THE CABLES SHALL BE LUBRICATED WITH A LUBRICANT NORMALLY USED FOR THIS PURPOSE. ANY ABRASION TO ANY CONDUCTOR INSULATION WHICH OCCURS WHILE PULLING CABLE FOR THE TRAFFIC SIGNAL SYSTEM WILL BE CAUSE FOR THE IMMEDIATE REJECTION OF THE CABLE. IF THIS OCCURS, THE CONTRACTOR SHALL REMOVE AND REPLACE THE ENTIRE CABLE RUN AT THEIR EXPENSE.
- 27. A MINIMUM OF THREE (3) FEET OF EACH WIRE AND CABLE MEASURED FROM THE TOP OF THE PULL BOX SHALL BE LEFT IN EACH PULL BOX AND AT EACH POLE BASE.
- 28. ALL CABLES SHALL BE STRIPPED, FORMED AND TERMINATED IN A NEAT AND UNIFORM MANNER WHETHER IN THE SIGNAL HEAD OR CONTROLLER CABINET. ALL CABLE SHALL BE BROUGHT INTO THE TERMINAL HOUSING OF SIGNALS AND/OR CONTROLLER CABINETS AND A SUFFICIENT LENGTH OF CABLE SHALL BE LEFT SO THAT ALL TERMINAL CONNECTIONS MAY BE MADE WITHOUT THE NECESSITY OF SPLICING THE CABLE.
- 29. THE HIGH VOLTAGE CABLES SHOULD BE SEPARATED FROM THE LOW VOLTAGE CABLES AS MUCH AS POSSIBLE.
- 30. NO LOOP DETECTOR SHALL BE CUT IN A PARALLEL EXPANSION JOINT. LOOPS CUT ACROSS EXPANSION JOINTS SHALL HAVE A SLACK IN THE CABLE FOR EXPANSION.
- 31. ALL VEHICLE ROADWAY DETECTION LOOP CABLES SHALL BE #14 AWG IMSA 51-5-1985 CABLE. LEAD-IN CABLES SHALL BE #16 AWG IMSA 50-2-1984 CABLE. NO SPLICES SHALL BE ALLOWED IN THE ROADWAY DETECTION LOOP CABLE EXCEPT AT THE PULL BOX ADJACENT TO LOOP. THE DETECTOR LEAD-IN CABLE SHALL NOT BE SPLICED.

- 32. DETECTION LOOP SAW CUTS SHALL BE FLUSHED WITH WATER UNDER PRESSURE AND THEN DRIED WITH AIR UNDER PRESSURE.
- 33. THERE SHALL BE NO SPLICING IN CONDUCTORS EXCEPT FOR THE NECESSARY SPLICE BETWEEN ROADWAY LOOP WIRE AND DETECTOR LEAD-IN CABLE IN THE PULL BOX ADJACENT TO THE DETECTOR. THESE SPLICES SHALL BE WATERPROOF AND SHALL BE IN COMPLIANCE WITH THE CITY OF HOUSTON STANDARD DRAWINGS FOR TRAFFIC SIGNAL CONSTRUCTION. THESE SPLICES SHALL BE MADE BY THE CONTRACTOR. DO NOT GROUND THE CABLE SHIELD AT THE PULL BOX.
- 34. TWO #10 AWG-XHHW CONDUCTORS SHALL BE INSTALLED FROM EACH LUMINAIRE TO THE CONTROLLER CABINET, LEAVING THREE FEET OF SLACK FOR EACH CONDUCTOR (MEASURED FROM THE TOP OF THE PULL BOX) IN EACH PULL BOX. ROUTE FOUR CONDUCTORS TO THE LUMINAIRE WITH THE PHOTOELECTRIC CELL. AN IN-LINE FUSE SHALL BE INSTALLED FOR EACH LUMINAIRE IN THE ASSOCIATED PULL BOX.
- 35. THE EMERGENCY VEHICLE PRE-EMPTION SENSOR CABLE SHALL BE OPTICOM DETECTOR CABLE MODEL NO. 138. THE CABLE SHALL NOT BE SPLICED.
- 36. ALL VEHICLE AND PEDESTRIAN INDICATIONS SHALL BE LED.
- 37. THE CONTRACTOR SHALL BAG ALL NEWLY INSTALLED VEHICULAR AND/OR PEDESTRIAN TRAFFIC SIGNAL HEADS WITH BURLAP OR OTHER APPROVED MATERIAL UNTIL THE FINAL INSPECTION AND ACCEPTANCE BY THE CITY TRAFFIC ENGINEER AND/OR APPROVED CITY OF HOUSTON REPRESENTATIVE. THE BURLAP OR OTHER APPROVED MATERIAL/DEVICE SHALL COMPLETELY COVER THE TRAFFIC SIGNAL HEAD AND SHALL OBSCURE THE VIEW OF THE TRAFFIC SIGNAL INDICATIONS SO THAT THEY CANNOT BE SEEN UNTIL THE TRAFFIC SIGNAL IS PLACED IN OPERATION. DURING CONSTRUCTION, THE TRAFFIC SIGNAL WILL BE DE-ENERGIZED WHILE NOT IN USE FOR TESTING.
- 38. THE TRAFFIC SIGNAL OPERATION AT EXISTING SIGNALIZED INTERSECTIONS SHALL BE MAINTAINED THROUGHOUT THE DURATION OF THE PROJECT.
- 39. ALL STRIPING AND PAVEMENT MARKINGS ARE TO BE DONE UNDER THIS CONTRACT AND SHALL BE IN PLACE PRIOR TO THE ACTIVATION OF THE TRAFFIC SIGNAL. THE CONTRACTOR SHALL VERIFY THE LOCATION OF ALL STOP LINES PRIOR TO THE INSTALLATION OF LOOP DETECTORS.
- 40. ALL CROSSWALK MARKINGS SHALL BE 10-FT. WIDE FOLLOWING CITY OF HOUSTON STANDARD DETAILS
- 41. ALL CONSTRUCTION SIGNING AND CONSTRUCTION TRAFFIC CONTROL DEVICES SHALL BE IN CONFORMANCE WITH THE TEXAS MANUAL ON UNIFORM TRAFFIC CONTROL DEVICES.



NO.	REVISIONS	DATE	NAME



801 Congress Avenue, Suite 325, Houston, TX 77002 TEL (713) 270-8145/FAX (281) 809-0807 TBPE Registration No. F-3158



HARRIS COUNTY ENGINEERING DEPARTMENT PROJECT TITLE: POLK STREET ON-STREET BIKEWAY

PROJECT TITLE:
POLK STREET ON—STREET BIKEWAY

DRAWN BY: SHEET DESCRIPTION:
GB: CITY OF HOUSTON

CK'D BY:
JL TRAFFIC SIGNAL GENERAL NOTES

SCALE:
NONE SHEET 1 OF 2

DATE: 4/12/2019
SHEET NO:

405

PRIVATE UTILITY NOTES **CAUTION: SBC CABLES**

- THE LOCATION OF SBC FACILITIES ARE SHOWN IN AN APPROXIMATE WAY ONLY. THE CONTRACTOR SHALL DETERMINE THE EXACT LOCATION BEFORE COMMENCING WORK. HE AGREES TO BE FULLY RESPONSIBLE FOR ANY AND ALL DAMAGES WHICH MIGHT BE OCCASIONED BY HIS FAILURE TO EXACTLY LOCATE AND PRESERVE THESE UNDERGROUND **FACILITIES**
- THE CONTRACTOR SHALL CALL 1-800-344-8477 A MINIMUM OF 48 HOURS PRIOR TO CONSTRUCTION TO HAVE UNDERGROUND UTILITY LINES FIELD LOCATED
- WHEN EXCAVATING WITHIN EIGHTEEN (18) INCHES OF THE INDICATED LOCATION OF SBC FACILITIES, ALL EXCAVATIONS MUST BE ACCOMPLISHED USING NON-MECHANIZED EXCAVATION PROCEDURES. WHEN BORING, THE CONTRACTOR SHALL EXPOSE THE SBC FACILITIES.
- WHEN SBC FACILITIES ARE EXPOSED, THE CONTRACTOR SHALL PROVIDE SUPPORT TO PREVENT DAMAGE TO THE CONDUIT DUCTS OR CABLES. WHEN EXCAVATING NEAR TELEPHONE POLES, THE CONTRACTOR SHALL BRACE THE POLE FOR SUPPORT.

CAUTION: UNDERGROUND GAS FACILITIES

- 1. LOCATIONS OF CENTERPOINT ENERGY GAS MAIN LINES (TO INCLUDE UNIT GAS TRANSMISSION AND/OR INDUSTRIAL GAS SUPPLY CORPORATION WHERE APPLICABLE) ARE SHOWN IN AN APPROXIMATE LOCATION ONLY. SERVICE LINES ARE USUALLY NOT SHOWN, THE CONTRACTOR SHALL CONTACT LONE STAR NOTIFICATION CENTER AT (713) 223-4567 OR 1-800-669-8344 A MINIMUM OF 48 HOURS PRIOR TO CONSTRUCTION TO MAIN AND SERVICE LINES FIELD
- 2. WHEN CENTERPOINT ENERGY GAS PIPE LINE MARKINGS ARE NOT VISIBLE, CALL (713) 967-8037 (7:00 AM TO 4:30 PM) FOR STATUS OF LINE LOCATION REQUESTS BEFORE EXCAVATION BEGINS.
- WHEN EXCAVATING WITHIN EIGHTEEN (18) INCHES OF THE INDICATED LOCATION OF CENTERPOINT ENERGY GAS FACILITIES, ALL EXCAVATION MUST BE ACCOMPLISHED USING NONMECHANIZED EXCAVATION PROCEDURES.
- WHEN CENTERPOINT ENERGY GAS FACILITIES ARE EXPOSED, SUFFICIENT SUPPORT MUST BE PROVIDED TO THE FACILITIES TO PREVENT EXCESSIVE STRESS ON THE PIPING.
- THE CONTRACTOR IS FULLY RESPONSIBLE FOR ANY DAMAGES CAUSED BY HIS FAILURE TO EXACTLY LOCATE AND PRESERVE THESE UNDERGROUND FACILITIES.

WARNING: OVERHEAD ELECTRICAL FACILITIES

- OVERHEAD LINES MAY EXIST ON THE PROPERTY. WE HAVE NOT ATTEMPTED TO MARK THOSE LINES SINCE THEY ARE CLEARLY VISIBLE, BUT YOU SHOULD LOCATE THEM PRIOR TO BEGINNING ANY CONSTRUCTION. TEXAS LAW SECTION 752, HEALTH & SAFETY CODE, FORBIDS ALL ACTIVITIES IN WHICH PERSONS OR THINGS MAY COME WITHIN SIX (6) FEET OF LIVE OVERHEAD HIGH VOLTAGE LINES. PARTIES RESPONSIBLÉ FOR THE WORK, INCLUDING CONTRACTORS, ARE LEGALLY RESPONSIBLE FOR THE SAFETY OF CONSTRUCTION WORKERS UNDER THIS LAW. THIS LAW CARRIES BOTH CRIMINAL AND CIVIL LIABILITY. TO ARRANGE FOR LINES TO BE TURNED OFF OR REMOVED, CALL CENTERPOINT ENERGY ELECTRIC AT (713) 207-7777.
- CONTRACTOR TO NOTIFY LONE STAR NOTIFICATION CENTER AT (713) 223-4567, 48 HOURS BEFORE STARTING WORK IN STREET RIGHTOF-WAY OR **EASEMENTS**


RESPONSIBILITIES:

- THE CONTRACTOR SHALL SUPPLY AND INSTALL THE FOLLOWING EQUIPMENT AND MATERIALS AS SPECIFIED IN THE PLANS: STEEL POLE ANCHOR BOLTS (WITH NUTS AND WASHERS), CONCRETE POLE FOUNDATIONS WITH REINFORCEMENT (WHERE SPECIFIED), TRAFFIC SIGNAL CONTROLLER CABINET(S) WITH CONTROLLER(S) AND ALL AUXILIARY EQUIPMENT, CONTROLLER CABINET CONCRÉTE FOUNDATION(S). CONCRETE PULL BOXES, ELECTRICAL CONDUIT, GROUND RODS AND CONNECTORS, BARE BOND WIRE AND ALL OTHER CONDUCTORS, POLES, MAST ARMS, TRAFFIC SIGNALS AND MOUNTING ASSEMBLIES, PEDESTRIAN SIGNALS AND MOUNTING ASSEMBLIES, PEDESTRIAN PUSH BUTTON STATIONS WITH SIGNS, LUMINARIES, PHOTOCELLS, ELECTRIC SERVICE PEDESTAL(S) AND CONCRETE FOUNDATION(S), VIDEO DETECTION SYSTEM EQUIPMENT, VEHICLE DETECTION LOOPS, AND ALL OTHER APPURTENANCES NECESSARY FOR THE OPERATION OF THE TRAFFIC SIGNAL INSTALLATION(S), EXCEPT AS MODIFIED IN THE PLANS.
- THE CITY OF HOUSTON WILL SUPPLY AND THE CONTRACTOR SHALL INSTALL THE FOLLOWING EQUIPMENT AND MATERIALS AS SPECIFIED IN THE PLANS:


NONE

- THE CONTRACTOR SHALL DELIVER THE CONTROLLER CABINET(S) WITH THE CONTROLLER(S) AND AUXILIARY EQUIPMENT SPECIFIED IN THE PLANS TO THE CITY OF HOUSTON TRAFFIC OPERATIONS CENTER, 2200 PATTERSON STREET FOR TESTING, A MINIMUM OF THREE WEEKS PRIOR TO THE INSTALLATION(S) AT THE INTERSECTION(S). CONTACT THE TRAFFIC MAINTENANCE BRANCH AT LEAST 2 WORKING DAYS PRIOR TO THE DELIVERY OF THE CONTROLLER CABINET(S) TO THE CITY OF HOUSTON. THE CONTRACTOR SHALL PICK UP AND TRANSPORT THE CONTROLLER CABINET(S) FROM THE CITY OF HOUSTON TRAFFIC OPERATIONS CENTER TO THE INTERSECTION(S) AFTER CITY OF HOUSTON STAFF HAS TESTED THE EQUIPMENT AND APPROVED IT FOR INSTALLATION.
- THE CONTRACTOR SHALL INSTALL EACH TRAFFIC CONTROLLER CABINET ON ITS FOUNDATION AND ROUTE ALL OF THE CONDUCTORS INTO THE CONTROLLER CABINET, CONDUCTORS SHALL BE TERMINATED IN THE CABINET BY THE CONTRACTOR UNDER THE OBSERVATION OF AN APPROVED CITY OF HOUSTON REPRESENTATIVE.
- THE CONTRACTOR SHALL CAREFULLY DISASSEMBLE AND SALVAGE ALL EXISTING TRAFFIC SIGNAL AND STREET LIGHTING EQUIPMENT THAT IS NOT TO REMAIN OR BE RELOCATED. ALL OF THE EQUIPMENT TO BE INSPECTED BY TRAFFIC MAINTENANCE STAFF TO IDENTIFY SALVAGE ITEMS. ITEMS TO BE SALVAGED SHALL BE RETURNED TO THE CITY OF HOUSTON TRAFFIC OPERATIONS CENTER, 2200 PATTERSON STREET AND UNLOADED BY THE CONTRACTOR, CONTACT THE TRAFFIC MAINTENANCE BRANCH AT LEAST 2 WORKING DAYS PRIOR TO RETURNING THE EQUIPMENT, ALL NON-SALVAGE ITEMS TO BE DELIVERED BY THE CONTRACTOR TO AN APPROVED CITY OF HOUSTON RECYCLE FACILITY.
- THE CONTRACTOR SHALL SALVAGE AND REPLANT ANY LANDSCAPING VEGETATION THAT MAY BE DAMAGED BY CONSTRUCTION ACTIVITIES. THE CONTRACTOR SHALL OBTAIN PRIOR APPROVAL FROM AN APPROVED CITY OF HOUSTON REPRESENTATIVE BEFORE ANY PLANTS ARE MOVED,
- THE CONTRACTOR SHALL REPAIR/RESTORE ANY LANDSCAPE IRRIGATION COMPONENTS DAMAGED BY CONSTRUCTION ACTIVITY TO THEIR ORIGINAL CONDITION.
- THE LOCATION OF PUBLIC AND PRIVATE UTILITIES IS SHOWN IN AN APPROXIMATE LOCATION ONLY. THE CONTRACTOR SHALL DETERMINE THE EXACT LOCATIONS BEFORE COMMENCING WORK. THE CONTRACTOR SHALL BE FULLY RESPONSIBLE FOR ANY AND ALL DAMAGES TO UTILITIES THAT ARE THE RESULT OF HIS FAILURE TO EXACTLY LOCATE AND PRESERVE UNDERGROUND FACILITIES.



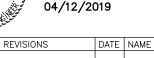

PETTOE

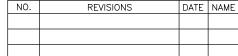



801 Congress Avenue, Suite 325, Houston, TX 77002 TEL (713) 270-8145/FAX (281) 809-0807 TBPF Registration No. F-3158



HARRIS COUNTY ENGINEERING DEPARTMENT

POLK STREET ON—STREET BIKEWAY
BY: |SHEET DESCRIPTION: DRAWN BY: CITY OF HOUSTON TRAFFIC SIGNAL GENERAL NOTES NONE SHEET 2 OF 2 APPROVED BY

SHEET NO: