HARRIS COUNTY ENGINEERING DEPARTMENT

ON-STREET BIKEWAY SIGNING AND PAVEMENT MARKINGS

HUTCHINS STREET
FROM CLEBURNE STREET TO GRAY STREET

CLEBURNE STREET
FROM LA BRANCH STREET TO HUTCHINS STREET

UPIN NO. 19101MF0ZG01

RODNEY ELLIS

PRECINCT 1

PRECINCT 2

) | | | | | | |

STEVE RADACK

COMMISSIONER

Jenemy A Chym., PE 7/15/2019

ADRIAN GARCIA

COMMISSIONER

LINA HIDALGO

COUNTY JUDGE

R. JACK CAGLE


COMMISSIONER

PRECINCT 4

JOHN R. BLOUNT, P.E. COUNTY ENGINEER





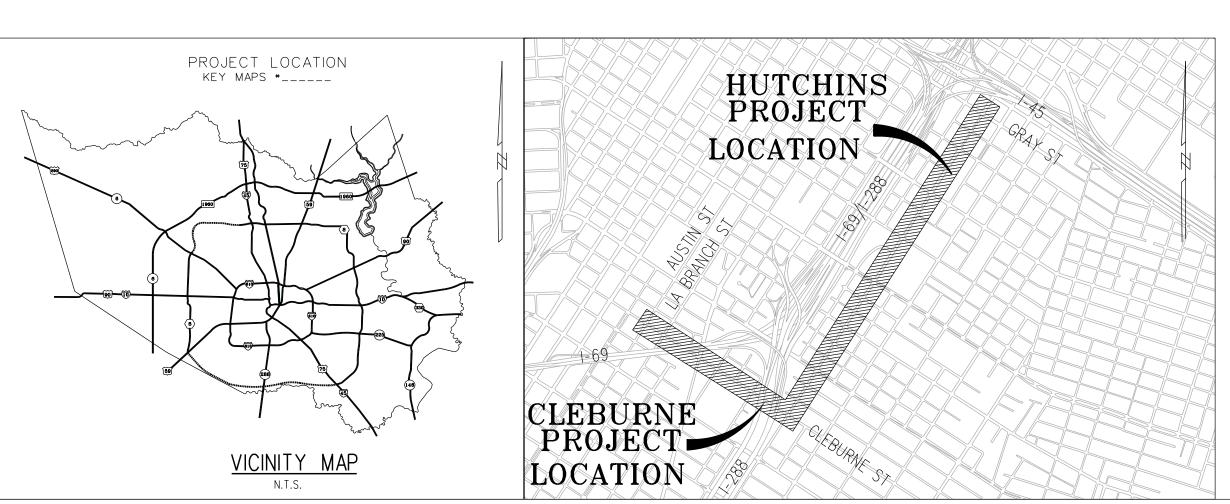



APRIL 2019 PRECINCT 1

Harris County, Texas






8484 Georgia Avenue, Suite 800, Silver Spring, MD 20910

TEL (301) 927-1900

TBPE Registration No. 14667

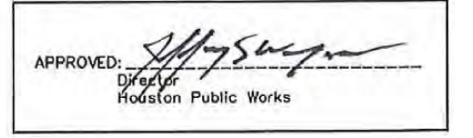

SHEET NO. 100

INDEX OF SHEETS

PAGE SHEET TITLE

- 100. COVER SHEET
- 101. INDEX OF SHEETS
- 102. PROJECT LAYOUT HUTCHINS STREET SHEET 1 OF 2
- 103. PROJECT LAYOUT CLEBURNE STREET SHEET 2 OF 2
- 104. GENERAL NOTES
- 105. REVIEW SHEET

QUANTITY SUMMARY

- 106. BASIS OF ESTIMATE HUTCHINS/CLEBURNE SHEET 1 OF 2
- 107. BASIS OF ESTIMATE CLEBURNE PAVING ONLY SHEET 2 OF 2

TRAFFIC CONTROL PLAN

108. TRAFFIC CONTROL PLAN — SINGLE LANE CLOSURE

SIGNING AND PAVEMENT MARKING PLANS


- 201. SIGNING AND PAVEMENT MARKING LAYOUT HUTCHINS STREET SHEET 1
- 202. SIGNING AND PAVEMENT MARKING LAYOUT HUTCHINS STREET SHEET 2
- 203. SIGNING AND PAVEMENT MARKING LAYOUT HUTCHINS STREET SHEET 3
- 204. SIGNING AND PAVEMENT MARKING LAYOUT HUTCHINS STREET SHEET 4
- 205. SIGNING AND PAVEMENT MARKING LAYOUT HUTCHINS STREET SHEET 5
- 206. SIGNING AND PAVEMENT MARKING LAYOUT HUTCHINS STREET SHEET 6
- 207. SIGNING AND PAVEMENT MARKING LAYOUT CLEBURNE STREET SHEET 7
- 208. SIGNING AND PAVEMENT MARKING LAYOUT CLEBURNE STREET SHEET 8
- 209. SIGNING AND PAVEMENT MARKING LAYOUT CLEBURNE STREET SHEET 9

SIGNING AND PAVEMENT MARKING DETAILS

- 301. SMALL SIGN DETAILS
- 302. SIGNING AND PAVEMENT MARKING LEGEND
- 303. HOUSTON BIKEWAYS SIGN DETAILS
- 304. PAVEMENT MARKING DETAILS SHEET 1 OF 4
- 305. PAVEMENT MARKING DETAILS SHEET 2 OF 4
- 306. PAVEMENT MARKING DETAILS SHEET 3 OF 4
- 307. PAVEMENT MARKING DETAILS SHEET 4 OF 4
- 308. CONCRETE SIDEWALK DETAILS
- 309. CURB RAMP DETAILS
- 310. PROJECT SIGN DETAIL
- 311. BUS PAD AND LANDING DETAILS
- 312. PASSENGER SHELTER FOUNDATION
- 313. LOOP DETECTOR INSTALLATION DETAILS
- 314. ADDITIONAL SIGN DETAILS

PAVING SHEETS

- 401. PAVING SHEETS HUTCHINS ST PAVING REPAIR AT TRUXILLO ST AND HOLMAN ST
- 402. PAVING SHEETS HUTCHINS ST PAVING REMOVAL AND REPAIR AT DENNIS ST AND TUAM ST
- 403. PAVING SHEETS HUTCHINS ST PAVING LAYOUT AT DENNIS ST AND TUAM ST
- 404. PAVING SHEETS HUTCHINS ST PAVING REMOVAL AND REPAIR AT GRAY ST
- 405. PAVING SHEETS HUTCHINS ST PAVING LAYOUT AT GRAY ST
- 406. PAVING SHEETS HUTCHINS ST PAVING REMOVAL AND REPAIR AT ALABAMA ST
- 407. PAVING SHEETS HUTCHINS ST PAVING LAYOUT AT ALABAMA ST
- 408. PAVING SHEETS HUTCHINS ST PAVING REMOVAL AND REPAIR AT ELGIN ST
- 409. PAVING SHEETS HUTCHINS ST PAVING REMOVAL AND REPAIR AT ELGIN ST
- 410. PAVING SHEETS CLEBURNE ST PAVING REMOVAL AND REPAIR BETWEEN LA BRANCH ST AND ALMEDA ST
- 411. PAVING SHEETS CLEBURNE ST PAVING REMOVAL AND REPAIR BETWEEN LA BRANCH ST AND ALMEDA ST
- 412. PAVING SHEETS CLEBURNE ST PAVING REMOVAL AND REPAIR BETWEEN ALMEDA ST AND HUTCHINS ST SHEET 1 OF 2
- 413. PAVING SHEETS CLEBURNE ST PAVING REMOVAL AND REPAIR BETWEEN ALMEDA ST AND HUTCHINS ST SHEET 2 OF 2
- 414. PAVING SHEETS CLEBURNE ST PAVING LAYOUT AT CHENEVERT ST AND CHARTRES ST

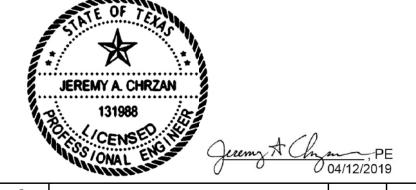

NO.	REVISIONS	DATE	NAME
$ \uparrow $	ISSUED FOR CONSTRUCTION	7/15	JAC

TOOLE DESIGN


8484 Georgia Avenue, Suite 800, Silver Spring, MD 20910 TEL (301) 927-1900 TBPE Registration No. 14667





HARRIS COUNTY

ENGINEERING DEPARTMENT


PROJECT TITL			Duz	_ \
	CLEBURNE STREETS ON-STR	<u> </u>	RIKI	<u>L WA Y</u>
	SHEET DESCRIPTION:			
CB/FL	INDEX OF SHEET	<u>`S</u>		
CK'D BY:				
JC				
SCALE:	CUEET 1 OF 1			
	SHEET 1 OF 1			
DATE:	APPROVED BY:			
04/12/19				
		SH	EET	NO:

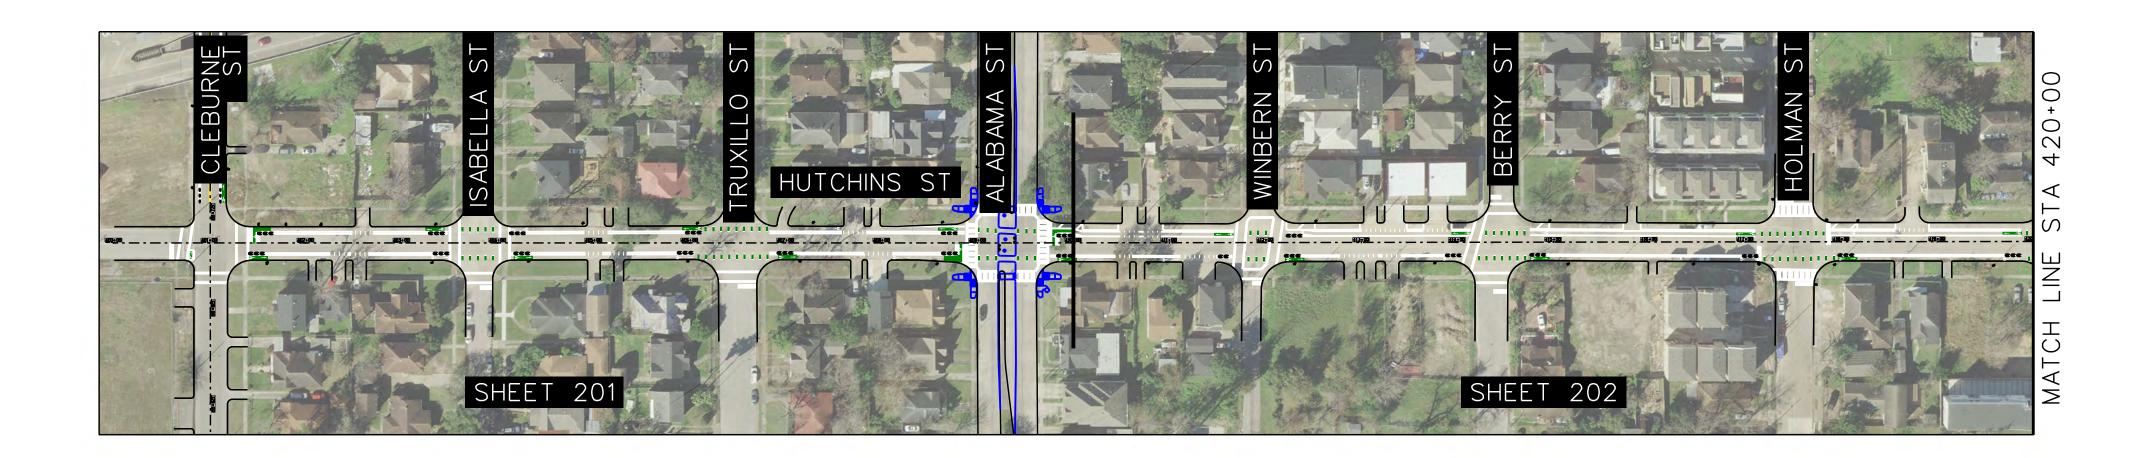

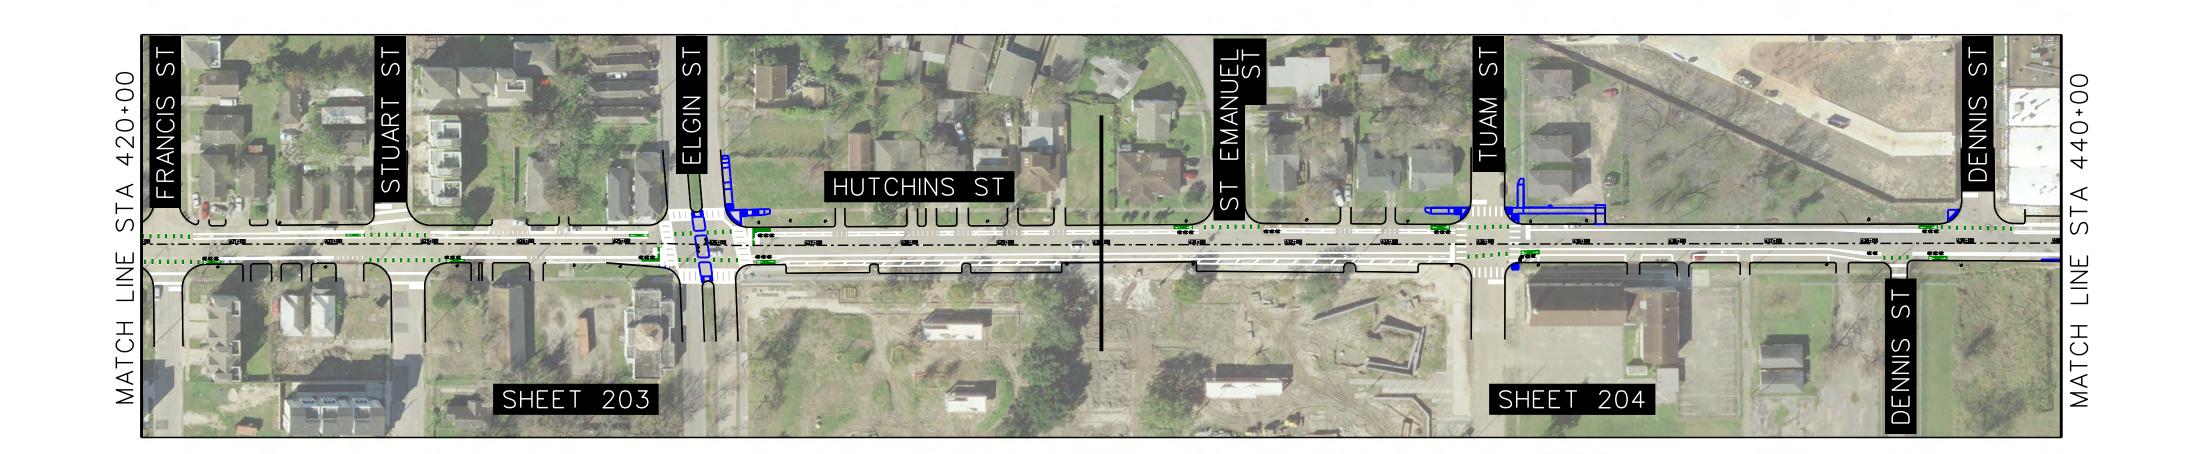

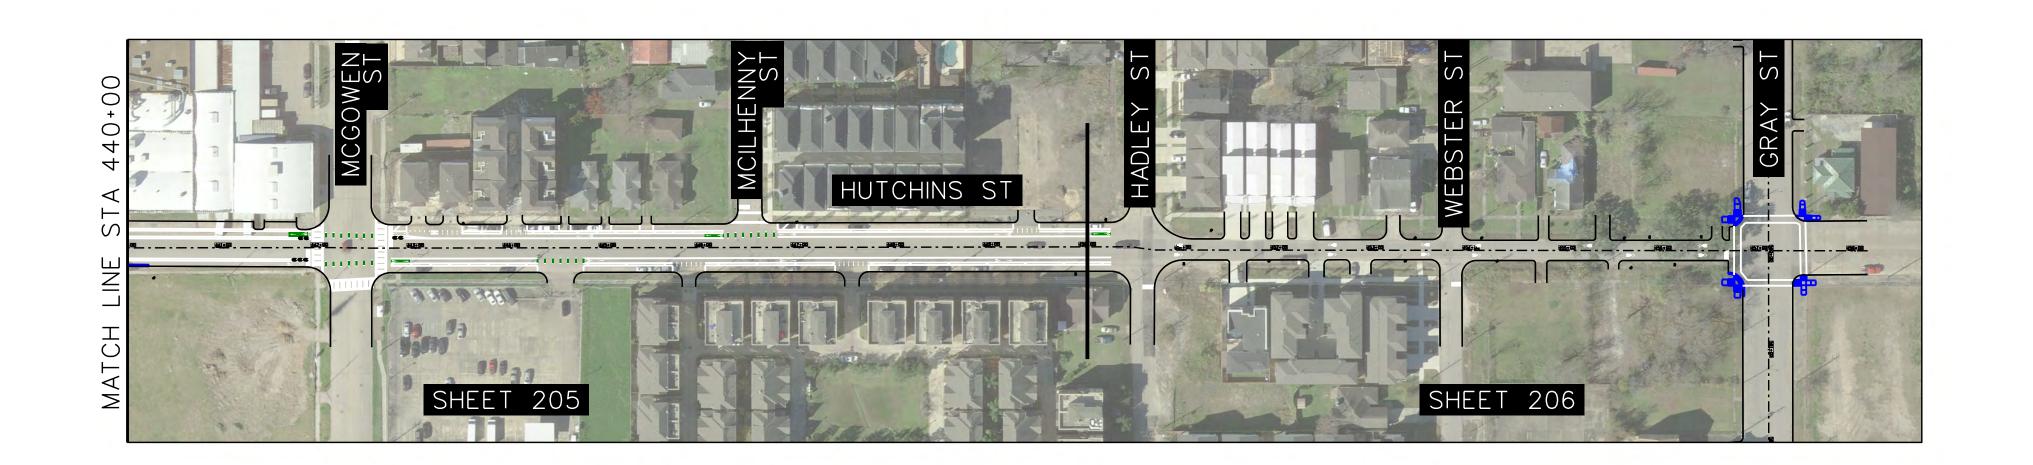



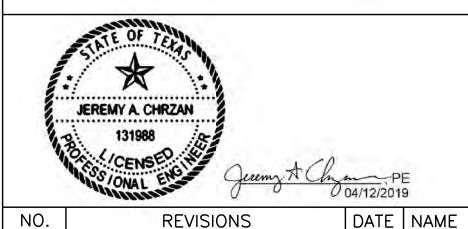

7	INEVISIONS	טאוב	IAVIAIC


700LE DESIGN


8484 Georgia Avenue, Suite 800, Silver Spring, MD 20910 TEL (301) 927-1900 TBPE Registration No. 14667





HARRIS COUNTY

PROJECT TITLE: HUTCHINS/CLEBURNE STREETS ON-STREET BIKEWAY				
DRAWN BY: SHEET DESCRIPTION: CB/FL PROJECT LAYOUT HUTCHINS STREET				
CK'D BY: JC				
SCALE: 1"=100'	SHEET 1 OF 2 APPROVED BY:			
DATE: 04/12/19				
		SHEET NO:		
		102		

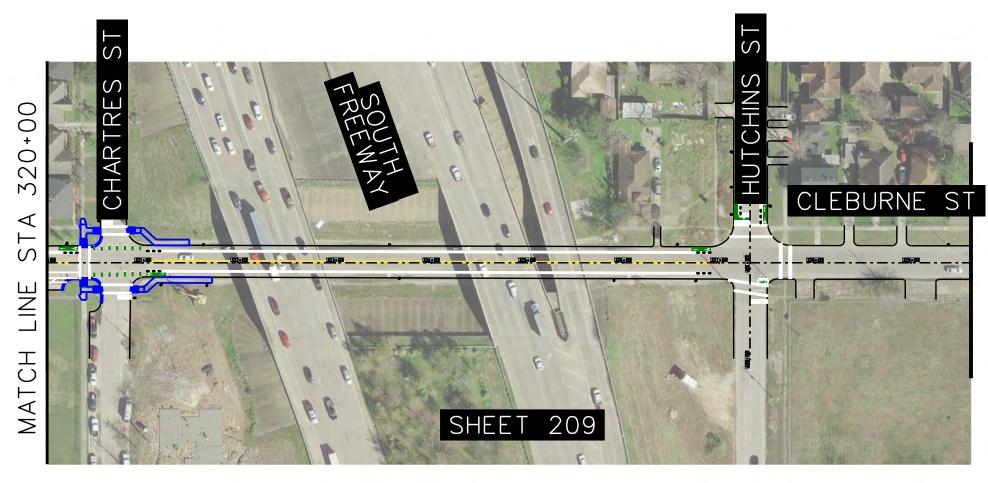

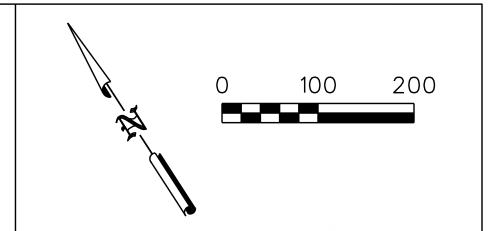

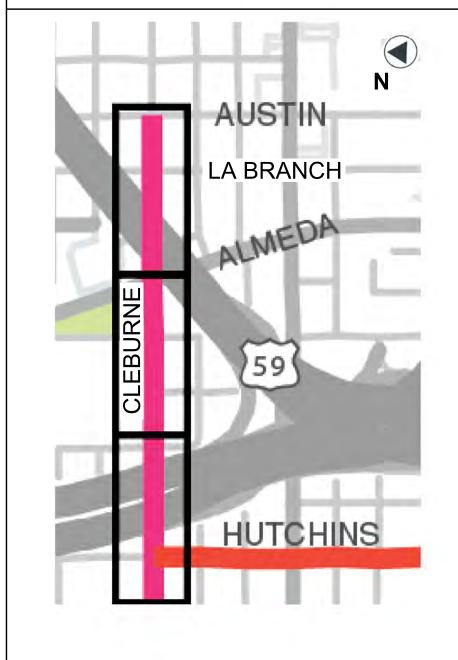


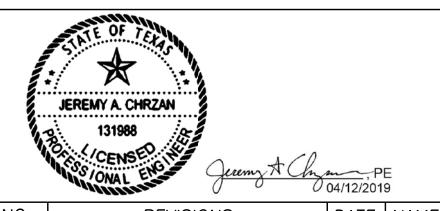

NO.	REVISIONS	DATE	NAME	

1'OOLE DESIGN

8484 Georgia Avenue, Suite 800, Silver Spring, MD 20910
TEL (301) 927-1900
TBPE Registration No. 14667

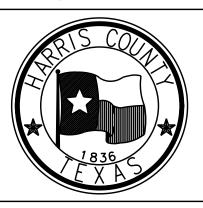

HARRIS COUNTY

ENGINEERING DEPARTMENT

PROJECT TITLE:
HUTCHINS/CLEBURNE STREETS ON-STREET BIKEWAY
DRAWN BY: SHEET DESCRIPTION:
CB/FL PROJECT LAYOUT CLEBURNE STREET
CK'D BY:
JC
SCALE:
1"=100' SHEET 2 OF 2

DATE: APPROVED BY:
04/12/19
SHEET NO:
103

19 04:33 PM: 33:08 PM USER: _USER_

GENERAL

- 1. THE CONTRACTOR SHALL FIELD VERIFY EXISTING CONDITIONS BEFORE BEGINNING CONSTRUCTION.
- 2. THE CONTRACTOR IS RESPONSIBLE FOR PROVIDING SECURITY TO PROTECT THE PROJECT SITE, CONTRACTOR PROPERTY, EQUIPMENT, AND WORK.
- 3. THE CONTRACTOR IS RESPONSIBLE FOR CLEANING STREETS OF CONSTRUCTION DIRT AND DEBRIS AT CLOSE OF EACH WORK DAY.
- 4. THE CONDITION OF THE ROAD AND/OR RIGHT-OF-WAY, UPON COMPLETION OF THE JOB SHALL BE AS GOOD AS OR BETTER THAN PRIOR TO STARTING WORK.
- 5. PRIOR TO CONSTRUCTION, THE CONTRACTOR, ALONG WITH CONCURRENCE FROM THE FIELD ENGINEER, SHALL DETERMINE HIS/HER LAY-DOWN AND/OR STAGING AREA LOCATIONS.
- 6. THE CONTRACTOR SHALL NOTIFY ALL PROPERTY OWNERS A MINIMUM OF 24 HOURS PRIOR TO BLOCKING DRIVEWAYS OR ENTERING UTILITY EASEMENTS.
- 7. TRAFFIC INGRESS AND EGRESS FOR DRIVEWAYS AND PEDESTRIAN ACCESS FACILITIES SHALL BE MAINTAINED THROUGHOUT CONSTRUCTION.
- 8. THE CONTRACTOR SHALL REMOVE ANY FENCES, POSTS, MAILBOXES, PLANTERS, PERMANENT TRASH CONTAINERS, CULVERTS, ETC. OR SECTIONS THEREOF, THAT ENCROACH WITHIN THE COUNTY'S RIGHT-OF-WAY. NOTE: PRIOR TO CONSTRUCTION, THE PROPERTY OWNER WAS PAID TO RELOCATE OR REPLACE THESE ITEMS OUTSIDE OF THE COUNTY'S RIGHT-OF-WAY.

IF THE OWNER HAS FAILED TO DO SO, THE CONTRACTOR WILL REPLACE THEM WITH THE MINIMUM LEVEL OF QUALITY NEEDED TO SECURE THE PROPERTY AND/OR MAINTAIN MAIL DELIVERY. IN THAT CASE, PAYMENT FOR THESE INSTALLATIONS WILL BE INCLUDED AS EXTRA WORK ITEMS OR AS OVERRUNS TO EXISTING PAY ITEMS.

ANY DAMAGE CAUSED BY THE CONTRACTOR TO SUCH ITEMS LOCATED OUTSIDE OF THE COUNTY'S RIGHT-OF-WAY, SHALL BE REPLACED WITH LIKE-KIND OR BETTER AT THE CONTRACTOR'S EXPENSE.

ALSO, IF THESE ITEMS ARE LOCATED WITHIN THE PROJECT RIGHT-OF-WAY AND ARE DESIGNATED TO REMAIN, ANY DAMAGE CAUSED BY THE CONTRACTOR TO SUCH ITEMS, SHALL BE REPLACED WITH LIKE-KIND OR BETTER AT THE CONTRACTOR'S EXPENSE.

TREES, BUSHES, SHRUBBERY AND OTHER DAMAGED PLANTINGS DESIGNATED TO REMAIN SHALL BE REPLACED WITHIN 72 HOURS OF REMOVAL AND ARE TO BE THOROUGHLY WATERED-IN. NO SEPARATE PAY.

- 9. PAVED SURFACES, PAVEMENT MARKERS AND MARKINGS SHALL BE PROTECTED FROM DAMAGE BY TRACKED EQUIPMENT.
- 10. IRON RODS DISTURBED DURING CONSTRUCTION ARE TO BE REPLACED BY A REGISTERED PROFESSIONAL LAND SURVEYOR FOR THE ORIGINAL PROPERTY OWNER AT NO SEPARATE PAY.
- 11. CONSTRUCTION STAKING WILL BE PROVIDED BY THE CONTRACTOR. TWO COPIES OF STAKING NOTES TO BE PROVIDED TO THE ENGINEER PRIOR TO CONSTRUCTION.
- 12. THE COUNTY OR THE COUNTY'S SURVEYOR SHALL PROVIDE A BENCHMARK OR TEMPORARY BENCHMARK AND SURVEY CONTROLS.
- 13. THE CONTRACTOR SHALL MAINTAIN UPDATED RED-LINED RECORD DRAWINGS ON SITE FOR INSPECTION BY THE ENGINEER.
- 14. MOWING, MAINTENANCE, AND CLEAN-UP OF THE PROJECT SHALL MEET THE REQUIREMENT OF SPECIFICATION ITEM 560 (NO SEPARATE PAY). MOWING, MAINTENANCE, AND CLEAN-UP IS REQUIRED FOR THE PROJECT LIMITS AND DURATION, REGARDLESS OF THE CONTRACTOR'S SCOPE OF ACTIVITIES WITHIN THE PROJECT LIMITS.
- 15. THE REMOVAL OF ANY ABANDONED UTILITIES REQUIRED TO COMPLETE THE WORK SHALL BE INCIDENTAL AND NO SEPARATE PAYMENT SHALL BE MADE.
- 16. IT IS THE CONTRACTOR'S RESPONSIBILITY TO STOCKPILE NECESSARY MATERIAL ON-SITE OR AT A SECURED OFF-SITE LOCATION AT NO ADDITIONAL EXPENSE TO HARRIS COUNTY. ANY SUITABLE EXCAVATED MATERIAL ON THE PROJECT WHICH IS AVAILABLE AT THE TIME OF NEED; WHETHER FROM STORM SEWER, ROADWAY, AND/OR CHANNEL EXCAVATION, SHALL BE USED BEFORE BORROW IS BROUGHT ON-SITE.
- 17. MANHOLES, JUNCTION BOXES, INLETS, AND RISERS ARE TO BE PRE-CAST OR CAST IN PLACE.


TRAFFIC CONTROL

- 1. THE CONTRACTOR SHALL PROVIDE AND INSTALL TRAFFIC CONTROL DEVICES IN CONFORMANCE WITH PART VIOF THE MOST RECENT EDITION OF THE MANUAL ON UNIFORM TRAFFIC CONTROL DEVICES AND THE APPROVED TRAFFIC CONTROL PLAN.
- 2. THE CONTRACTOR SHALL MAINTAIN AT LEAST ONE LANE OF TRAFFIC IN EACH DIRECTION DURING WORKING HOURS EXCEPT DURING FLAGGING OPERATION OR PROVIDE DETOURS AROUND THE CONSTRUCTION SITE AND PROVIDE PUBLIC NOTIFICATION.
- 3. LANE CLOSURES SHALL BE DURING OFF-PEAK HOURS ONLY (MONDAY THROUGH FRIDAY 9 A.M. TO 4 P.M.) UNIFORMED PEACE OFFICERS OR FLAGGERS IN RADIO CONTACT ARE REQUIRED TO DIRECT TRAFFIC DURING LANE CLOSURES.
- 4. DETOURS REQUIRE PRIOR APPROVAL OF THE FIELD ENGINEER AND PRECINCT. DETOUR PLANS, IF ALLOWED, MUST INCLUDE APPROPRIATE DETOUR SIGNAGE, PUBLIC NOTICE VIA SIGNAGE TWO WEEKS IN ADVANCE STATING THE DATES OF THE AGREED UPON DATE OF CLOSURE AND DATE THE ROAD WILL RE-OPEN TO TRAFFIC. CONTRACTOR TO USE (WITH PRIOR APPROVAL OF THE FIELD ENGINEER) HIGH EARLY STRENGTH CONCRETE AND OTHER RELATED CONSTRUCTION METHODS TO MINIMIZE THE DURATION OF THE DETOUR AND TO ENSURE THAT THE ROADWAY IS OPEN ON, OR PRIOR TO, THE AGREED UPON DATE.
- 5. ONE DAY PRIOR TO THE IMPLEMENTATION OF A TRAFFIC CONTROL PLAN PHASE OR STEP, OR THE IMPLEMENTATION OF AN ADDITIONAL, REVISED, OR NEW TRAFFIC CONTROL ELEMENT, THE CONTRACTOR SHALL MEET WITH THE ENGINEER TO GIVE A DETAILED DESCRIPTION OF THE CONTRACTOR'S PLAN AND PREPARATIONS. THE CONTRACTOR SHALL OBTAIN WRITTEN CONCURRENCE FROM THE ENGINEER THAT ADEQUATE PROJECT PROGRESS HAS BEEN ACHIEVED AND THAT ADEQUATE PREPARATIONS ARE IN PLACE PRIOR TO SWITCHING TRAFFIC. IF, IN THE OPINION OF THE ENGINEER, REQUIRED PROGRESS AND ADEQUATE PREPARATIONS ARE NOT COMPLETE, THE CONTRACTOR SHALL NOT IMPLEMENT THE NEXT PHASE, STEP, OR ELEMENT OF TRAFFIC CONTROL UNTIL INCOMPLETE CONSTRUCTION ITEMS OR PREPARATIONS ARE COMPLETED. TIME EXTENSIONS WILL NOT BE GRANTED FOR DELAYS CAUSED BY THE INCOMPLETE CONSTRUCTION ITEMS OR INADEQUATE CONTRACTOR PREPARATIONS REQUIRED TO IMPLEMENT TRAFFIC CONTROL.
- 6. TRAFFIC CONTROL PER THE CONTRACT IS REQUIRED FOR THE ENTIRE DURATION OF THE PROJECT, INCLUDING THE PUNCHLIST PERIOD. PAYMENT FOR TRAFFIC CONTROL THAT IS PROPERLY INSTALLED FOR LESS THAN A FULL MONTH SHALL BE BASED ON A PERCENTAGE BASIS OF THE TIME INSTALLED. TRAFFIC CONTROL PAYMENTS TO THE CONTRACTOR SHALL END 10 DAYS AFTER SUBSTANTIAL COMPLETION, ALTHOUGH PROPER TRAFFIC CONTROL MUST BE MAINTAINED UNTIL PUNCHLIST COMPLETION.
- 7. THE PURPOSE OF THE CONSTRUCTION SEQUENCE AND TRAFFIC HANDLING OUTLINED HEREIN IS TO DOCUMENT A VIABLE TCP THAT CAN BE UTILIZED TO CONSTRUCT THE PROJECT. IT IS THE BASIS OF ESTIMATION FOR THE TRAFFIC CONTROL BID ITEMS, AND IS TO BE UTILIZED AND IMPLEMENTED, UNLESS OTHERWISE DIRECTED BY THE ENGINEER.

IF THE CONTRACTOR CHOOSES TO USE A DIFFERENT TCP, HE/SHE SHALL PREPARE AND SUBMIT THE ALTERNATIVE TCP TO THE COUNTY FOR APPROVAL NO LESS THAN 10 WORKING DAYS PRIOR TO THE PROPOSED IMPLEMENTATION DATE. THE TCP SHALL BE DRAWN TO SCALE AND SIGNED & SEALED BY A PROFESSIONAL ENGINEER LICENSED TO PRACTICE IN THE STATE OF TEXAS. UPON APPROVAL BY HARRIS COUNTY, THE ALTERNATIVE PLAN SHALL BECOME THE BASIS FOR A "CHANGE IN CONTRACT" TO REVISE THE TRAFFIC CONTROL BID ITEMS ACCORDINGLY AND BECOME PART OF THE CONTRACT DOCUMENTS.

PROJECT-SPECIFIC NOTES


- 1. CONTRACTOR SHALL LOCATE EXISTING EDGE OF PAVEMENT & SIDEWALK AND REMOVE ANY DIRT, DEBRIS, VEGETATION, OR OTHER IMPEDIMENTS TO PROVIDE CLEAR SURFACE AND 8' VERTICAL CLEARANCE. TO BE PAID AS CLEARING AND GRUBBING.
- 2. EXISTING SIGNAGE TO REMAIN UNLESS NOTED.
- 3. NEW CROSSWALKS AND STOP BARS TO BE CONSTRUCTED ON ALL SIDE STREETS.STOP SIGNS SHALL BE RELOCATED TO ALIGN WITH NEW STOP BARS.
- 4. SIGHT DISTANCES OF 80-FEET SHALL BE VERIFIED BETWEEN VEHICLES ON SIDE STREET AND BICYCLISTS ON THE BIKE LANE. VEGETATION OR OTHER SIGHT DISTANCE OBSTRUCTIONS SHOULD BE REMOVED UNDER CLEARING AND GRUBBING.
- 5. CONTRACTOR SHALL INSTALL/REFRESH ALL PAVEMENT MARKINGS SHOWN ON PLANS.
- 6. CONTRACTOR SHALL INSTALL GREEN PAVEMENT MARKING BEFORE WHITE PAVEMENT MARKINGS WHERE ABUTTING.

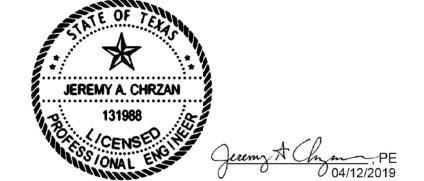

NO.	REVISIONS	DATE	NAME

100LE DESIGN


8484 Georgia Avenue, Suite 800, Silver Spring, MD 20910
TEL (301) 927-1900
TBPE Registration No. 14667

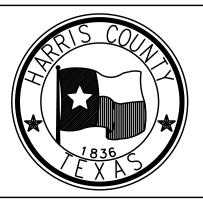

HARRIS COUNTY

ENGINEERING DEPARTMENT

PROJECT TITL	E:			
HUTCHINS/0	CLEBURNE STREETS ON-STR	EET	BIK	EWAY
	SHEET DESCRIPTION:			
CB/FL	GENERAL NOTES	5		
CK'D BY:				
JC				
SCALE:	CUEET 1 OF 1			
NONE	SHEET 1 OF 1			
DATE:	APPROVED BY:			
04/12/19				
		SH	IEET	NO:

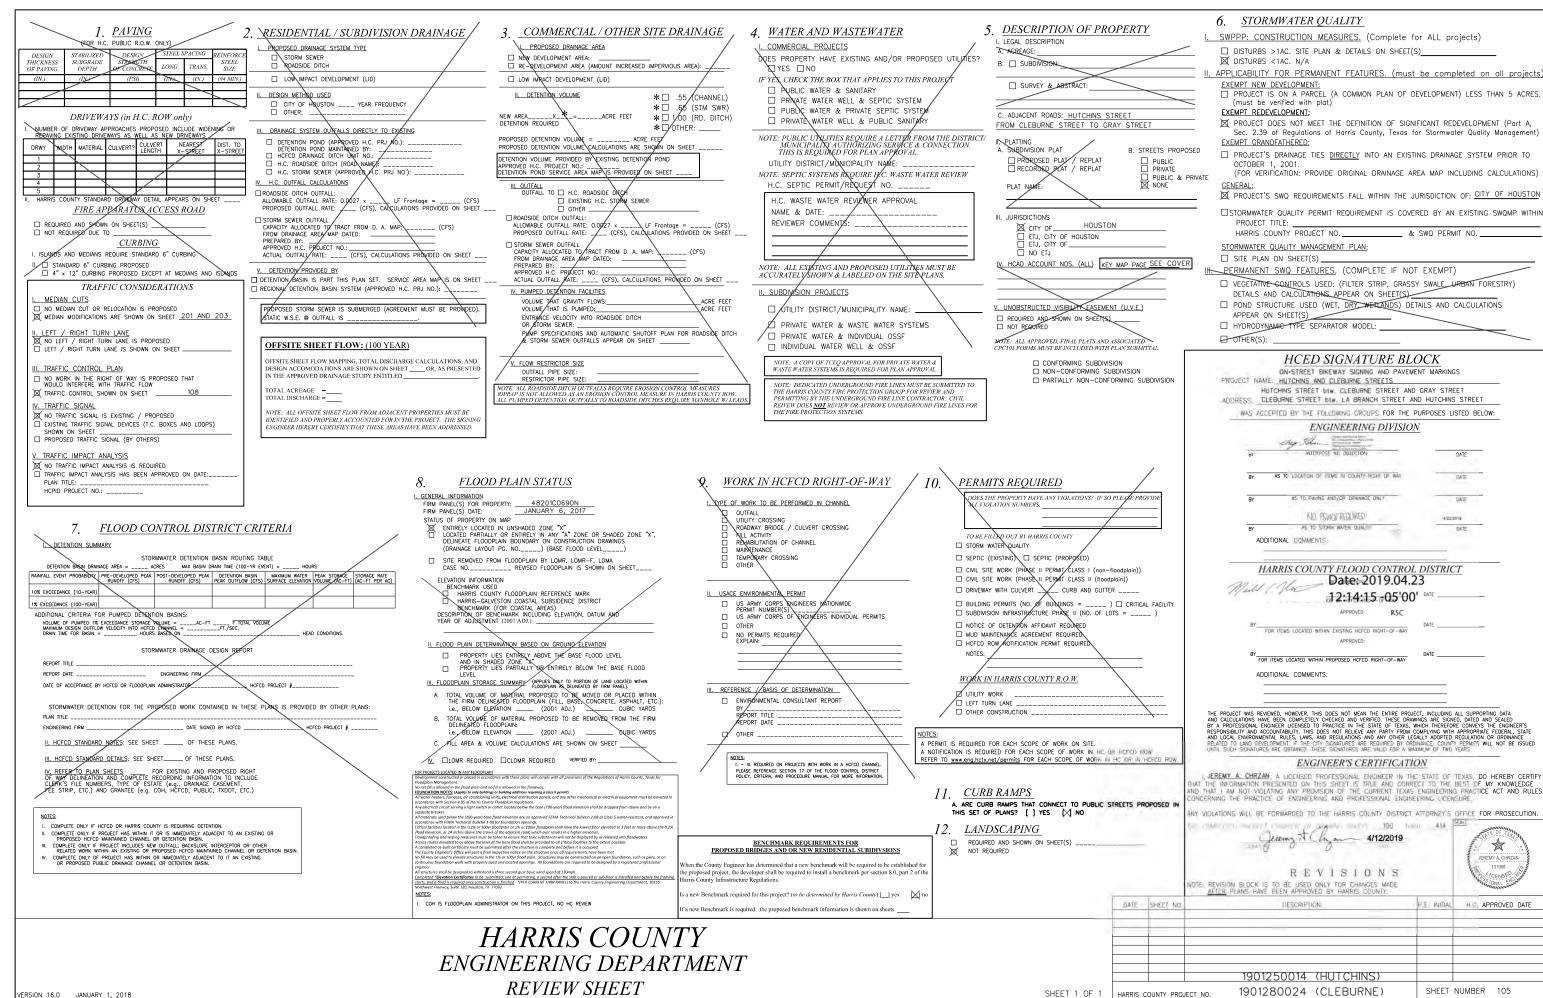


VERSION 16.0 JANUARY 1, 2018

QUANTITY SUMMARY

SIGNING AND PAVEMENT MARKING ALONG THE HUTCHINS AND CLEBURNE CORRIDORS PAVING AND CONCRETE WORK ALONG THE HUTCHINS CORRIDOR


ITEM NO	DESCRIPTION	UNIT	QUANTITY
2	Remove and Dispose of Existing Concrete (Curb, Sidewalk, Island, Median, All Depths including sawcut)	SY	441
3	Remove and Dispose of Existing Asphaltic Surface and Base (All Depths) including sawcut	SY	154
4	Remove and Dispose of Existing Concrete Pavement, All Depths including sawcut	SY	393
7	Place, Maintain and Remove Project Identification Signs	ΕA	4
10	Remove & Relocate Traffic Signs, MailBoxes and Roadway Signs	 EA	4
11	HMAC Base Course (Black Base) (Depth per Plan)	TON	34
12	Milling Existing Asphalt Pavement (1'' to 3'' Depth per Plan or Directed by Engineer)	SY	998
14	HMAC Surface Course (Depth per Plan)	TON	112
15	Tack Coat (0.1 Gal/SY)	GAL	100
18	Concrete Pavement (7" Depth) including saw cut and doweling into Existing Pavement	SY	31
23	Full Depth Repair/Replacement of Concrete Pavement (8''-10'' Depth)	SY	457
24	Concrete Esplanades, Medians and DirectionalIslands (6" Depth)	SY	173
29	Concrete ADA Ramp (up to Six (6) feet wide (inclusive), All Types, Complete in Place)	ΕA	23
31	Reinforced Concrete Sidewalks (4-1/2'' thick) (#3 Bar @ 18'' Center to Center)	SY	247
32	Six Inch Reinforced Concrete Curb and Gutter (Monolithic)	LF	86
33	Six Inch Reinforced Concrete Curb (Doweled)	LF	698
47	Adjust Manhole Frame and Cover to New Grade	ΕA	3
52	Type B-B Inlet (Stage II)	EΑ	1
73	Traffic Control - Barricades, Barriers, Barrels, Cones, and Signing	EΑ	1
75	Aluminum Signs - Furnish & Install	EΑ	97
77	Remove Existing Ground Mounted Sign and Post Assembly	ΕA	3
79	Reflectorized Pavement Markings Type I- 4" Broken White	LF	-
81	Reflectorized Pavement Markings Type I- 4" Broken Yellow	LF	-
82	Reflectorized Pavement Markings Type I- 4'' Solid Yellow	LF	3,211
83	Reflectorized Pavement Markings Type I- 6" Solid White	LF	25,609
84	Reflectorized Pavement Markings Type I- 6" Guide White	LF	1,600
86	Reflectorized Pavement Markings Type I - 12'' Solid White	LF	4,998
89	Reflectorized Pavement Markings Type I - 24'' Solid White	LF	2,213
92	Reflectorized Pavement Markings Type I- Solid Green	SF	3,076
94	Reflectorized Pavement Markings - Type I(W) (WORD, SYMBOL, ARROW, RR Crossing ''X'', Sharrow, Etc.)	EA	89
95	Methyl Methacrylate Pavement Markings (All Widths, All Colors)	SF	1,384
164	Sodding	SY	569
167	Inlet Protection Barrier (Stage II Inlets, Gravel Bags; 60% of unit cost for furnish & installation, and 40% of unit cost for removal)	EA	6
178	Cycle Lane Separator - Zicla Zebra13 Black/White "Armadillo"	EA	160
195	Bus Shelter Foundations (METRO Type 4 Shelter)	EA	1
200	Sweeping	MI	1.6
TBD	Reflective PM TY C Preform (BIKE DETECTION) (GREEN/WHITE)	EA	4
209	Reflective PM TY C Preform (STRAIGHT ARROW) (GREEN/WHITE)	EA	39
210	Reflective PM TY C Preform (TURN BOX)(GREEN/WHITE)	EA	2
213	Reflective PM TY C Preform (BIKE MAN) (GREEN/WHITE)	EA	46
216	Surface-Applied Detectable Warning Material	SF	80
225	Precast Curb (12'') (Ty A, B, C)	LF	166

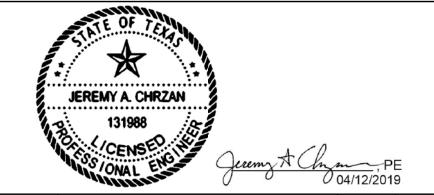

NO.	REVISIONS	DATE	NAME

100LE DESIGN

8484 Georgia Avenue, Suite 800, Silver Spring, MD 20910 TEL (301) 927-1900 TBPE Registration No. 14667

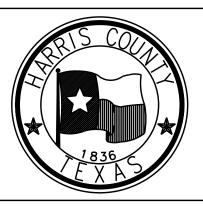


HARRIS COUNTY ENGINEERING DEPARTMENT

PROJECT TITL	E:	
	CLEBURNE STREETS ON-STR	EET BIKEWAY
DRAWN BY:	SHEET DESCRIPTION:	
CB/FL	BASIS OF ESTIMA	TE
CK'D BY: JC	HUTCHINS/CLEBU	RE
SCALE:	SHEET 1 OF 2	
DATE:	APPROVED BY:	
04/12/19		
		SHEET NO:
		106
I		

QUANTITY SUMMARY

PAVING AND CONCRETE WORK ALONG THE CLEBURNE CORRIDOR


ITEM NO	DESCRIPTION	UNIT	QUANTITY
3	Removing Old Concrete (All Type Curb)	LF	189
4	Removing Old Concrete (Pavement W/Curb and Driveway, All Depths including sawcut)	SY	516
5	Roadway Excavation Including 3'' Topsoil	CY	3
9	HMAC Base Course (Black Base) (Depth per Plan)	TON	10
10	Milling Existing Asphalt Pavement (1" to 3" Depth per Plan or Directed by Engineer)	SY	8190
12	HMAC Surface Course (Depth per Plan)	TON	906
13	Tack Coat (0.1 Gal/SY)	GAL	819
14	Concrete Pavement (7" to 10") including saw cut and doweling into Existing Pavement	SY	26
20	Concrete ADA Ramp (up to Six (6) feet wide (inclusive), All Types, Complete in Place)	EA	11
21	Reinforced Concrete Sidewalks (4-1/2" thick) (#3 Bar @ 18" Center to Center)	SY	200
22	Six Inch Reinforced Concrete Curb and Gutter (Monolithic)	LF	321
23	Six Inch Reinforced Concrete Curb (Doweled)	LF	25
27	Type A Inlet	EA	1
51	Saw Cut and Install Loop Detectors including Loop Wire In Asphalt Pavement	LF	72
52	Saw Cut and Install Loop Detectors including Loop Wire In Concrete	LF	216

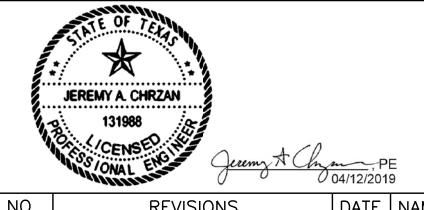

NO.	REVISIONS	DATE	NAME

100LE DESIGN


8484 Georgia Avenue, Suite 800, Silver Spring, MD 20910 TEL (301) 927-1900 TBPE Registration No. 14667

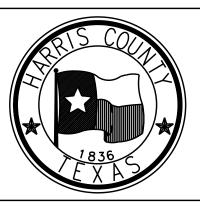

HARRIS COUNTY

ENGINEERING DEPARTMENT PROJECT TITLES

ILKOJECI IIIT					
HUTCHINS/(CLEBURNE STREETS ON-STR	EET BIKEWAY			
DRAWN BY:	SHEET DESCRIPTION:				
CB/FL BASIS OF ESTIMATE					
CK'D BY:					
JC CLEBURNE ST PAVING ONLY					
SCALE:	SHEET 2 OF 2				
SHEET Z OF Z					
DATE:	APPROVED BY:				
04/12/19					
		SHEET NO:			
		107			

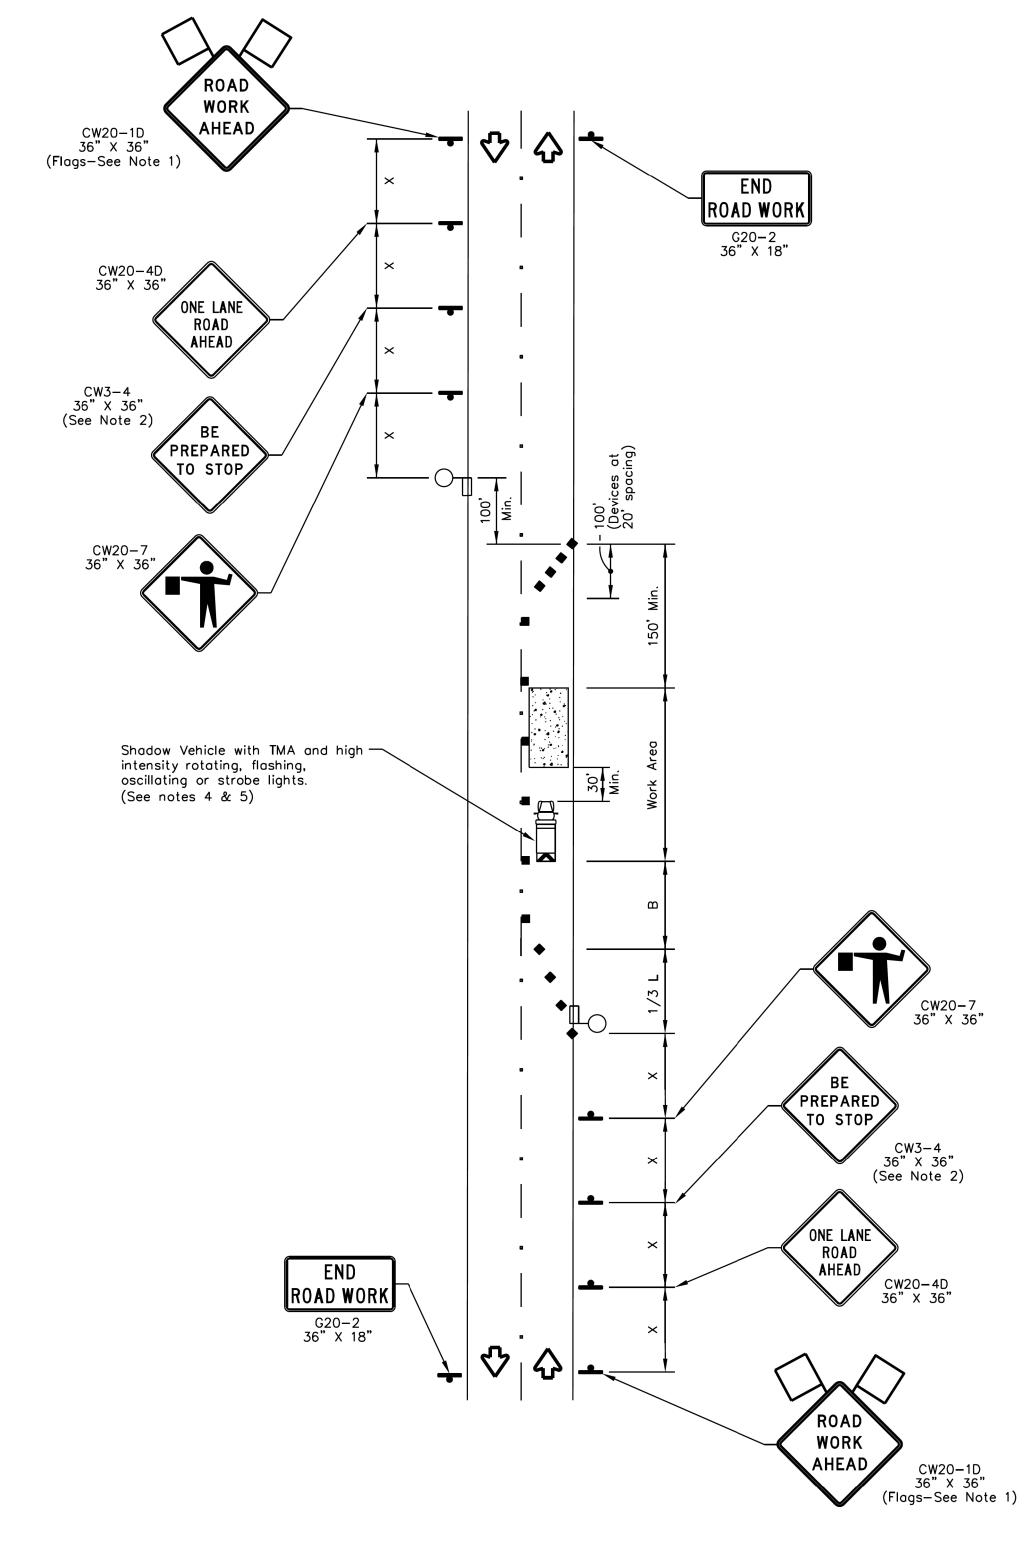

ONE-LANE TWO-WAY SINGLE LANE CLOSURE CONTROL WITH FLAGGERS (ON STRAIGHT SECTION OF ROADWAY)

TRAFFIC CONTROL PLAN SECTION SHALL BE COMPLETED BY ENGINEER

ROADWAY	POSTED SPEED	TAPER LENGTH	SPACING CHANNELIZING DEVICES TAPER TANGENT		SIGN SPACING	BUFFER SPACE
HUTCHINS ST	30 MPH	165'	30'	60'	120'	90'
CLEBURNE ST	30 MPH	165'	30'	60'	120'	90'


	LEGEND								
	Type 3 Barricade		Channelizing Devices						
	Heavy Work Vehicle		Truck Mounted Attenuator (TMA)						
	Trailer Mounted Flashing Arrow Board	\\\\\\\\\\\\\\\\\\\\\\\\\\\\\\\\\\\\\\	Portable Changeable Message Sign (PCMS)						
-	Sign	\frac{1}{2}	Traffic Flow						
	Flag	Lo	Flagger						

Posted Speed	Formula	D	Minimum esirable Length * *		Suggested Spacii Chann Devi	elizing	Minimum Sign Spacing "x"	Suggested Longitudinal Buffer Space "B"
		10' Offset	11' Offset	12' Offset	On a Taper	On a Tangent	Distance	"B"
30	2 	150'	165'	180'	30'	60'	120'	90'
35		205'	225'	245'	35'	70'	160'	120'
40	60	265'	295'	320'	40'	80'	240'	155'
45		450'	495'	540'	45'	90'	320'	195'
50		500'	550'	600'	50'	100'	400'	240'
55	L=WS	550'	605'	660'	55'	110'	500'	295'
60	1 L- W3	600'	660'	720'	60'	120'	600'	350'
65		650'	715'	780'	65'	130'	700'	410'
70		700'	770'	840'	70'	140'	800'	475'
75		750'	825'	900'	75'	150'	900'	540'

- * Conventional Roads Only
- ** Taper lengths have been rounded off. L=Length of Taper(FT) W=Width of Offset(FT) S=Posted Speed(MPH)

GENERAL NOTES


- 1. Flags attached to signs where shown are OPTIONAL.
- 2. All traffic control devices illustrated are REQUIRED, except those denoted with the triangle symbol are OPTIONAL.
- 3. Inactive work vehicles or other equipment should be parked near the right-of-way line and not parked on the paved shoulder.
- 4. A Shadow Vehicle with a TMA should be used anytime it can be positioned 30 to 100 feet in advance of the area of crew exposure without adversely affecting the performance or quality of the work. If workers are no longer present but road or work conditions require the traffic control to remain in place, Type 3 Barricades or other channelizing devices may be substituted for the Shadow Vehicle and TMA.
- 5. Additional Shadow Vehicles with TMAs may be positioned off the paved surface, next to those shown in order to protect wider work spaces.
- 6. Contractor shall provide and install traffic control devices in conformance with part VI of Texas Manual on Uniform Traffic Control Devices (TMUTCD — Latest edition with revisions) during construction.
- 7. Flaggers should use two-way radios or other methods of communication to
- 8. Length of work space should be based on the ability of flaggers to communicate.
- 9. If the work space is located near horizontal or vertical curve, the buffer distances should be increased in order to maintain adequate stopping sight distances to the flogger and a queue of stopped vehicles (see table above).
- 10. Channelizing devices on the center—line may be omitted when a pilot car is leading traffic and approved by the Engineer. 11. Flaggers should use 24" STOP/SLOW paddles to control traffic. Flags should
- be limited to emergency situations. 12. No lanes shall be blocked from 7am to 9am and 4pm to 6:30pm Monday thru
- 13. Off duty police officers required to direct traffic when applicable.
- 14. If project is within 400 feet from a signalized intersection, the Contractor shall contact Harris County Engineering Department, Traffic Signal Maintenance at (713) 881-3210 five (5) days prior to the start of construction.

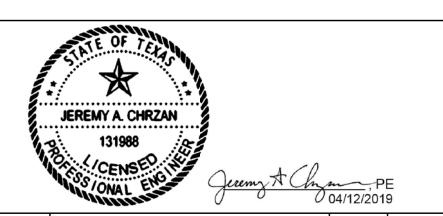

NO.	REVISIONS	DATE	NAME


TOOLE DESIGN

8484 Georgia Avenue, Suite 800, Silver Spring, MD 20910 TEL (301) 927-1900 TBPE Registration No. 14667

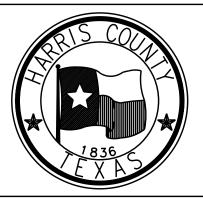


HARRIS COUNTY

PROJECT TITL HUTCHINS/(.E: CLEBURNE STREETS ON—STR	EET BIKEWAY
l .	SHEET DESCRIPTION: TRAFFIC CONTROL PLAN	
CK'D BY: JC	SINGLE LANE CLOSURE	
SCALE:	SHEET 1 OF 1	
DATE: 04/12/19	APPROVED BY:	
		SHEET NO: 108

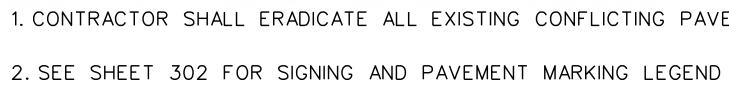


3. FOR PROPOSED WORK AT THE INTERSECTION OF HUTCHINS STREET AND CLEBURNE STREET, SEE SHEETS 207-209.


4. SEE SHEETS 401-409 FOR PAVEMENT REPAIR AND CONCRETE WORK.

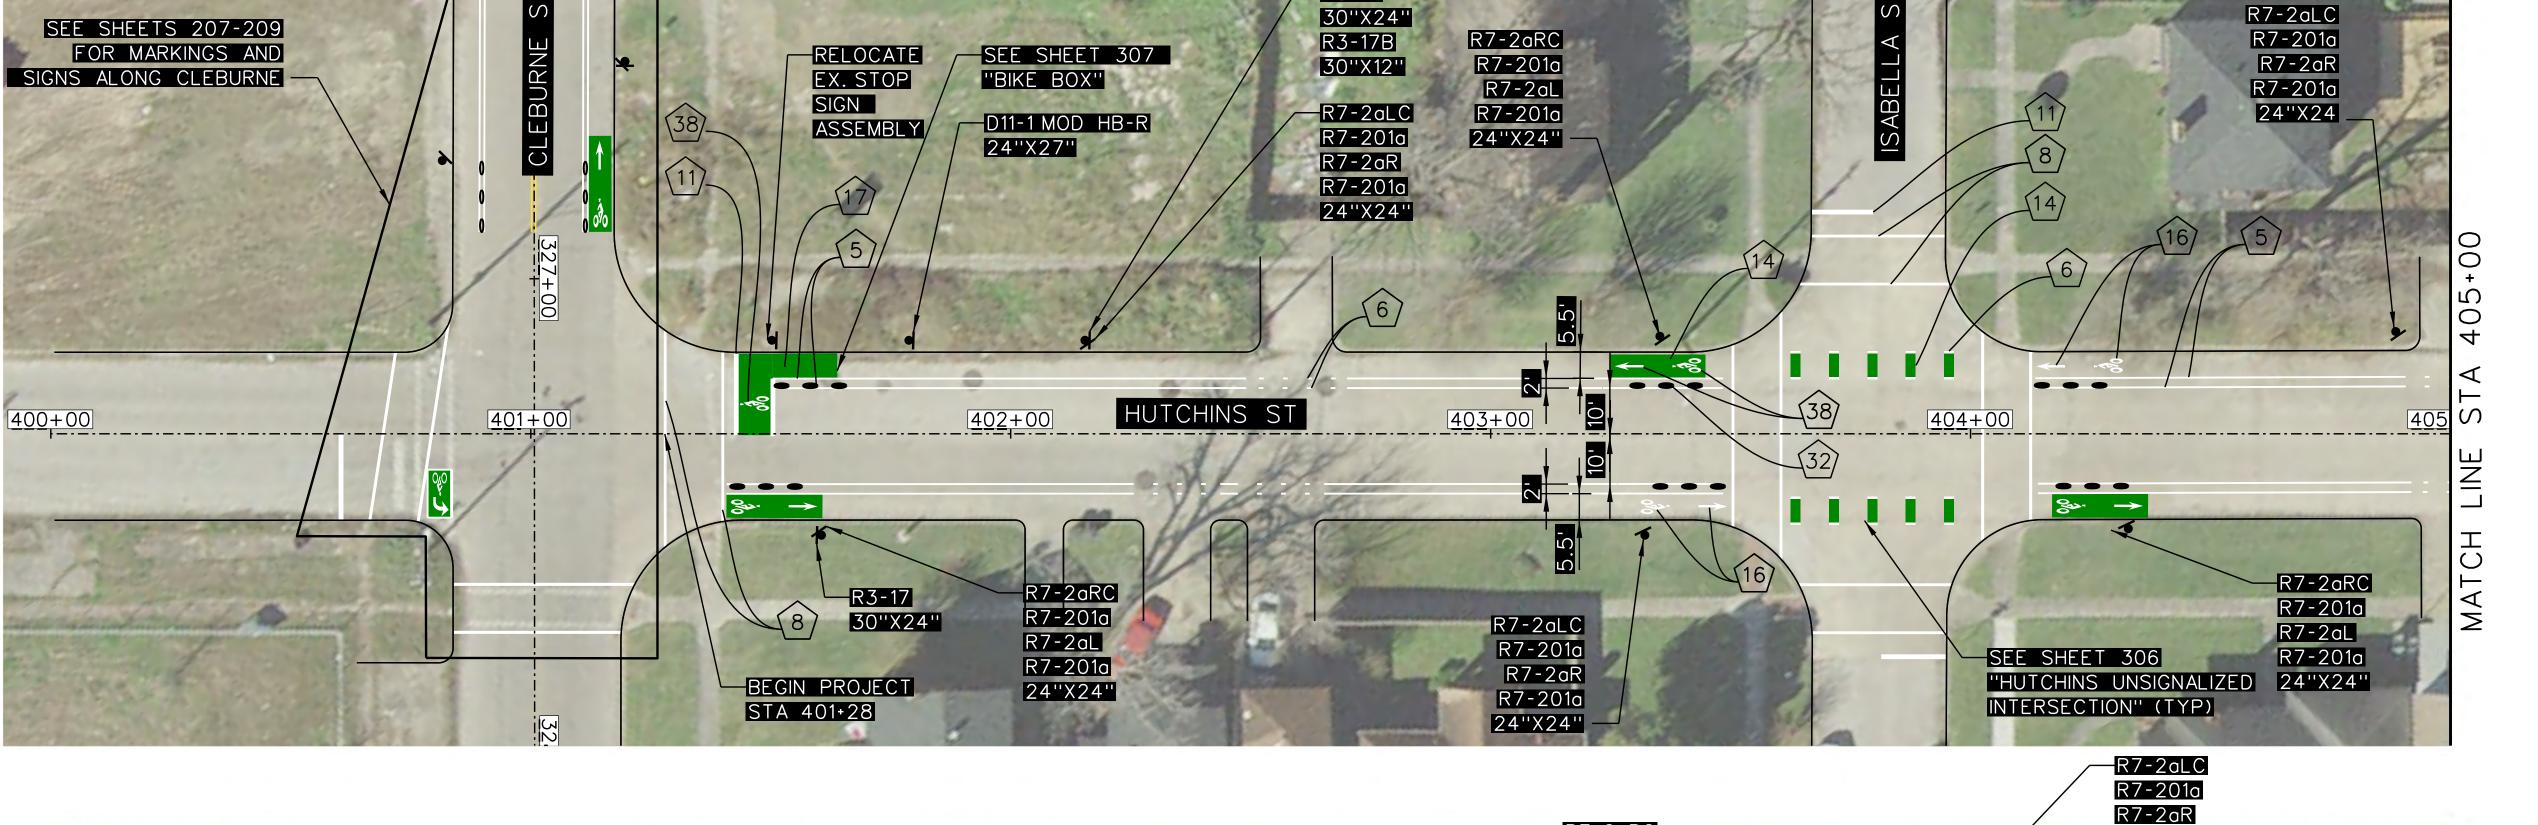

R3-17

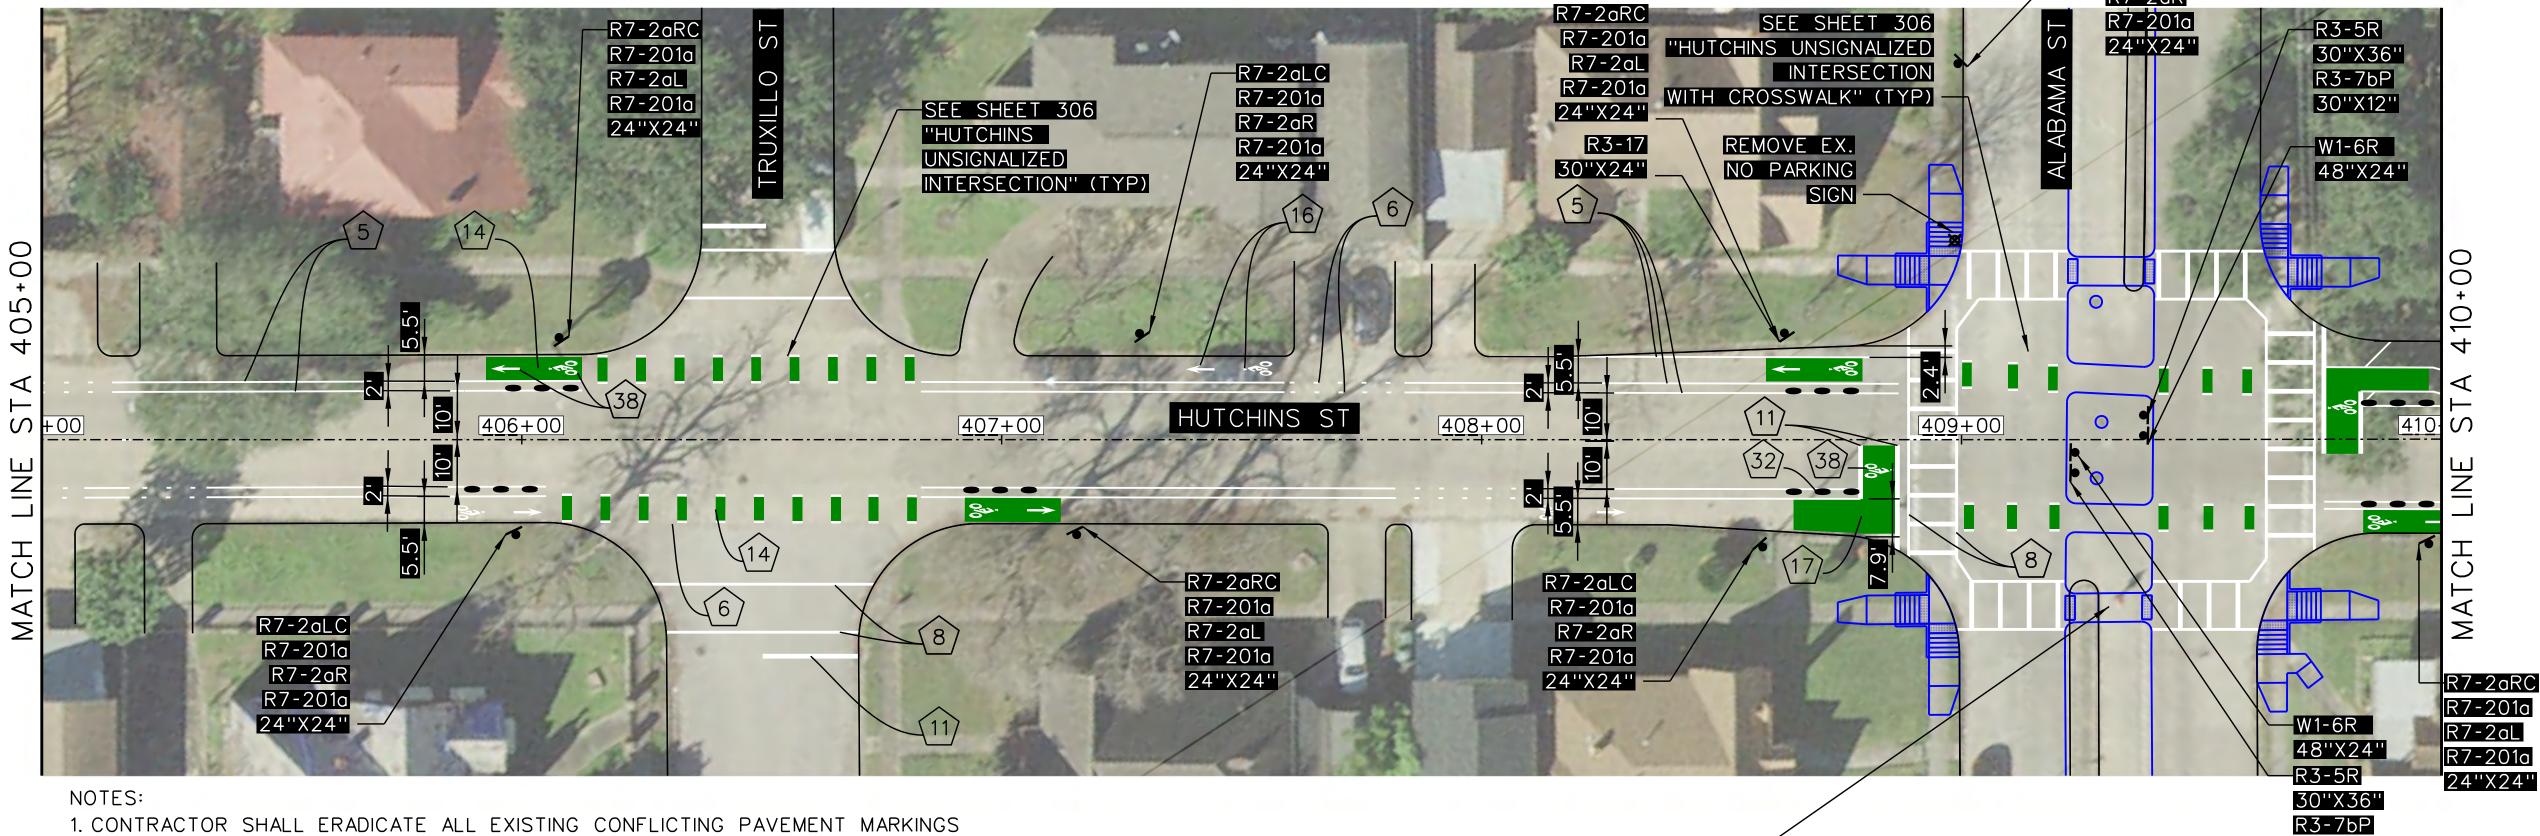

AND PEDESTRIANS.

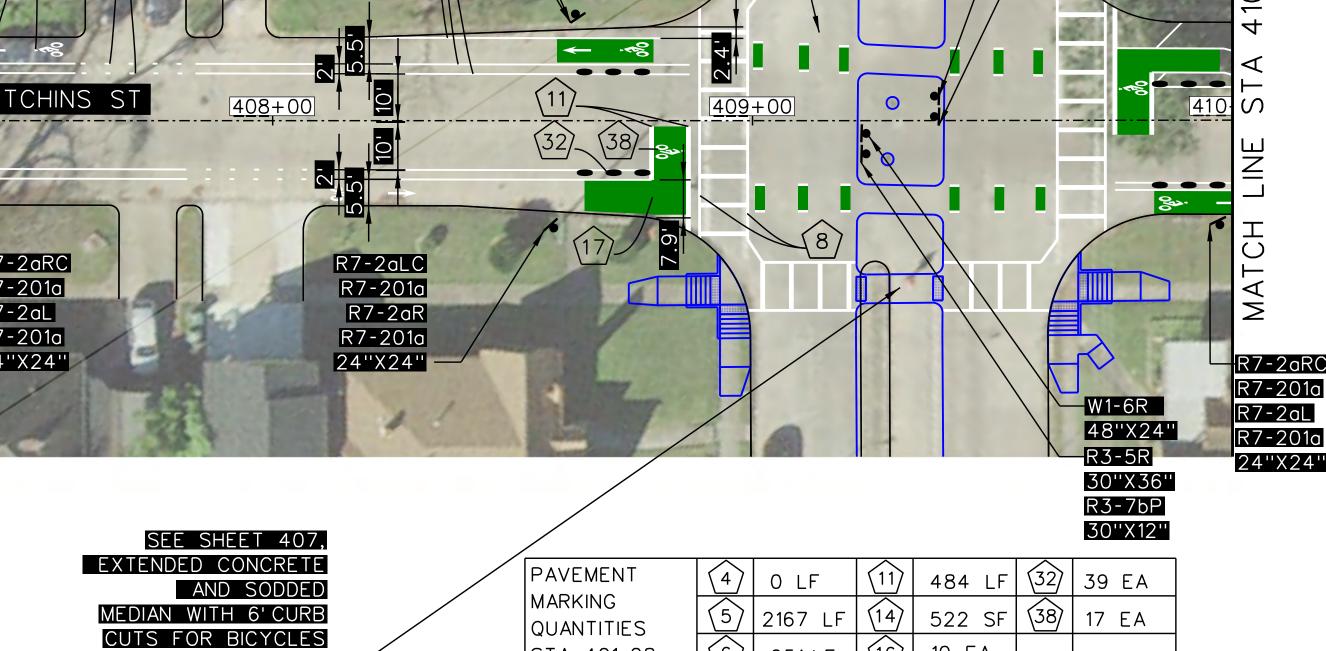

STA. 401+28


TO 410+00

(16) 10 EA

1114 LF | (17) | 532 SF

251 LF




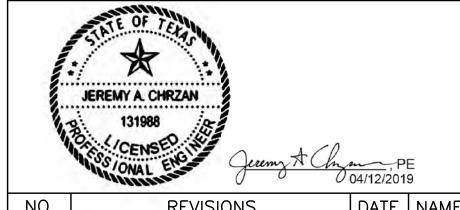

NO.	REVISIONS	DATE	NAME


TOOLE DESIGN


8484 Georgia Avenue, Suite 800, Silver Spring, MD 20910 TEL (301) 927-1900 TBPE Registration No. 14667

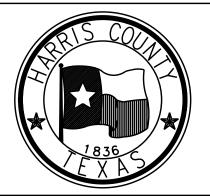

HARRIS COUNTY


PROJECT TITLE: HUTCHINS/CLEBURNE STREETS ON-STREET BIKEWAY DRAWN BY: ISHEET DESCRIPTION:							
SHEET DESCRIPTION:							
CB/FL SIGNING AND PAVEMENT MARKING LAYOUT							
SHFFT 1 OF 9							
APPROVED BY:							
	SHEET NO:						
	201						
	CLEBURNE STREETS ON-STR SHEET DESCRIPTION:						

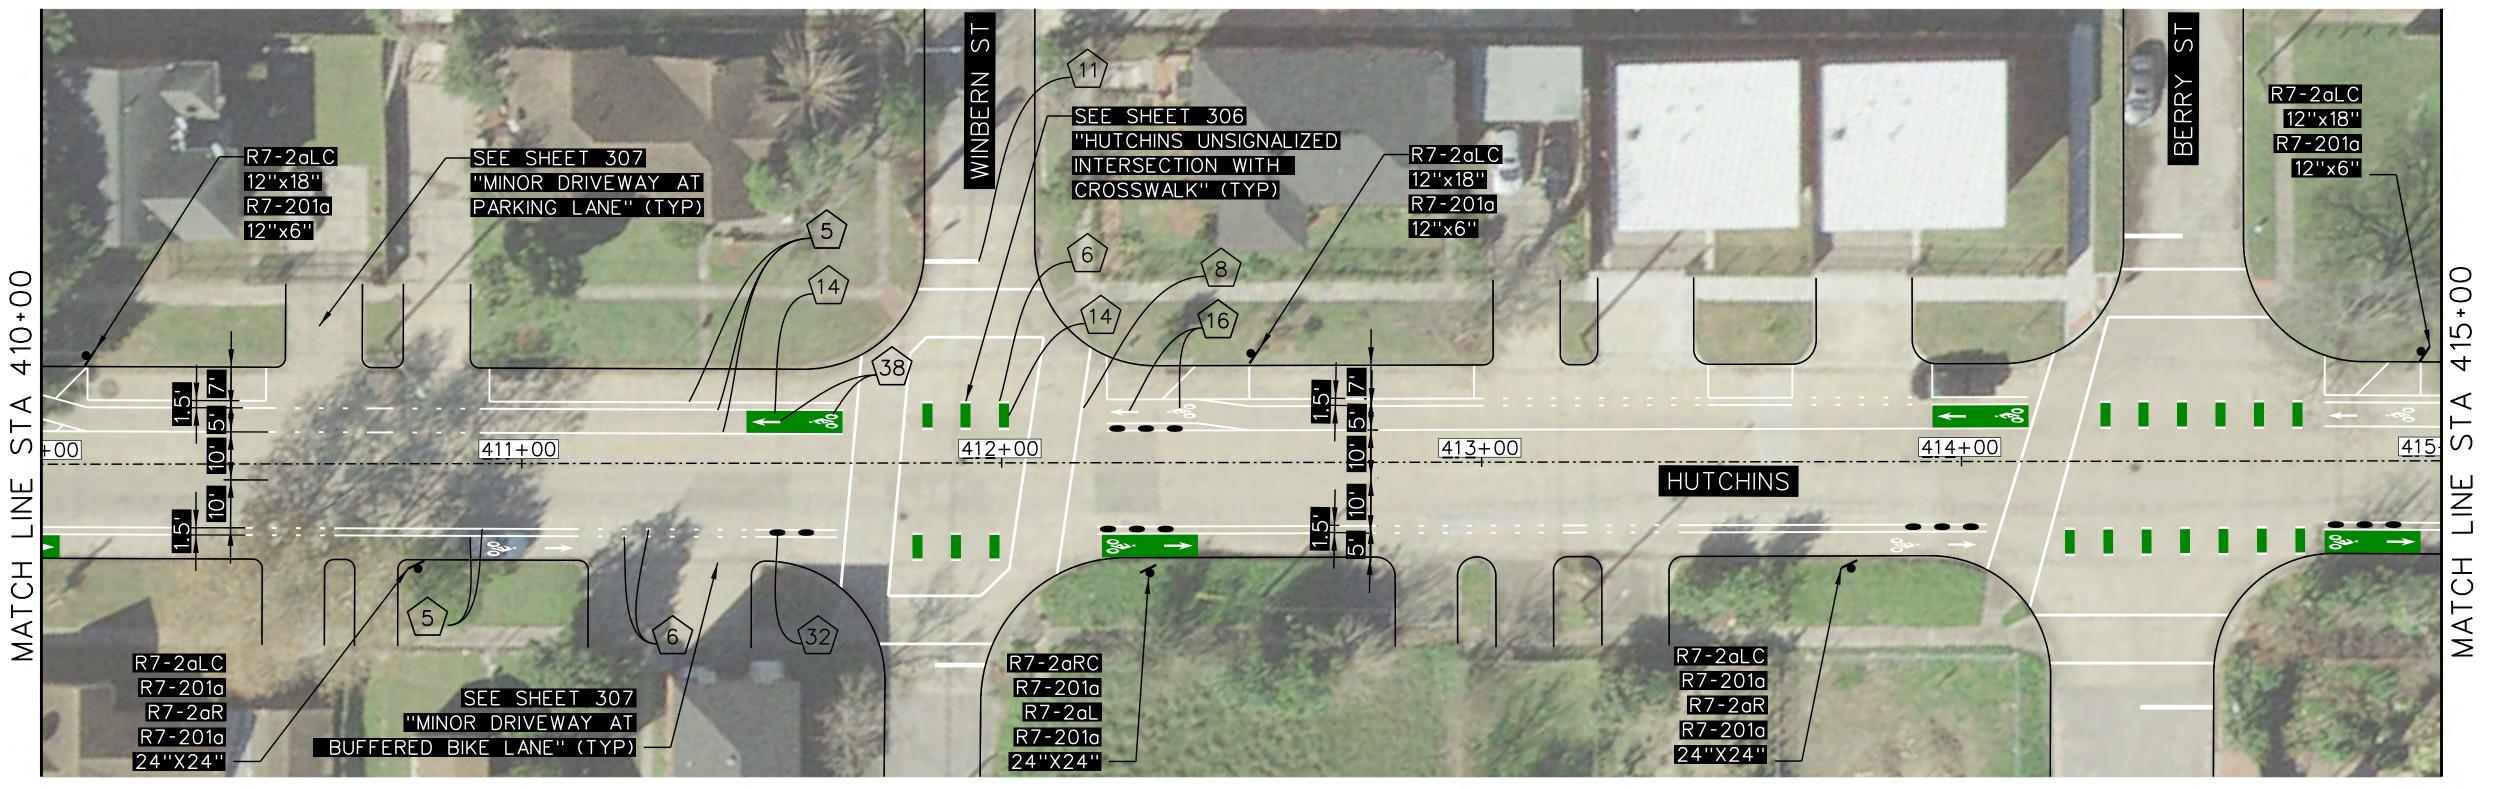

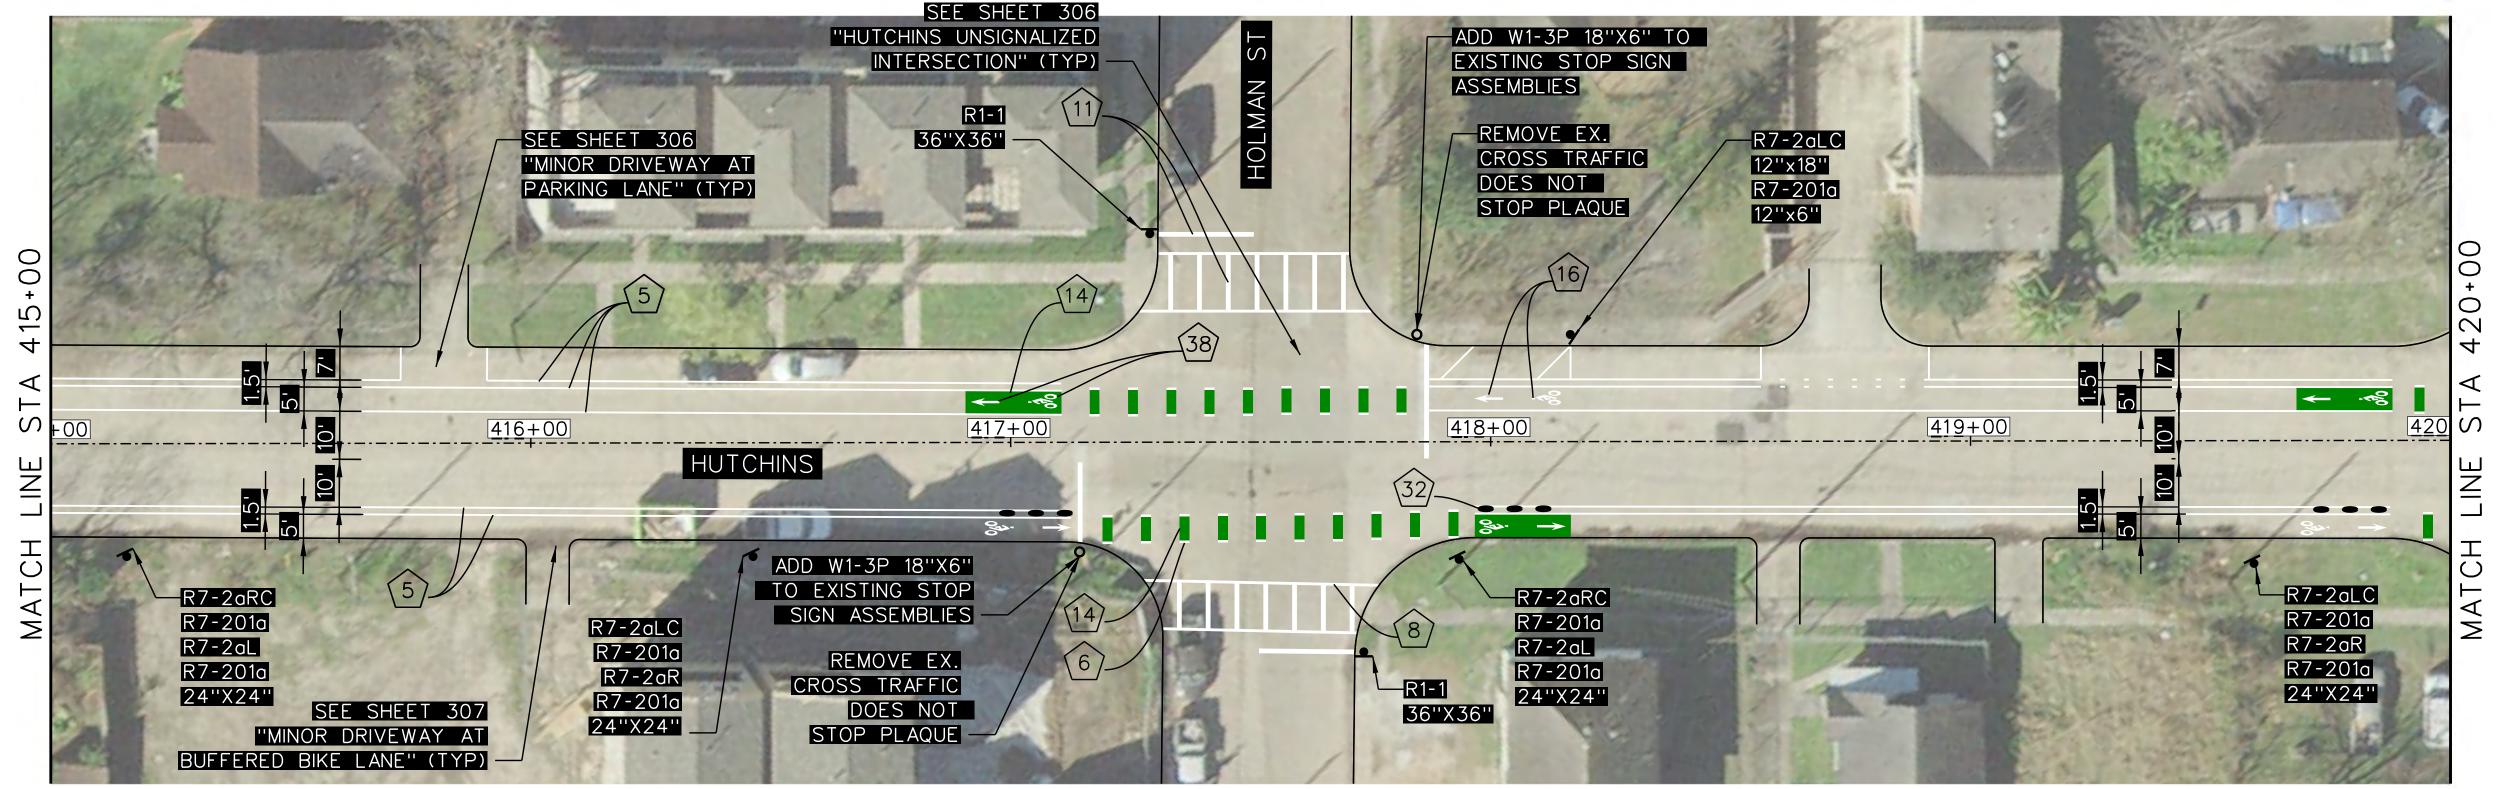

- 1. CONTRACTOR SHALL ERADICATE ALL EXISTING CONFLICTING PAVEMENT MARKINGS
- 2. SEE SHEET 302 FOR SIGNING AND PAVEMENT MARKING LEGEND
- 3. SEE SHEETS 401-409 FOR PAVEMENT REPAIR AND CONCRETE WORK.


PAVEMENT	4	O LF	(11)	275 LF	(32)	23 EA
MARKING QUANTITIES	5	3536 LF	14)	512 SF	38)	14 EA
STA. 410+00	6	291 LF	(16)	14 EA		
TO 420+00	(8)	727 LF	17)	0 SF		

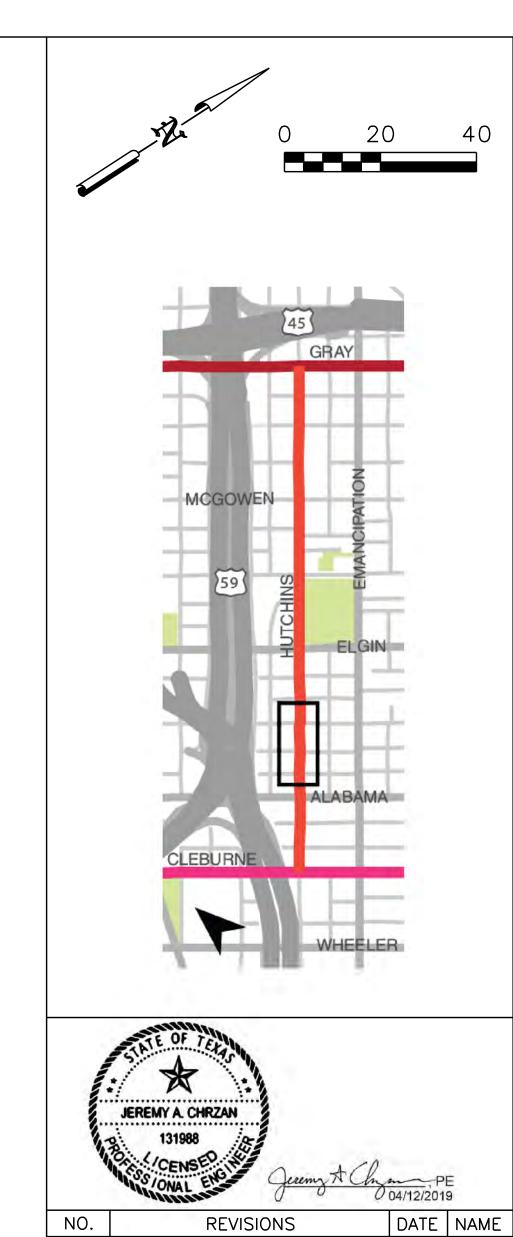

	12.55 27		-
NO.	REVISIONS	DATE	NAME

1'OOLE DESIGN


8484 Georgia Avenue, Suite 800, Silver Spring, MD 20910 TEL (301) 927-1900 TBPE Registration No. 14667

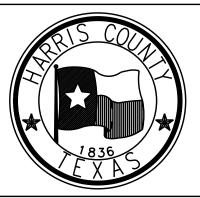


HARRIS COUNTY

	PROJECT TITLE:							
	HUTCHINS/CLEBURNE STREETS ON-STREET BIKEWAY							
DRAWN BY:	DRAWN BY: SHEET DESCRIPTION:							
CB/FL	SIGNING AND PAVEMENT MARKING LAYOUT							
CK'D BY:								
JC								
SCALE:	CUEET 2 OF 0							
1"=20'	SHEET 2 OF 9							
DATE:	APPROVED BY:							
04/12/19								
	SHEET NO:							
	202							




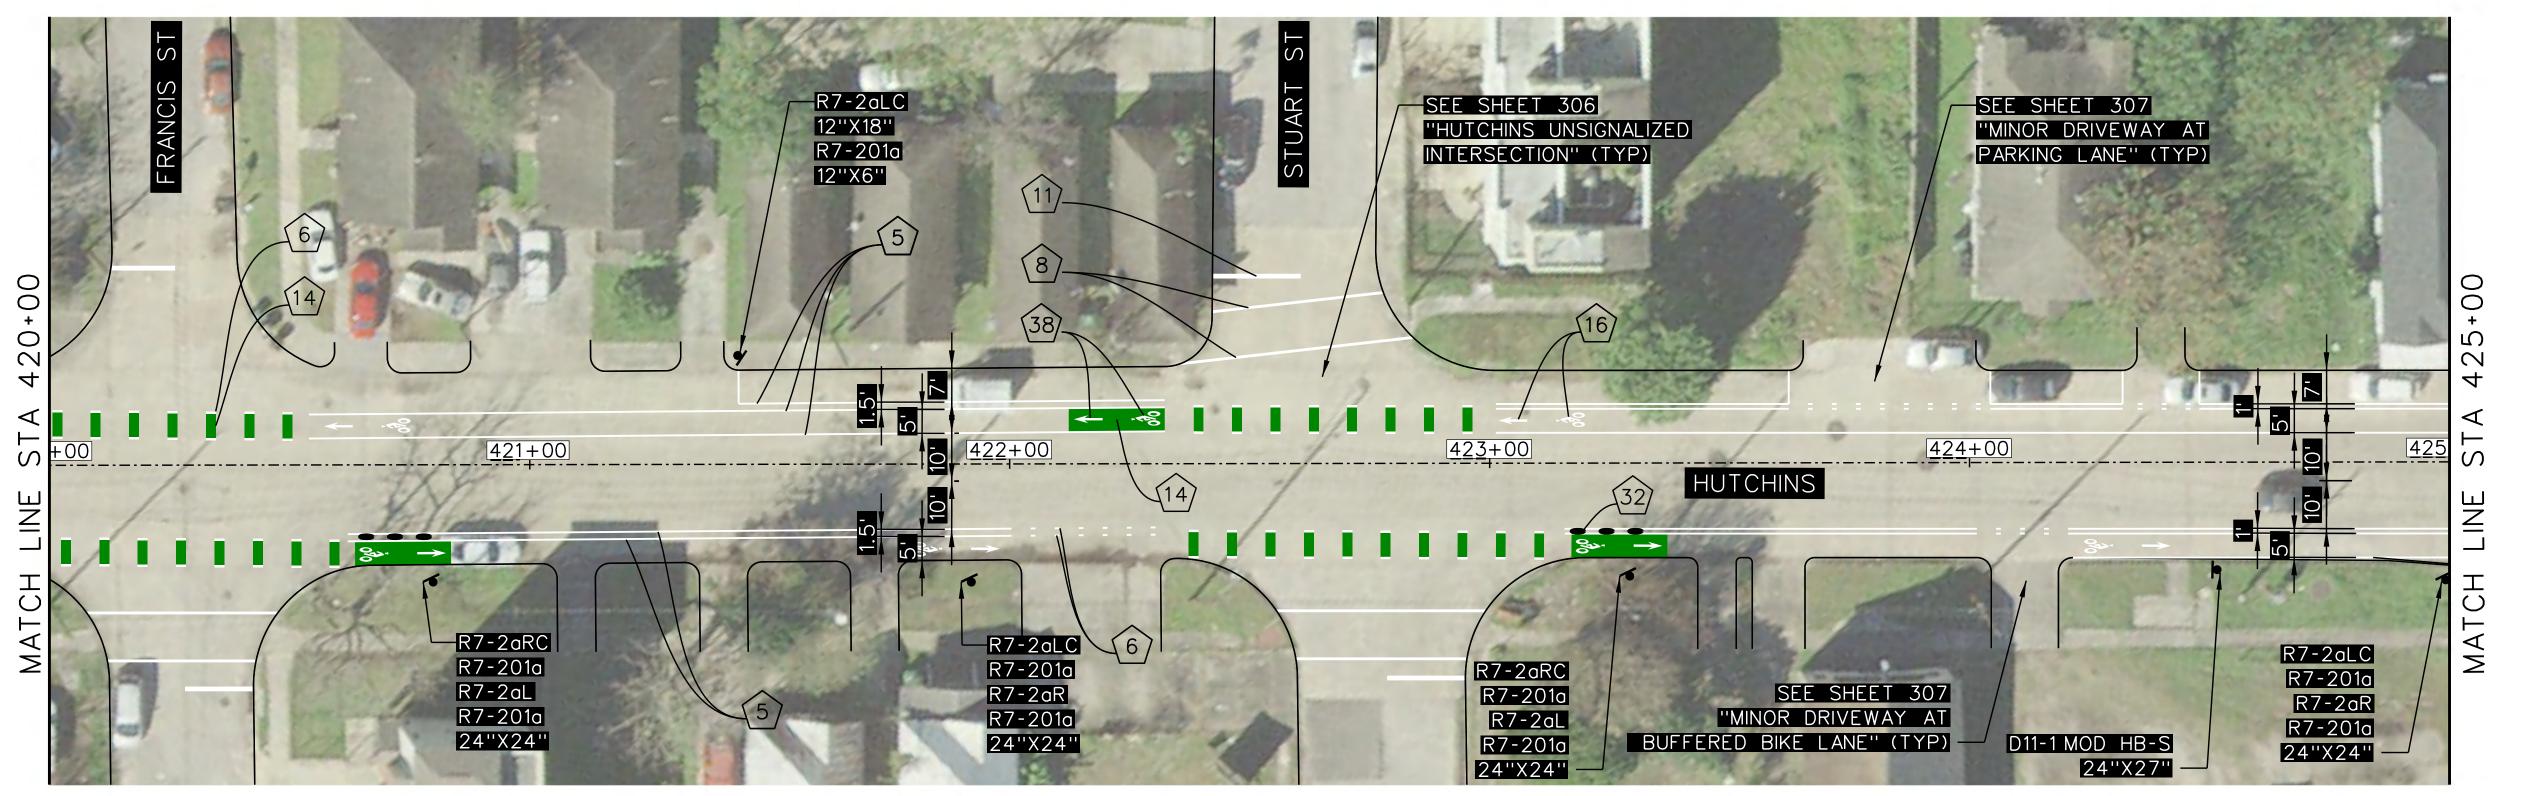


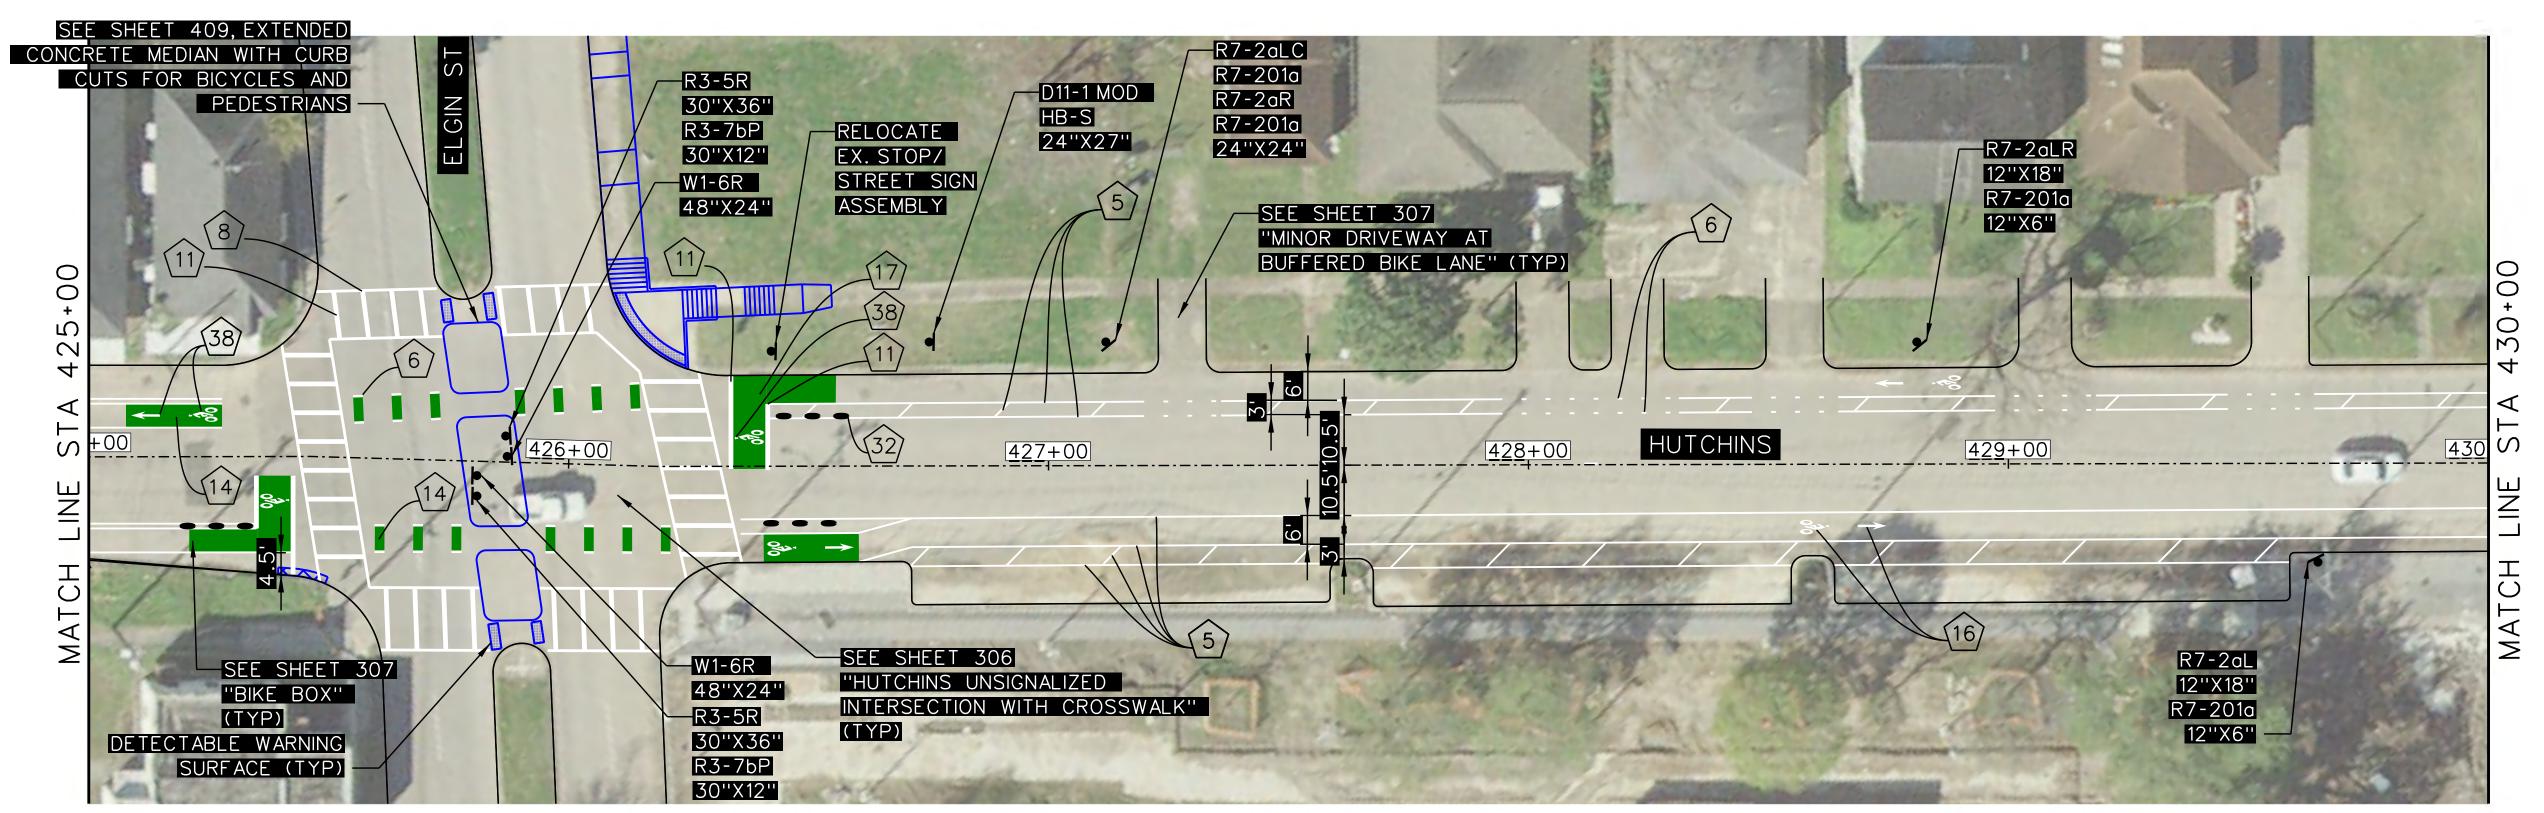

- 1. CONTRACTOR SHALL ERADICATE ALL EXISTING CONFLICTING PAVEMENT MARKINGS
- 2. SEE SHEET 302 FOR SIGNING AND PAVEMENT MARKING LEGEND
- 3. SEE SHEETS 401-409 FOR PAVEMENT REPAIR AND CONCRETE WORK.


PAVEMENT	4	O LF	11)	479 LF	(32)	15 EA
MARKING QUANTITIES	(5)	3335 LF	14)	550 SF	38	12 EA
STA. 420+00	(6)	298 LF	(16)	12 EA		
TO 430+00	8	626 LF	17)	360 SF		

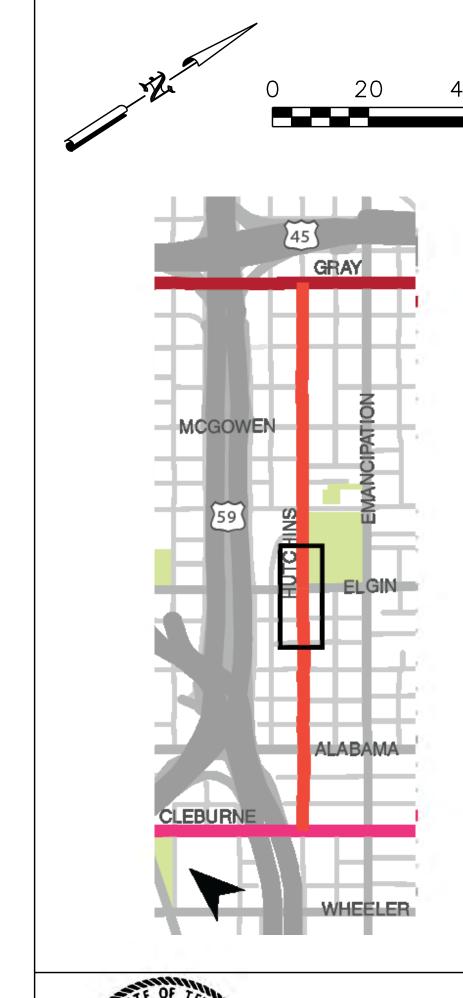

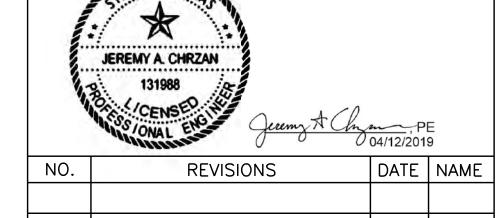


TOOLE DESIGN


8484 Georgia Avenue, Suite 800, Silver Spring, MD 20910 TEL (301) 927-1900 TBPE Registration No. 14667

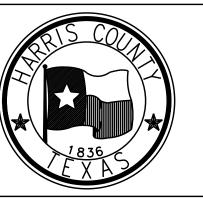

HARRIS COUNTY


PROJECT TITL							
	HUTCHINS/CLEBURNE STREETS ON-STREET BIKEWAY						
DRAWN BY: SHEET DESCRIPTION:							
/ _	SIGNING AND PAVEMENT MARKI	NG LAYOUT					
CK'D BY:							
JC							
SCALE:	CHEET 7 OF O						
1"=20'	SHEET 3 OF 9						
DATE:	APPROVED BY:						
04/12/19							
		SHEET NO:					
		203					

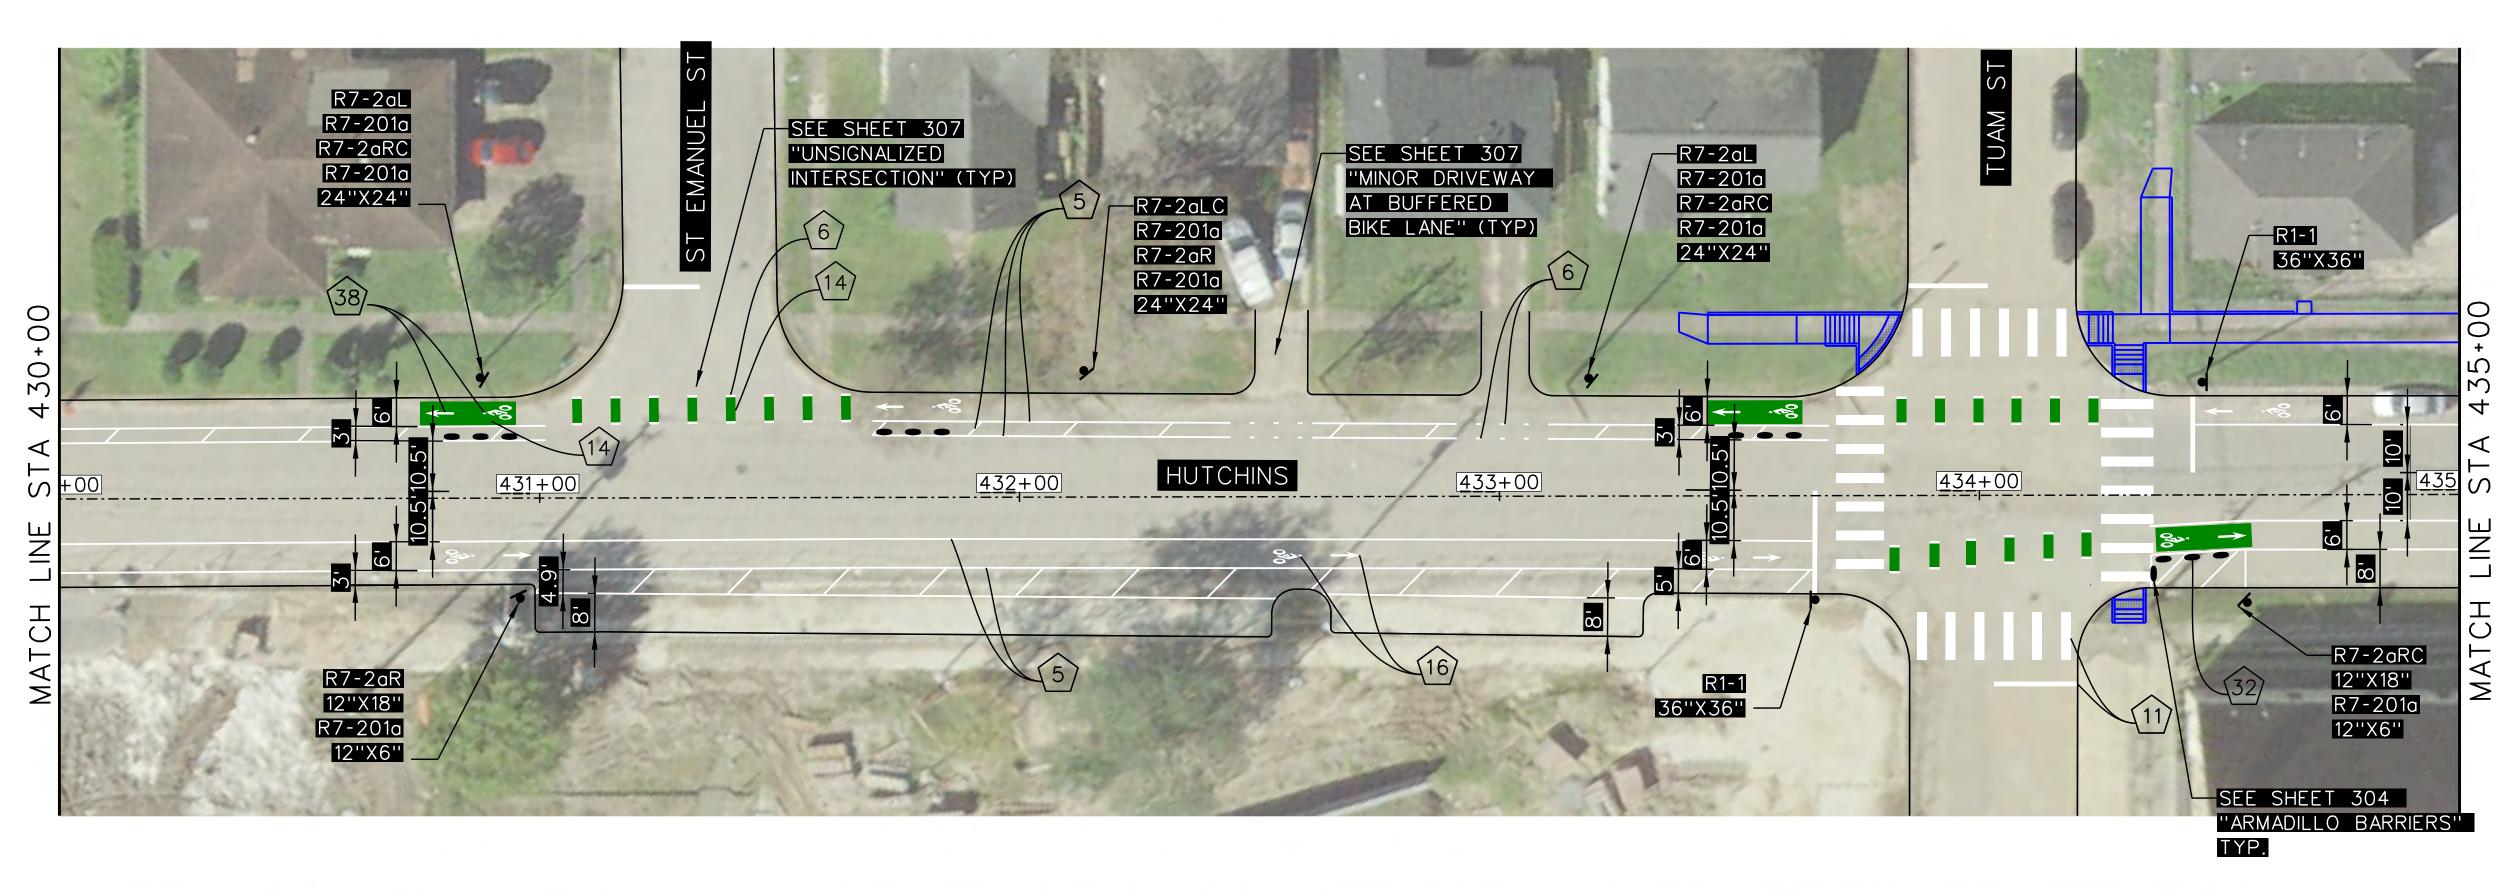


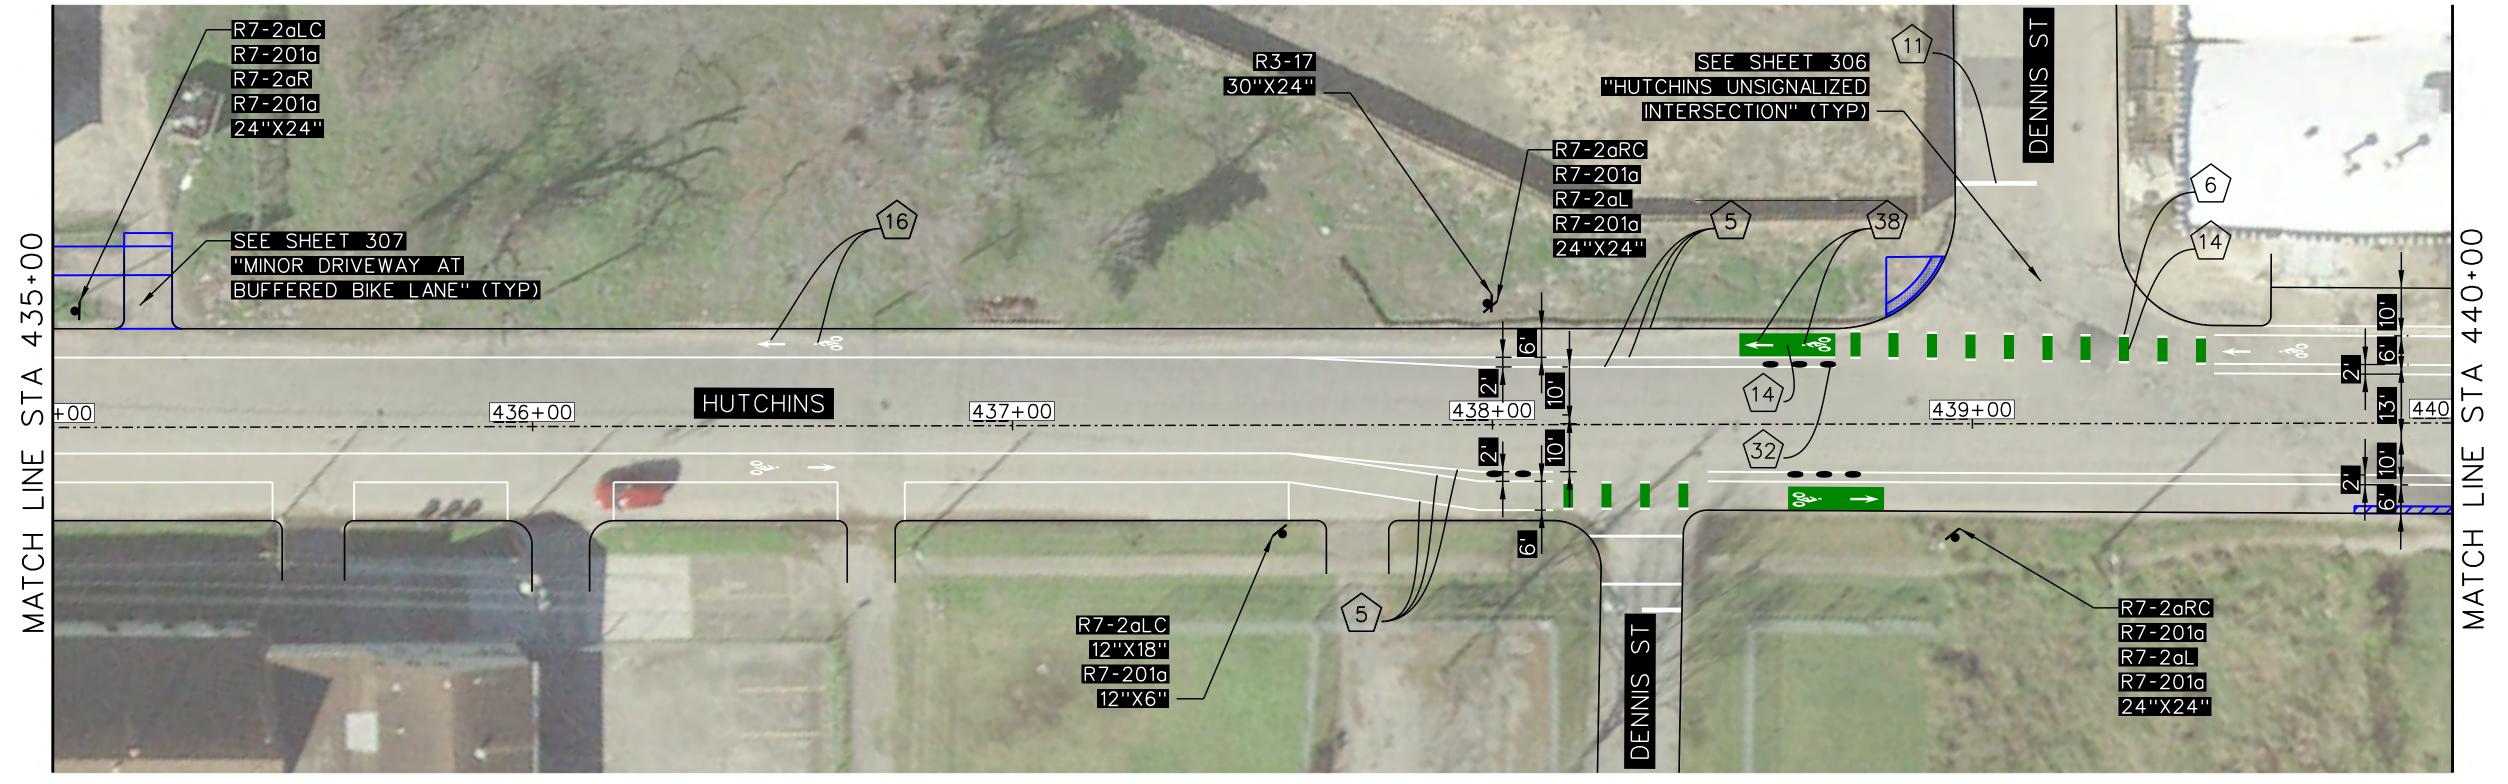

- 1. CONTRACTOR SHALL ERADICATE ALL EXISTING CONFLICTING PAVEMENT MARKINGS
- 2. SEE SHEET 302 FOR SIGNING AND PAVEMENT MARKING LEGEND
- 3. SEE SHEETS 401-409 FOR PAVEMENT REPAIR AND CONCRETE WORK.


PAVEMENT	4	O LF	11)	362 LF	32)	21 EA
MARKING QUANTITIES	5	3495 LF	14)	404 SF	38)	8 EA
STA. 430+00	6	158 LF	(16)	14 EA		
TO 440+00	8	37 LF	17)	0 SF		

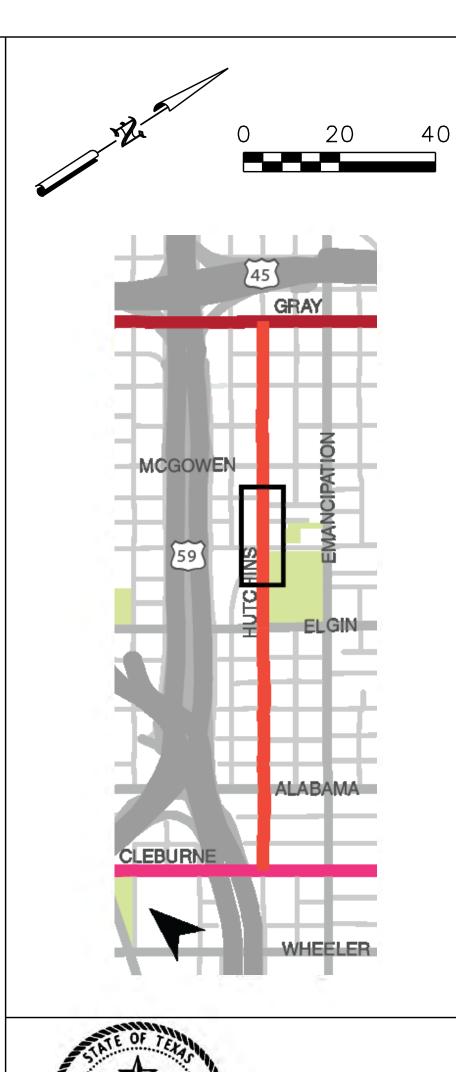

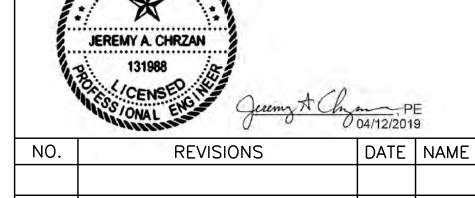


TOOLE DESIGN


8484 Georgia Avenue, Suite 800, Silver Spring, MD 20910 TEL (301) 927-1900 TBPE Registration No. 14667

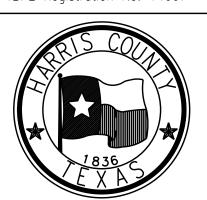


HARRIS COUNTY

	LLINING DLI AIN					
PROJECT TITLE: HUTCHINS/CLEBURNE STREETS ON-STREET BIKEWAY						
CB/FL	SHEET DESCRIPTION: SIGNING AND PAVEMENT MARKIN	IG LAYOUT				
CK'D BY: JC						
SCALE: 1"=20'	SHEET 4 OF 9					
DATE: 04/12/19	APPROVED BY:					
		SHEET NO: 204				

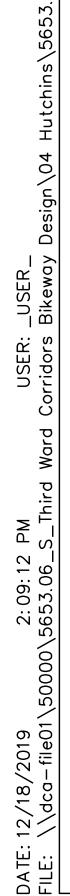


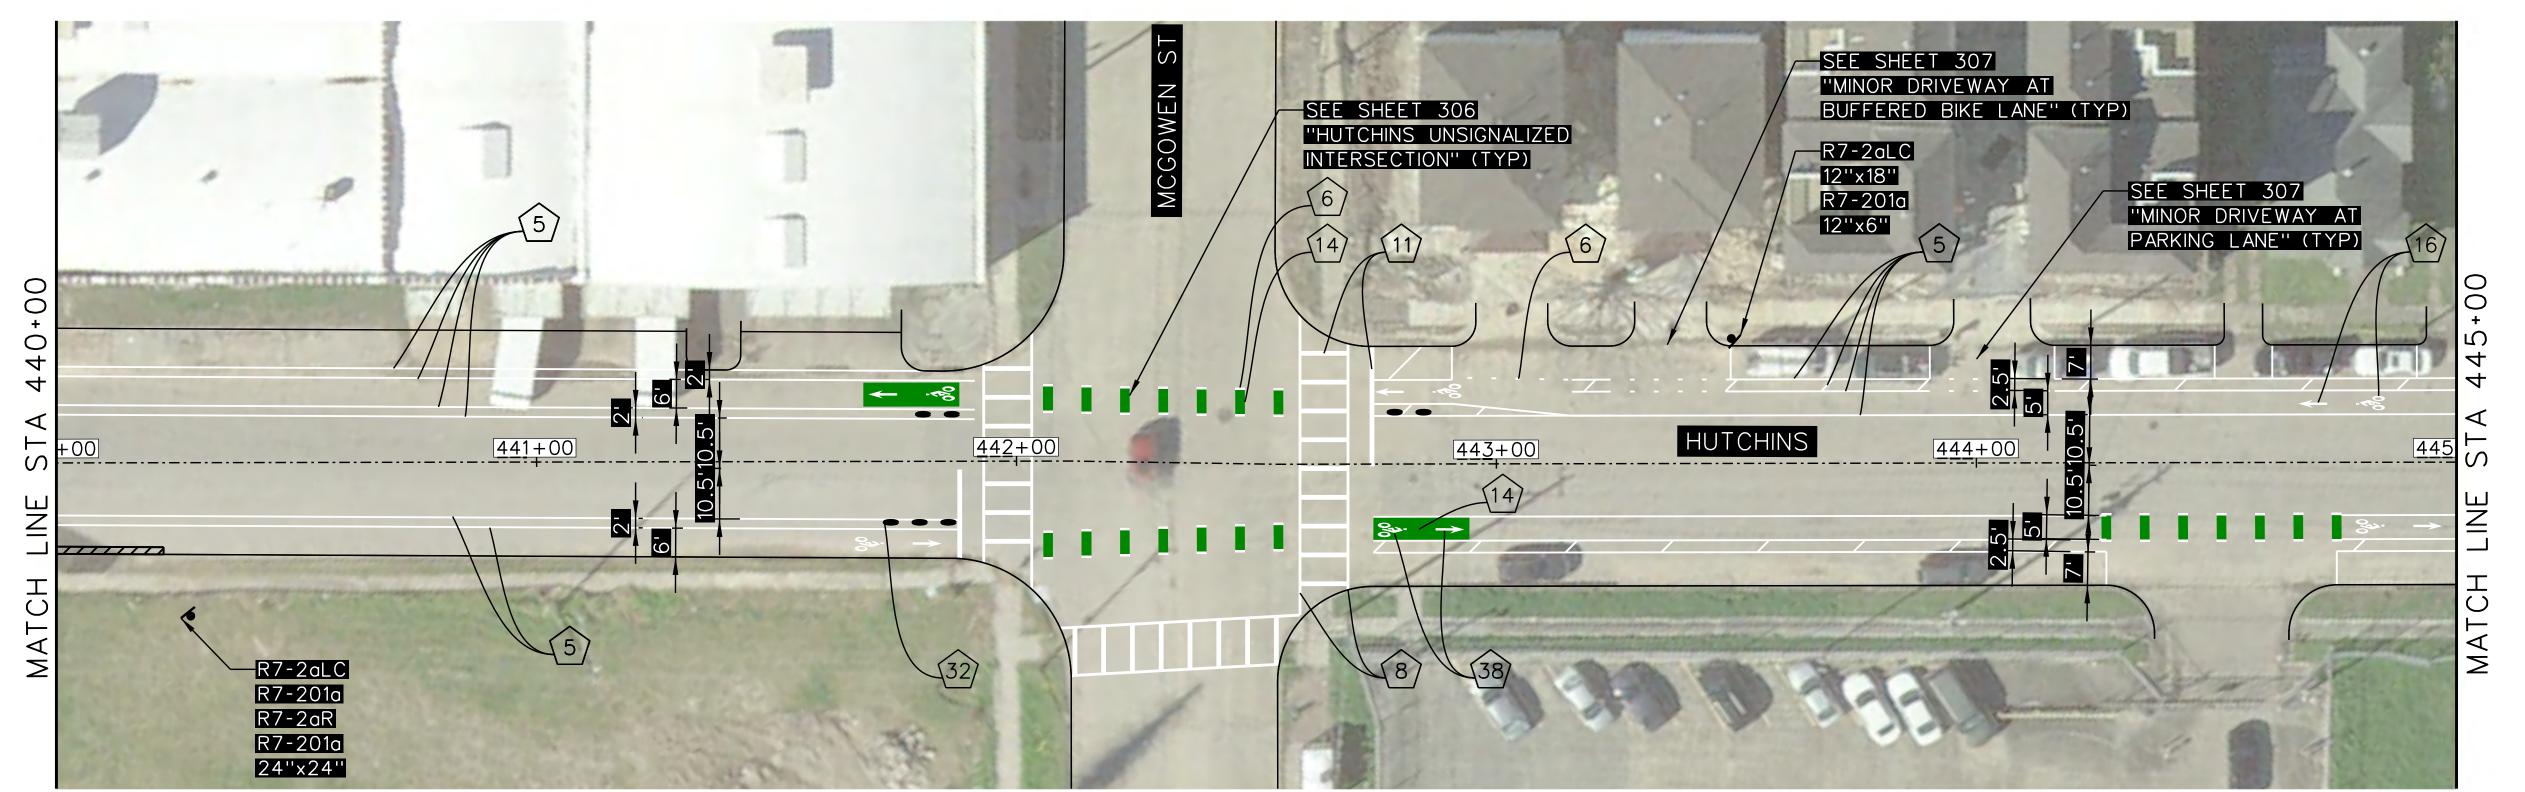


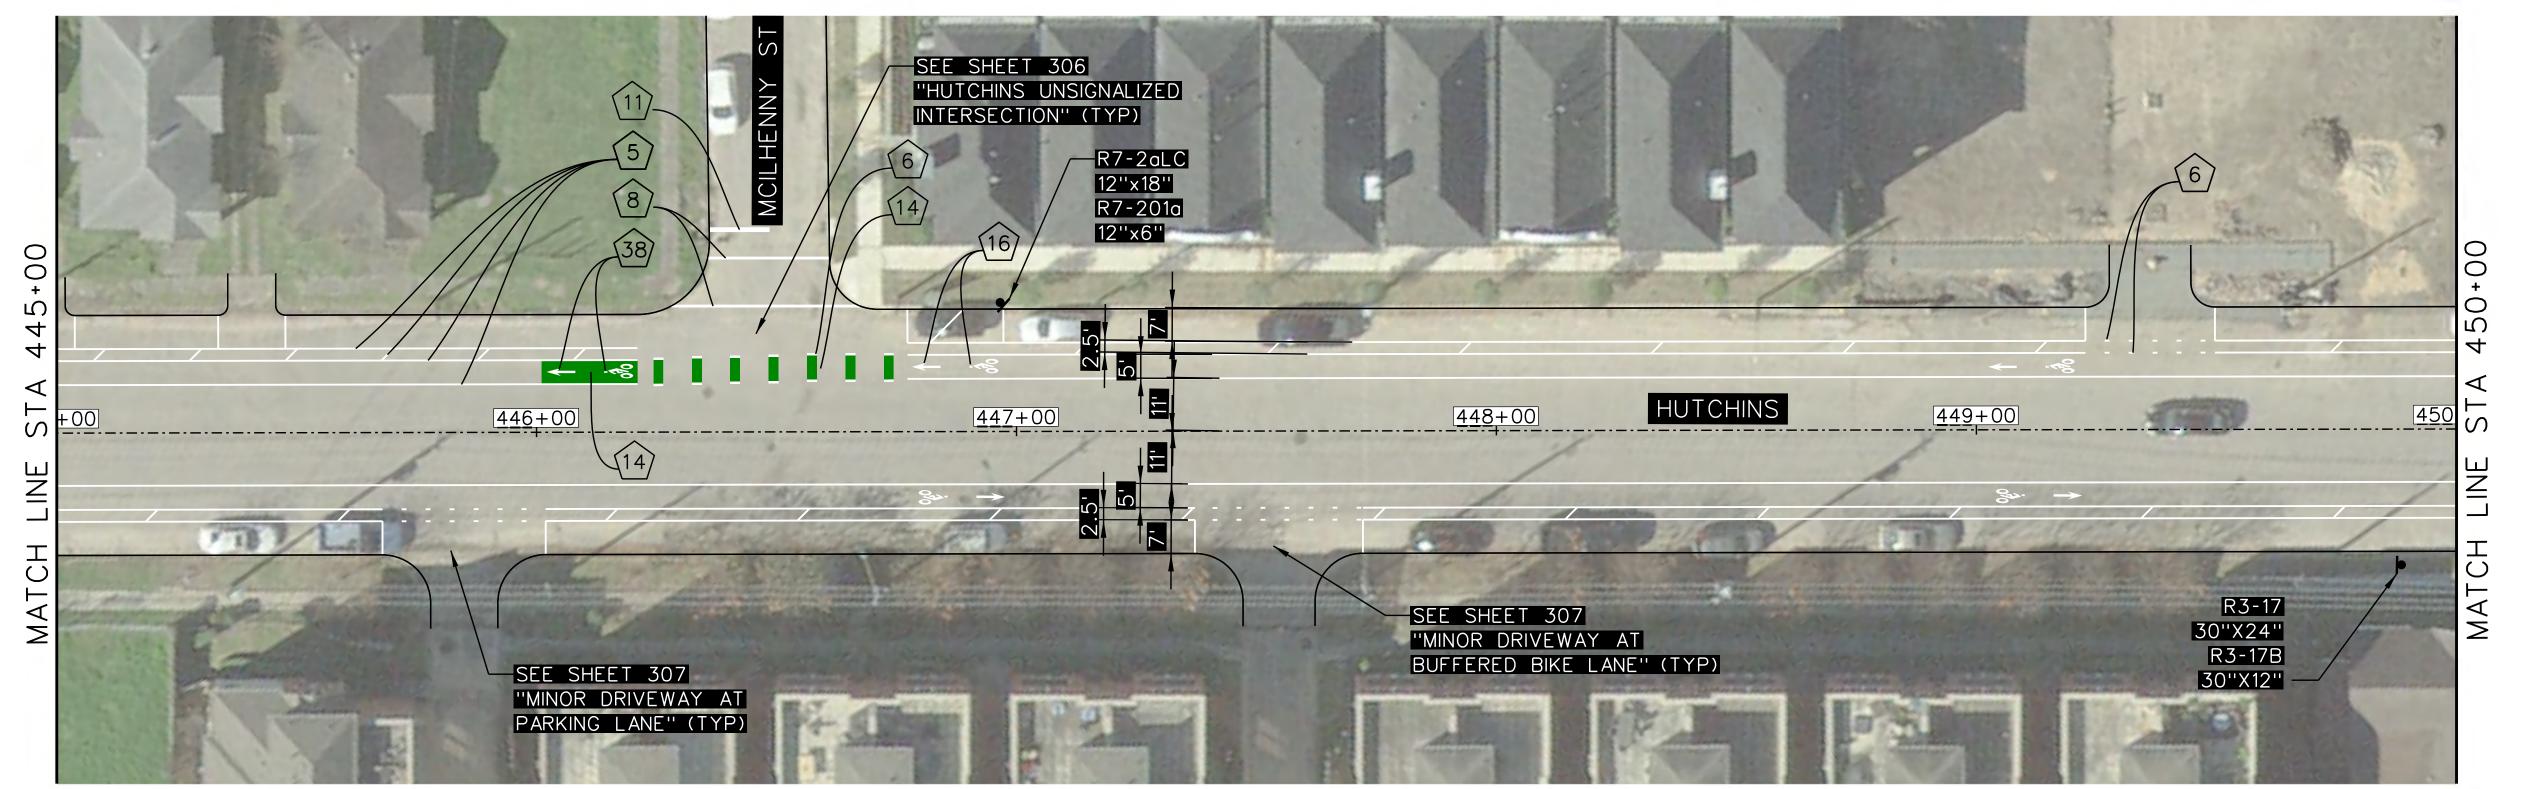

- 1. CONTRACTOR SHALL ERADICATE ALL EXISTING CONFLICTING PAVEMENT MARKINGS
- 2. SEE SHEET 302 FOR SIGNING AND PAVEMENT MARKING LEGEND
- 3. SEE SHEETS 401-409 FOR PAVEMENT REPAIR AND CONCRETE WORK.


PAVEMENT	4	O LF	11	297 LF	32)	8 EA
MARKING QUANTITIES	(5)	5147 LF	14	328 SF	\(\frac{\gamma}{3}\)	6 EA
STA. 440+00	(G)	198 LF	$\langle 16 \rangle$	16 EA		
TO 450+00	(80)	367 LF	17)	0 SF		

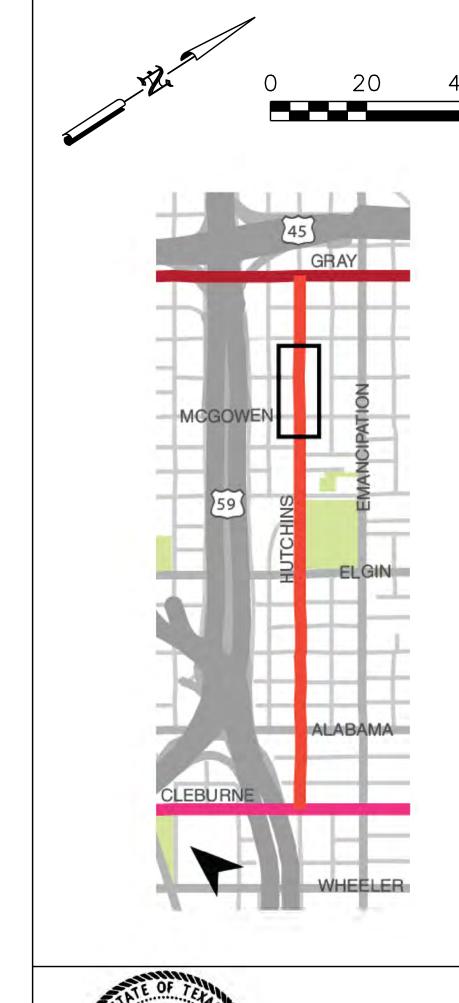

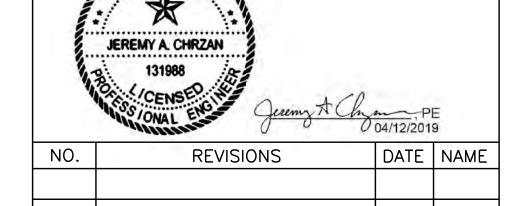


TOOLE DESIGN

8484 Georgia Avenue, Suite 800, Silver Spring, MD 20910 TEL (301) 927-1900 TBPE Registration No. 14667

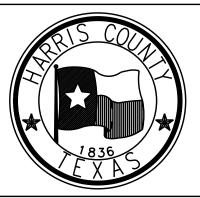

HARRIS COUNTY

HUTCHINS/	PROJECT TITLE: HUTCHINS/CLEBURNE STREETS ON-STREET BIKEWAY						
DRAWN BY: SHEET DESCRIPTION: CB/FL SIGNING AND PAVEMENT MARKING LAYOUT							
CK'D BY: JC							
SCALE: 1"=20'	SHEET 5 OF 9						
DATE: 04/12/19	APPROVED BY:						
	SHEET NO:						
	205						

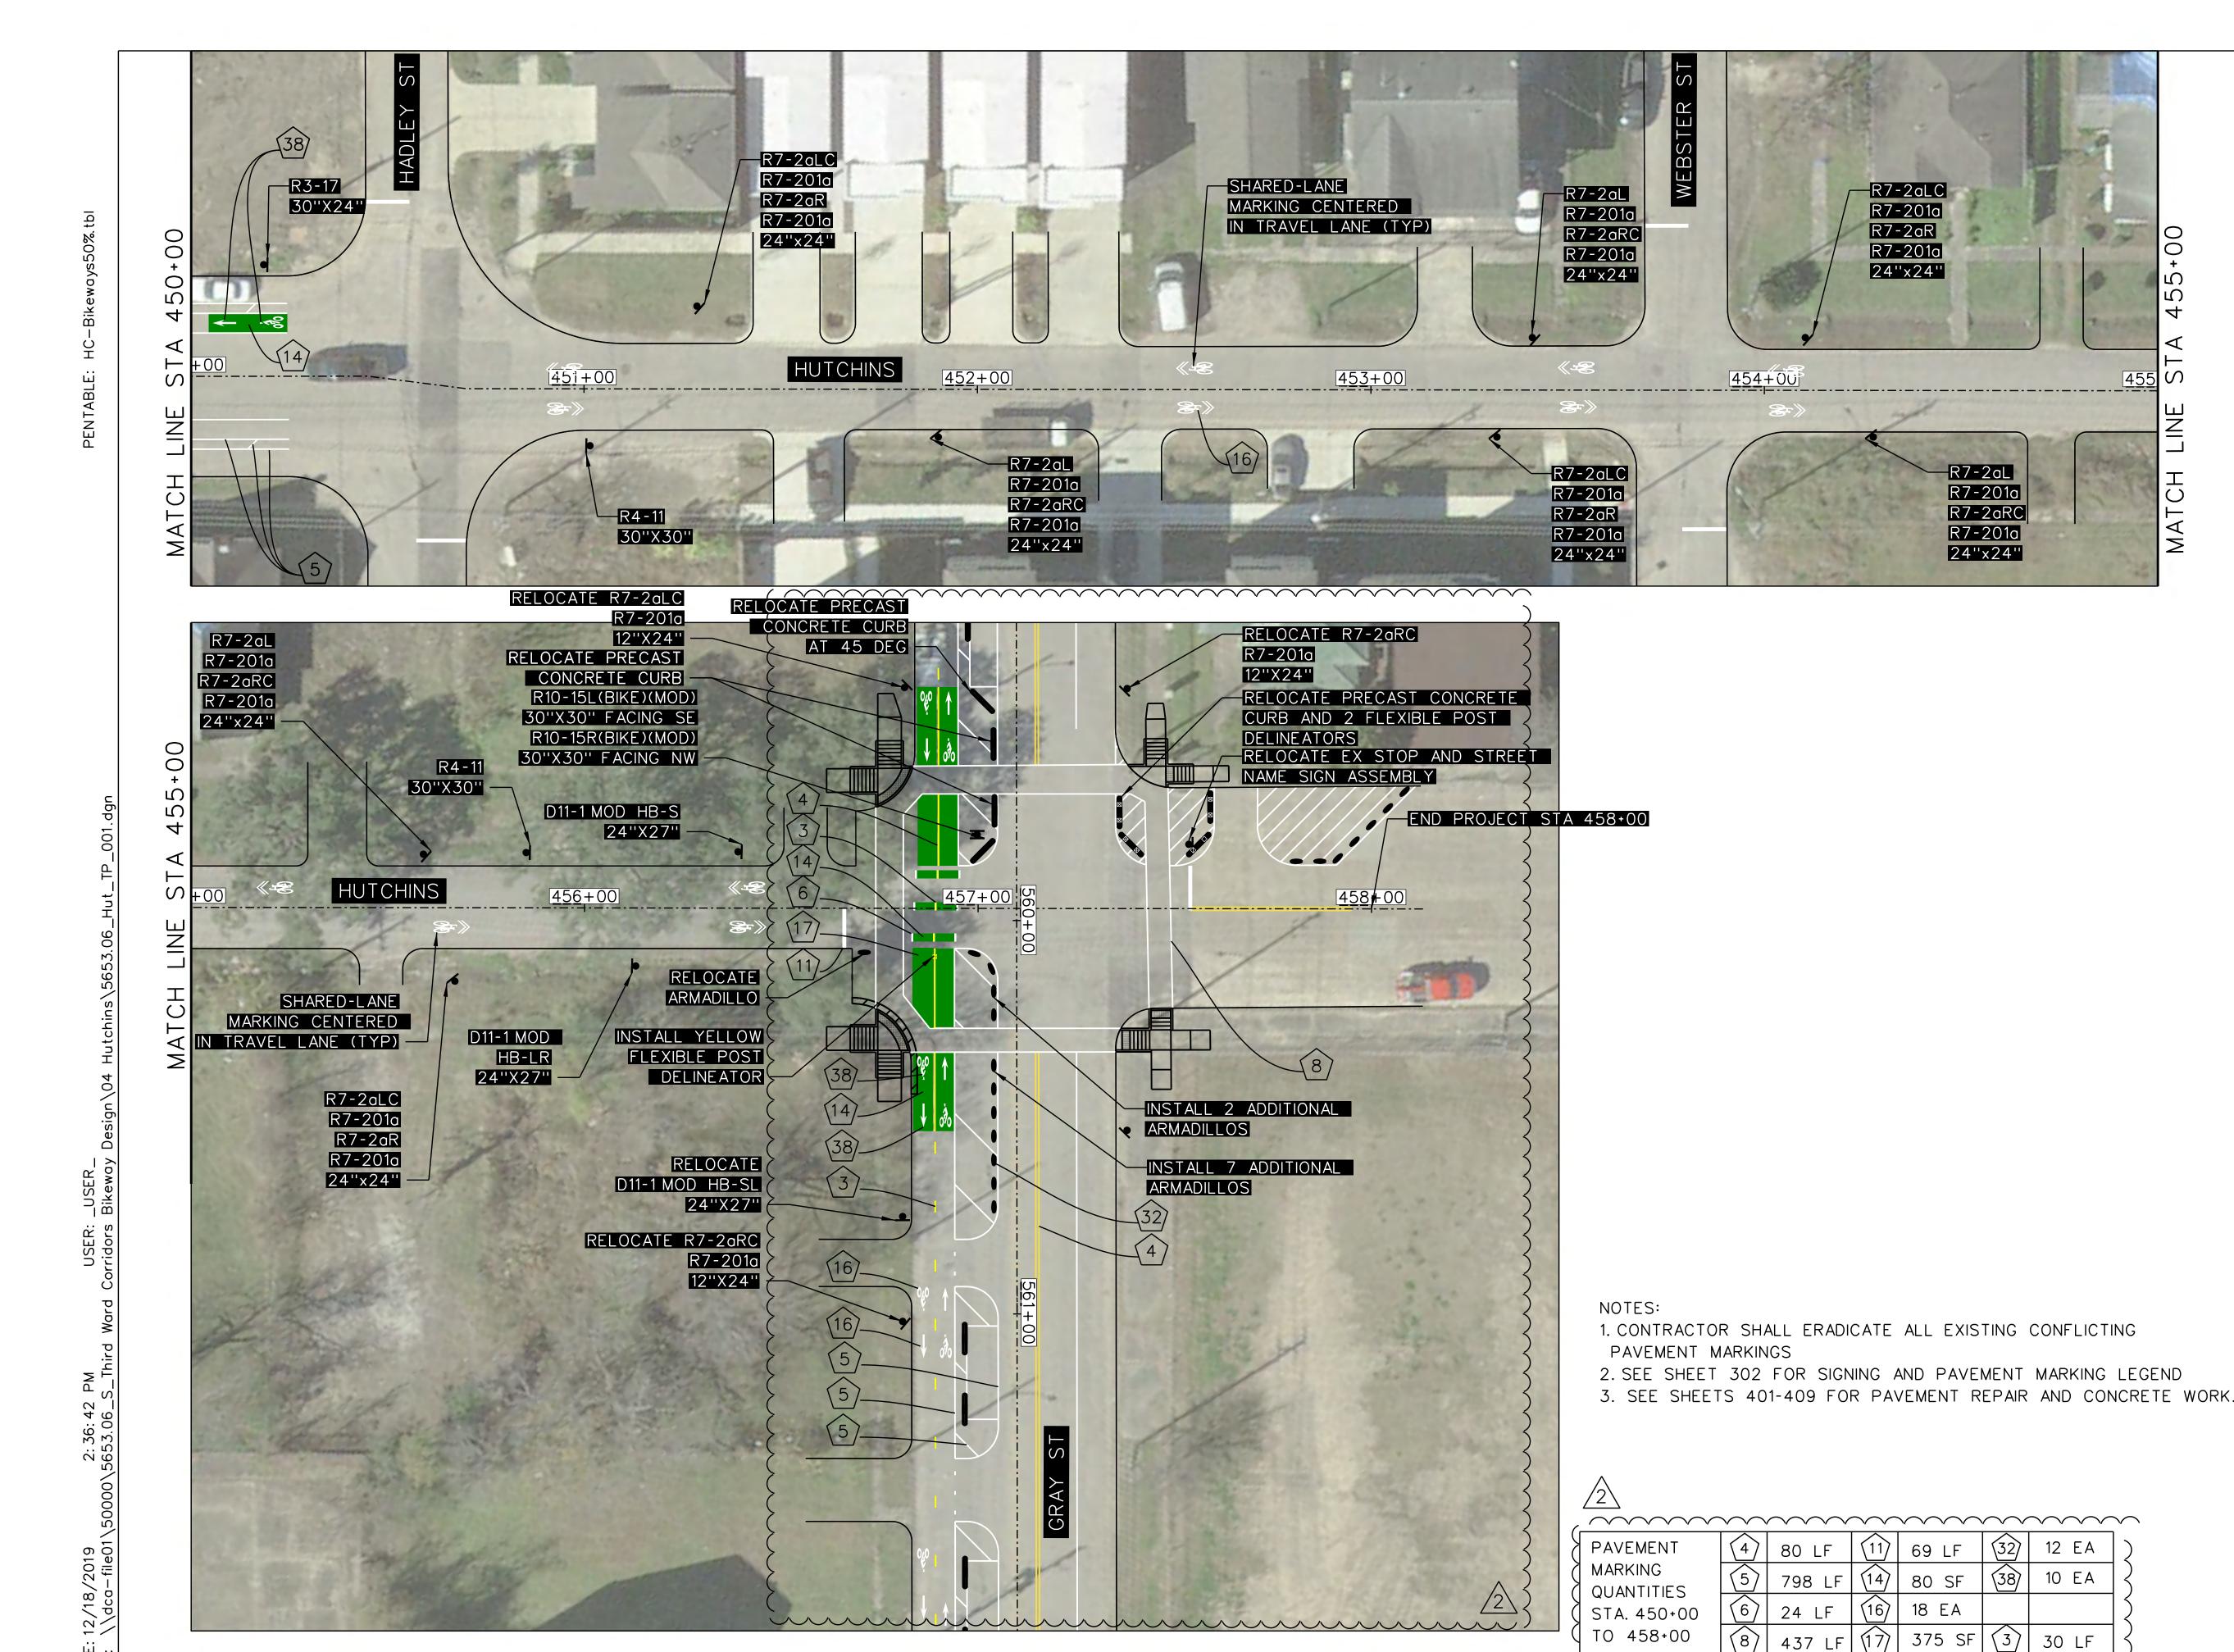



	1,2,13,0,13	.	·
2	ADD PROPOSED FOR GRAY	10/17	CCB

TOOLE DESIGN

8484 Georgia Avenue, Suite 800, Silver Spring, MD 20910 TEL (301) 927-1900 TBPE Registration No. 14667




HARRIS COUNTY

ENGINEERING DEPARTMENT

PROJECT TITLE:
HUTCHINS/CLEBURNE STREETS ON-STREET BIKEWAY
DRAWN BY: | SHEET DESCRIPTION:
CB/FL | SIGNING AND PAVEMENT MARKING LAYOUT CK'D BY: SCALE: SHEET 6 OF 9 1"=20' APPROVED BY: 04/12/19 SHEET NO: 206







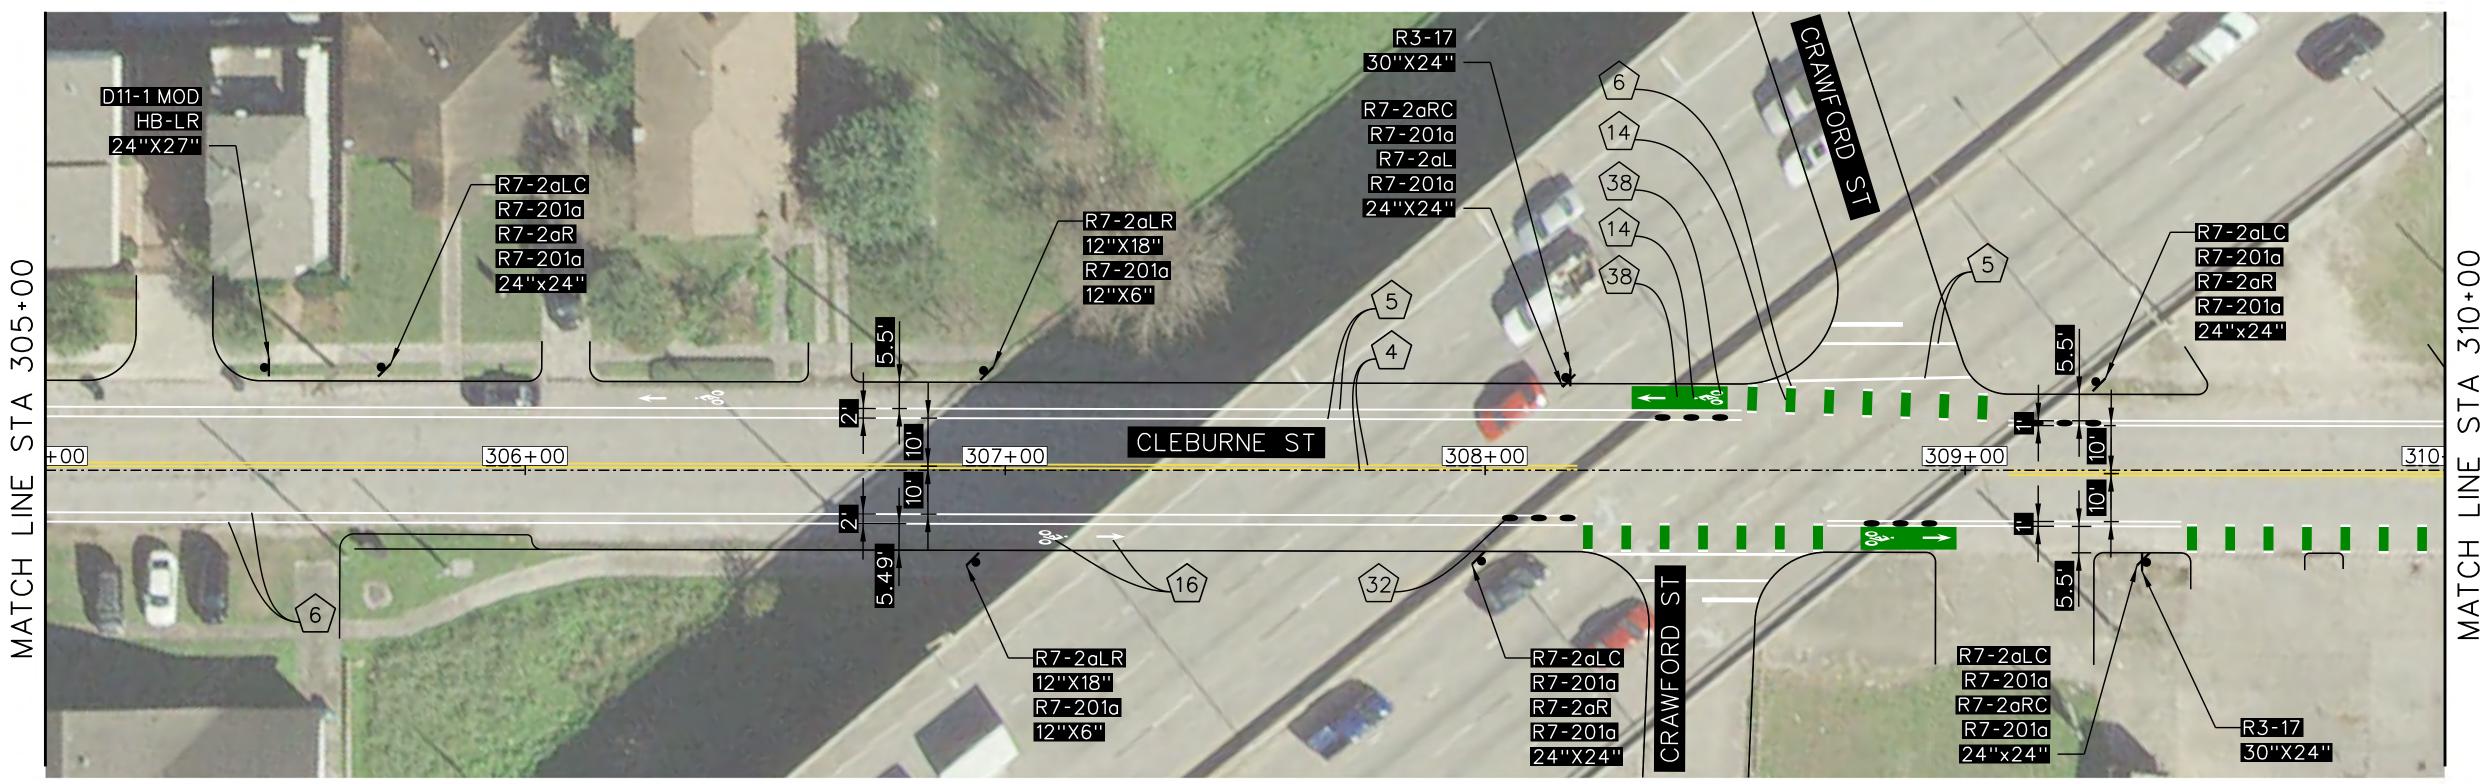


- 1. CONTRACTOR SHALL ERADICATE ALL EXISTING CONFLICTING PAVEMENT MARKINGS
- 2. SEE SHEET 208 FOR SIGNING AND PAVEMENT MARKING LEGEND
- 3. FOR PROPOSED WORK AT THE INTERSECTION OF CLEBURNE STREET AND LA BRANCH STREET, SEE PLANS FOR AUSTIN STREET

PAVMENT	4	453 LF	$\langle 11 \rangle$	94 LF	32)	18 EA
MARKING QUANTITIES	5	1708 LF	14)	258 SF	38	7 EA
STA. 303+75	6	40 LF	(16)	4 EA		
TO 310+00	8	376 LF	17)	16 SF		

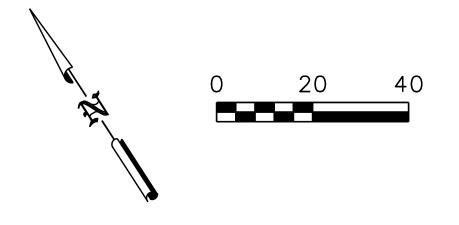

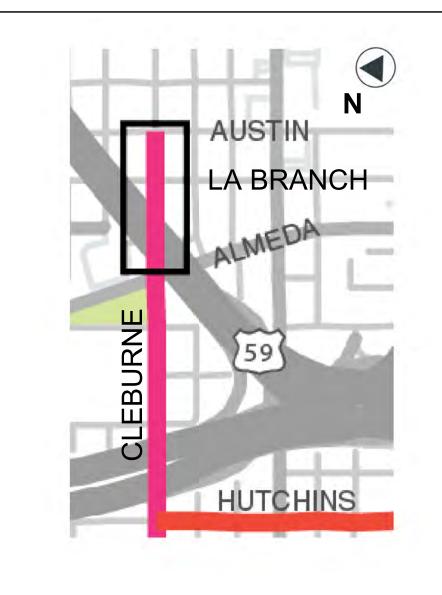


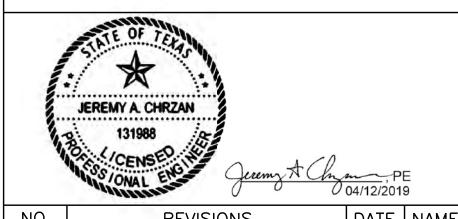

NO.	REVISIONS	DATE	NAME

TOOLEDESIGN


8484 Georgia Avenue, Suite 800, Silver Spring, MD 20910
TEL (301) 927-1900
TBPE Registration No. 14667

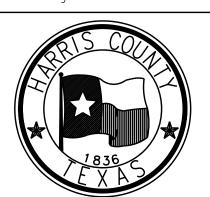



HARRIS COUNTY


PROJECT TITL					
HUTCHINS/(CLEBURNE STREETS ON-STR	EET BIKEWAY			
DRAWN BY:					
CB/FL	SIGNING AND PAVEMENT MARK	ING LAYOUT			
CK'D BY:					
JC					
SCALE:	SHEET 7 OF 9				
1"=20'	SHEET / OF 9				
DATE:	APPROVED BY:				
04/12/19					
		SHEET NO:			
		207			



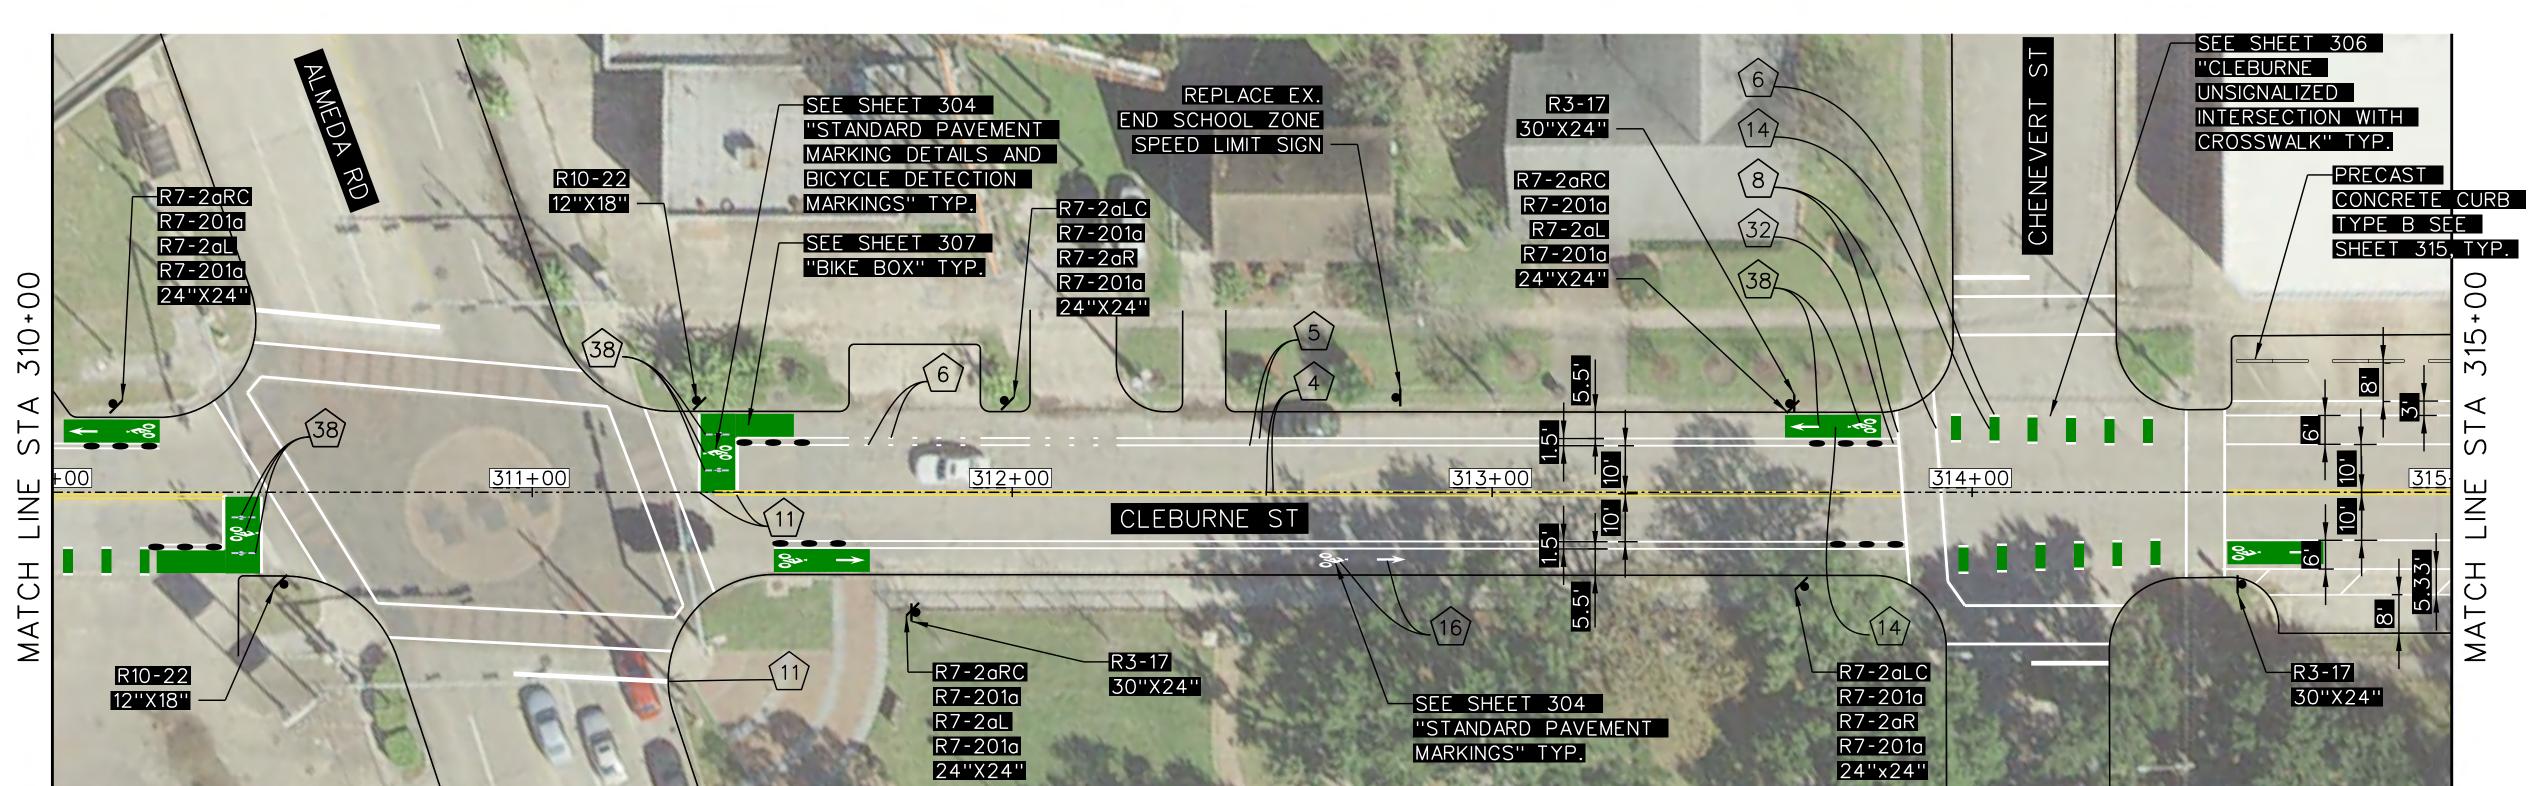


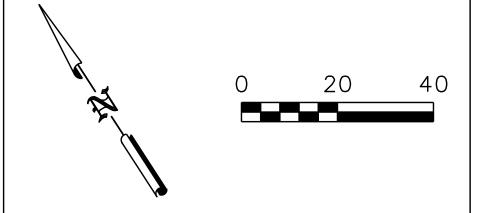

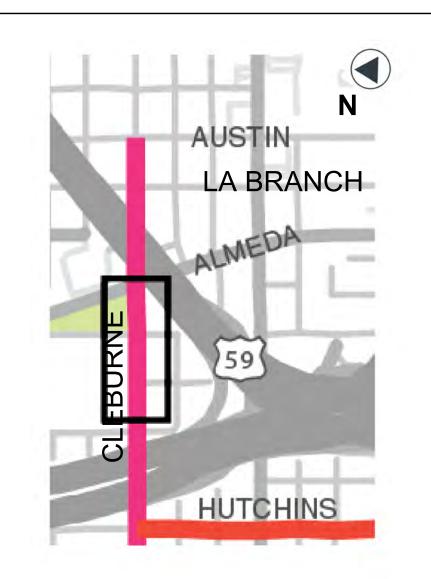

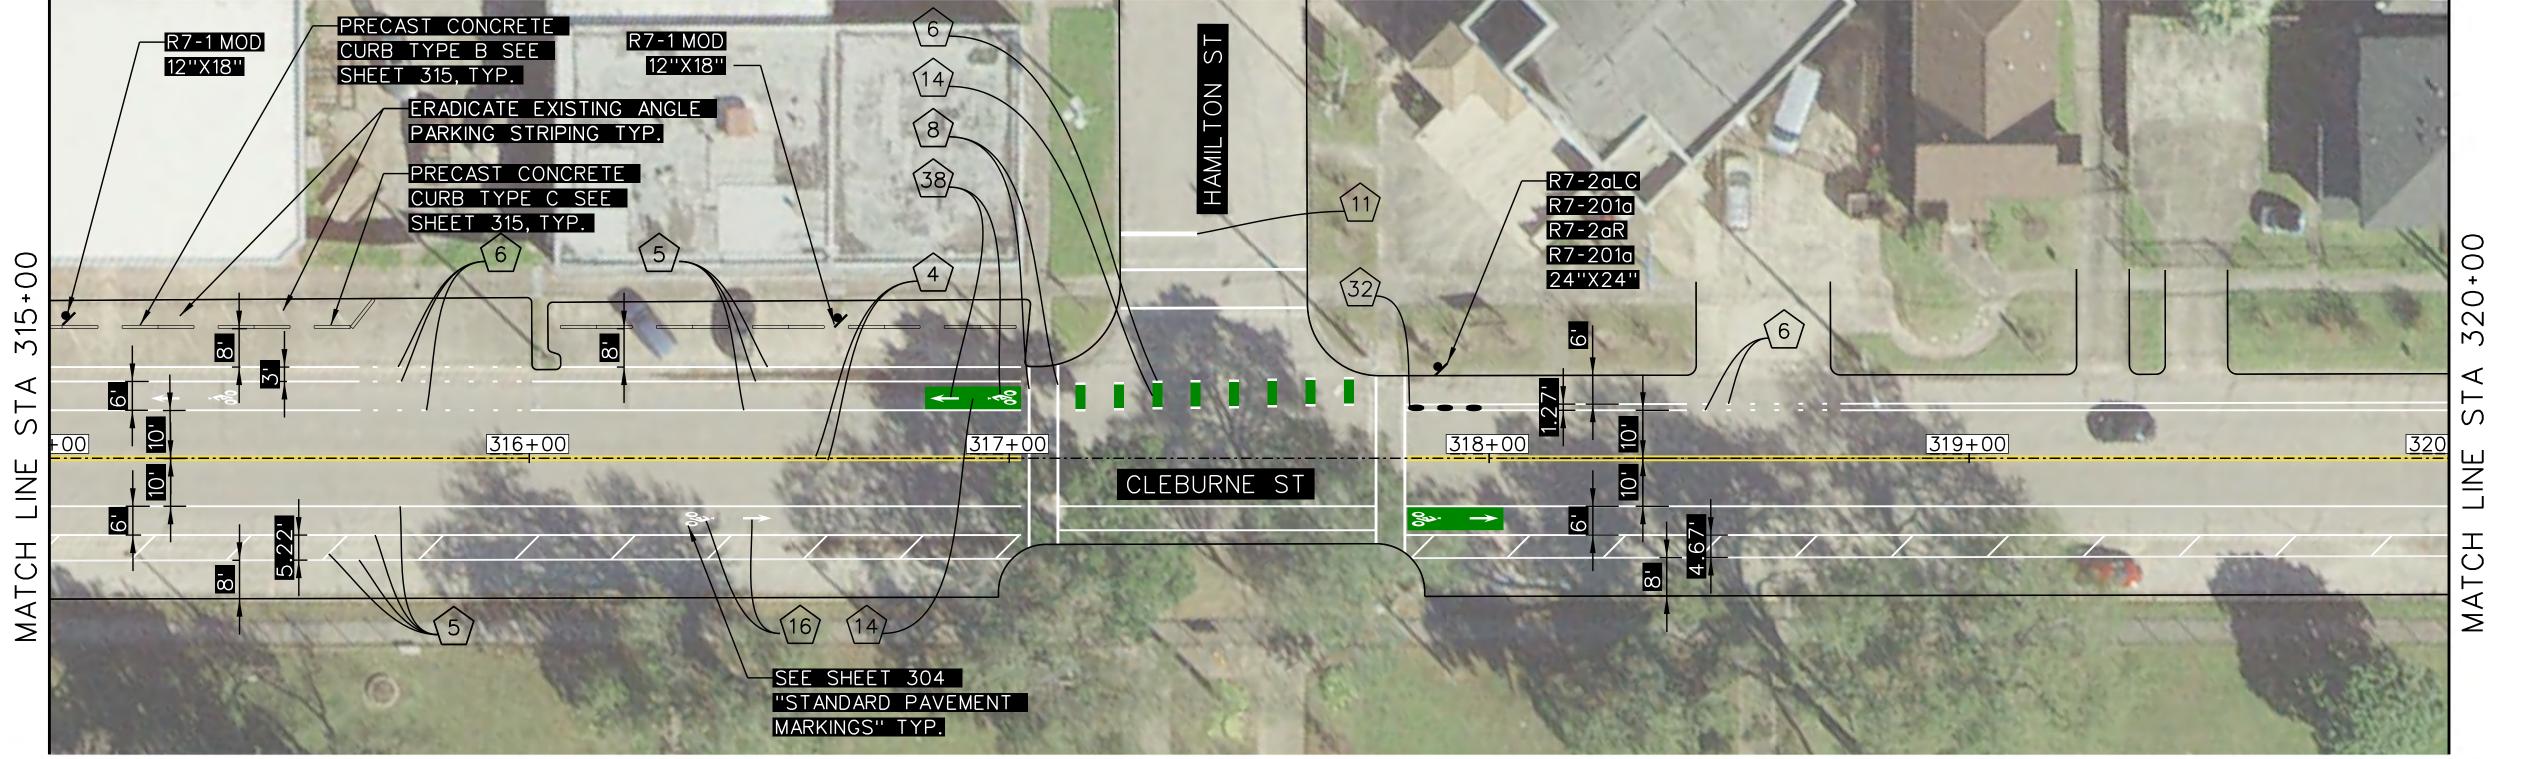


- 1. CONTRACTOR SHALL ERADICATE ALL EXISTING CONFLICTING PAVEMENT MARKINGS
- 1520 LF (11) 120 LF 32 21 EA PAVMENT MARKING 314 SF (38) 3543 LF (14) 2. SEE SHEET 208 FOR SIGNING AND PAVEMENT MARKING LEGEND QUANTITIES 309 LF (16) 6 EA STA. 310+00 TO 320+00 965 LF | (17) | 460 SF

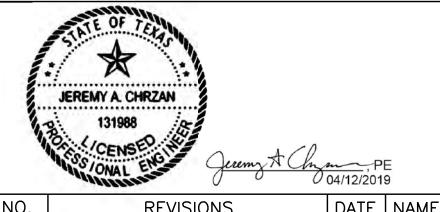

NO.	REVISIONS	DATE	NAME

TOOLE DESIGN

8484 Georgia Avenue, Suite 800, Silver Spring, MD 20910 TEL (301) 927-1900 TBPE Registration No. 14667

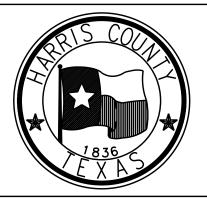


HARRIS COUNTY


ENGINEERING DEPARTMENT


PROJECT TITL	E:				
HUTCHINS/CLEBURNE STREETS ON-STREET BIKEWAY					
DRAWN BY:	DRAWN BY: SHEET DESCRIPTION:				
CB/FL	SIGNING AND PAVEMENT MARK	ING LAYOUT			
CK'D BY:					
JC					
SCALE:	SHEET 8 OF 9				
1"=20'					
DATE:	APPROVED BY:				
04/12/19					
		SHEET NO:			
		208			


18 EA



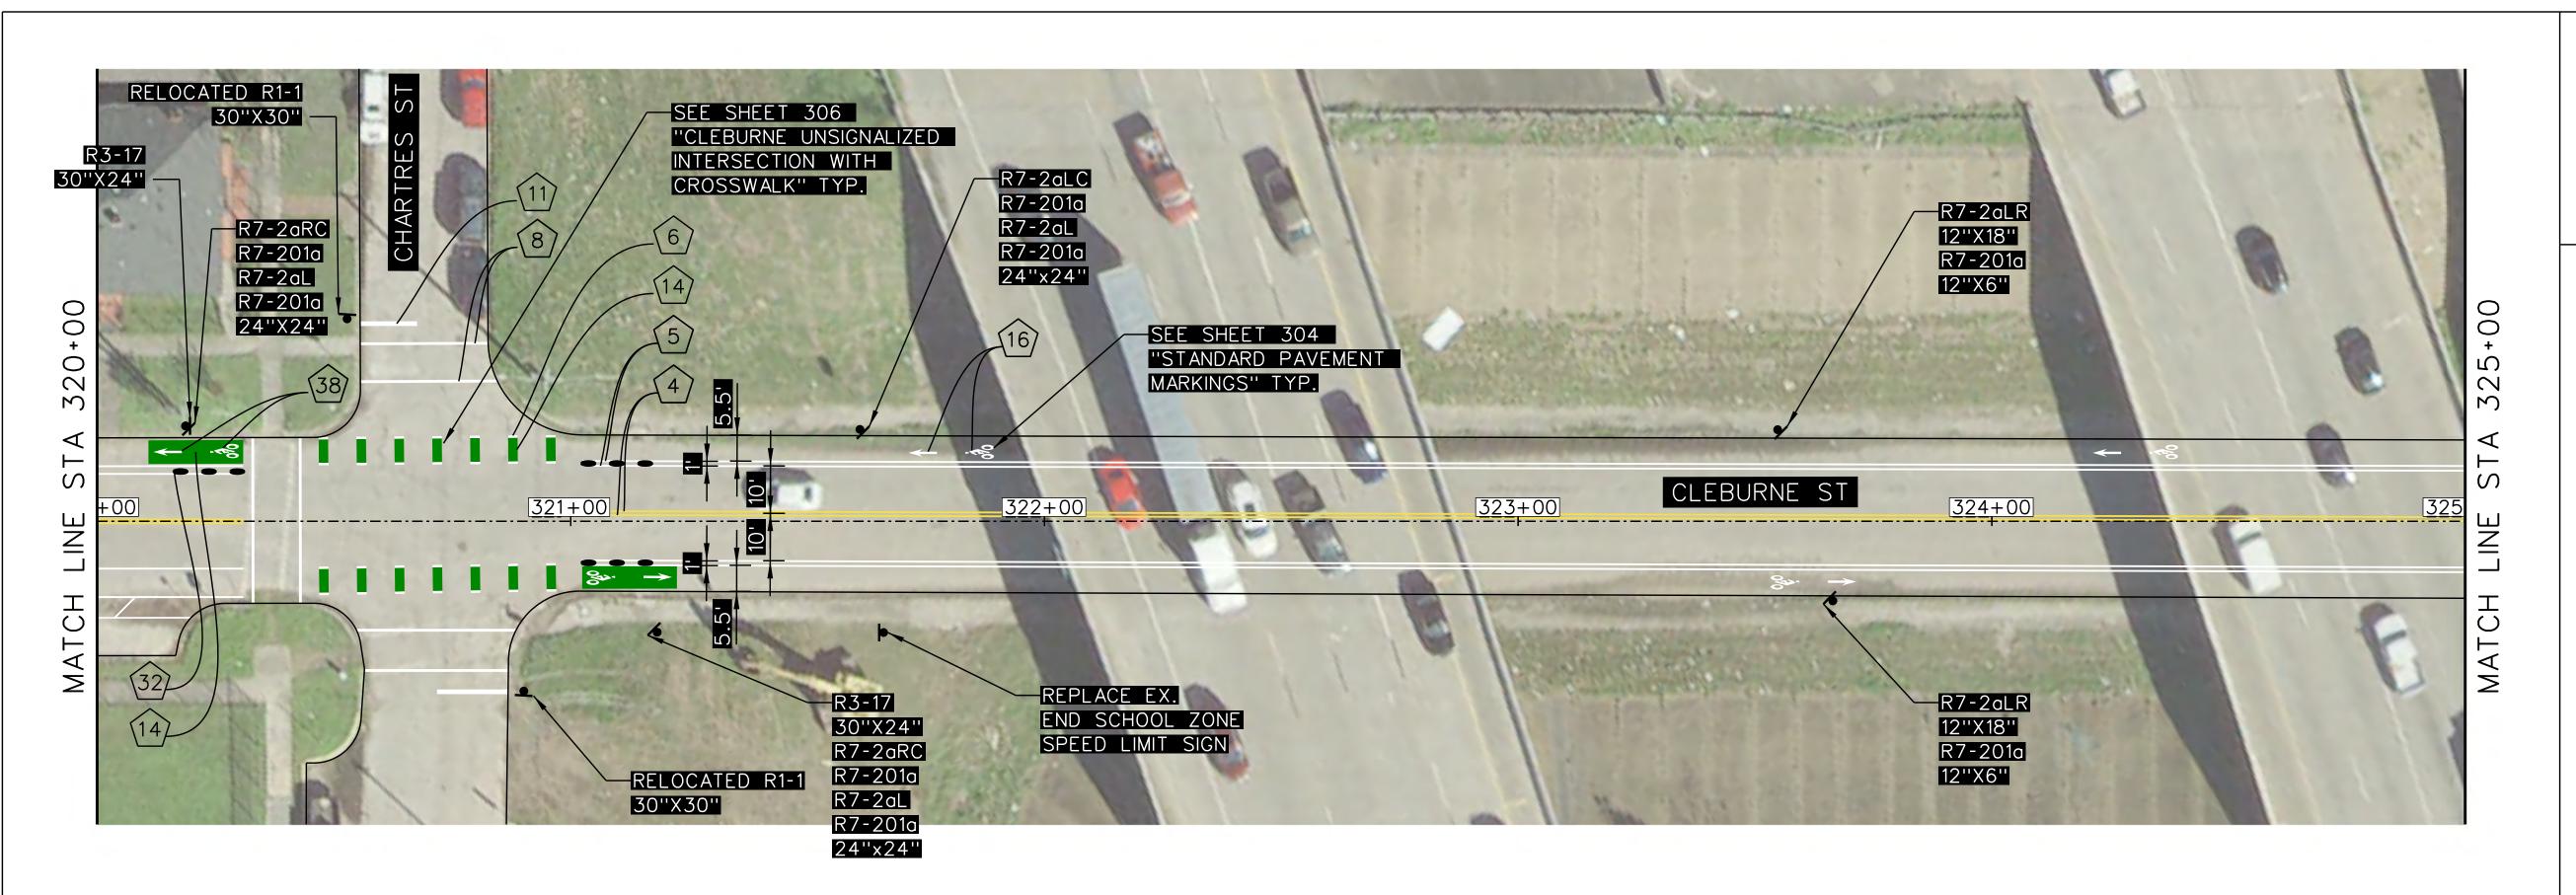

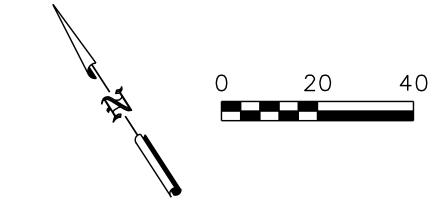

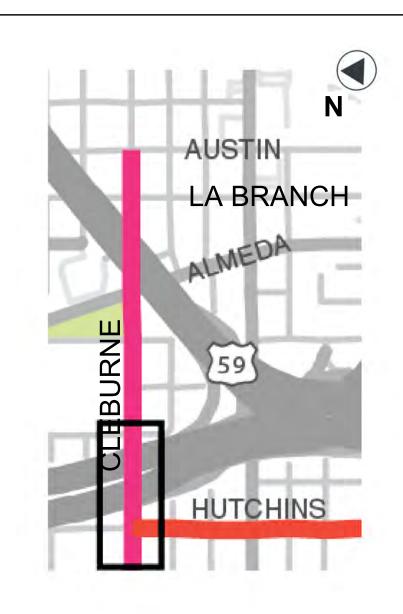


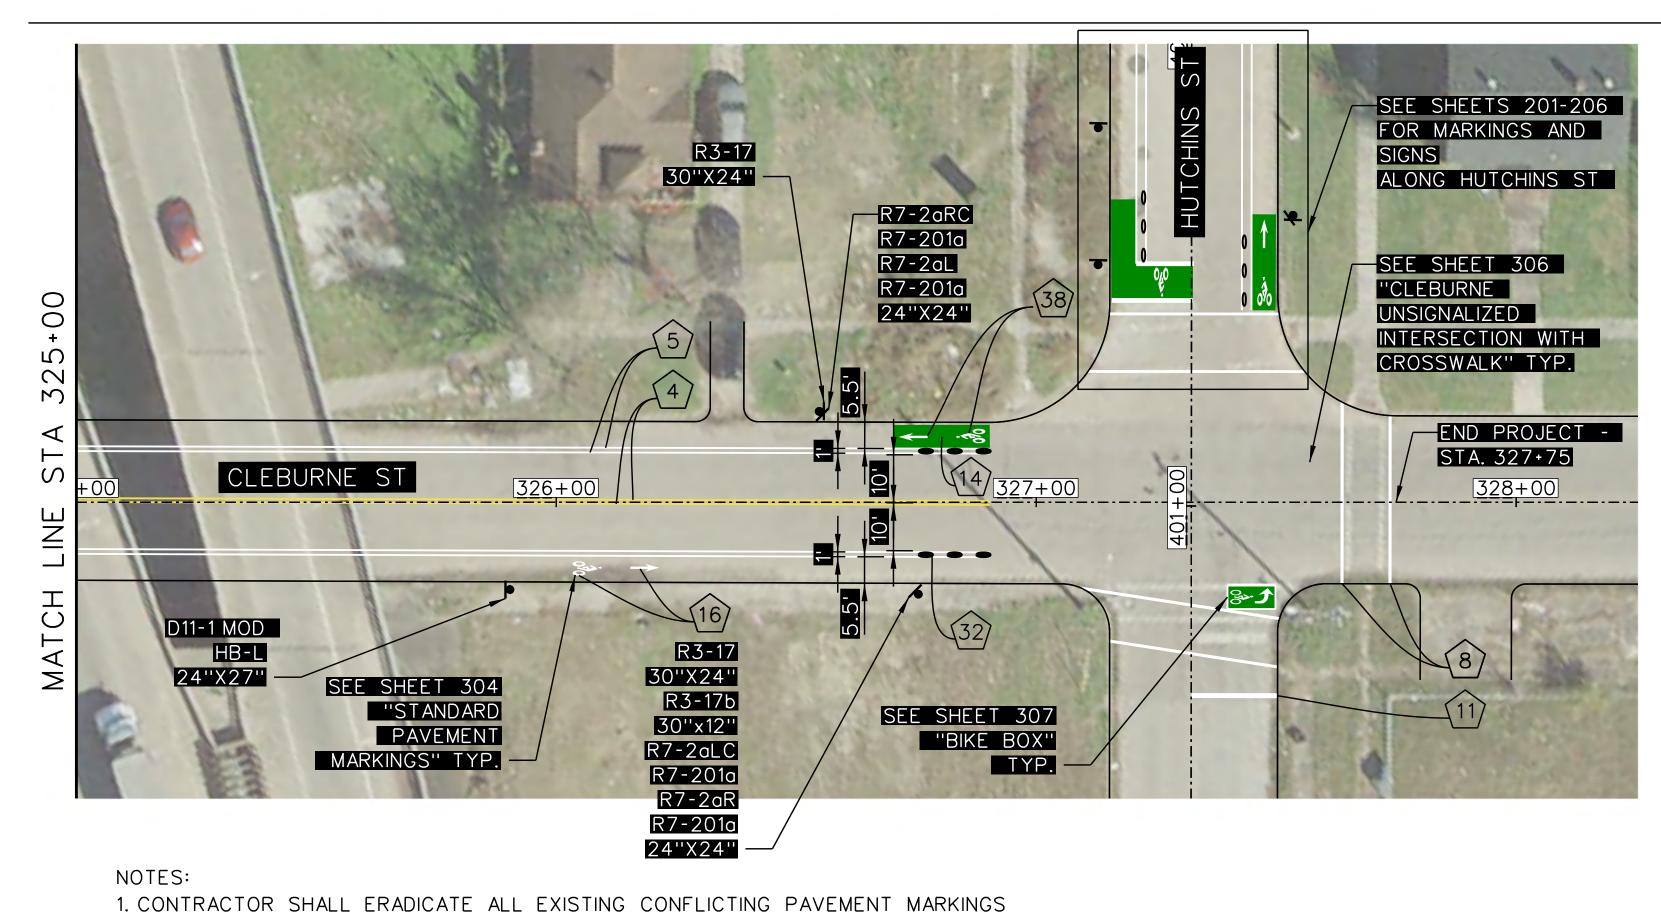

2. SEE SHEET 208 FOR SIGNING AND PAVEMENT MARKING LEGEND

3. FOR PROPOSED WORK ON HUTCHINS STREET, SEE SHEETS 201 THROUGH 206.


PAVMENT	4	1238 LF	$ \langle 11 \rangle $	45 LF	(32)	15 EA
MARKING	(5)	2523 LF	(14)	172 SF	(38)	7 EA
QUANTITIES STA. 320+00	6	55 LF	(16)	6 EA		
TO 328+00	8	349 LF	(17)	16 SF		

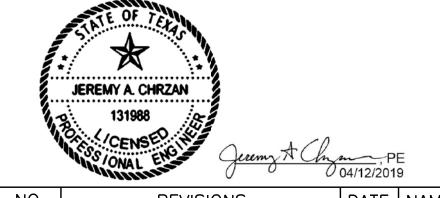

NO.	REVISIONS	DATE	NAME


TOOLE DESIGN

8484 Georgia Avenue, Suite 800, Silver Spring, MD 20910 TEL (301) 927-1900 TBPE Registration No. 14667

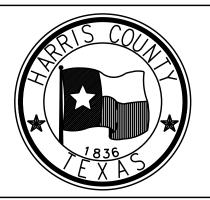

HARRIS COUNTY

		1				
	PROJECT TITLE:					
	CLEBURNE STREETS ON-STREET BIKEW	<u> </u>				
	SHEET DESCRIPTION:					
CB/FL	SIGNING AND PAVEMENT MARKING LAYOUT					
CK'D BY:						
JC						
SCALE:	SHEET 9 OF 9					
1"=20'						
DATE:	APPROVED BY:					
04/12/19						
	SHEET NO):				
	209					

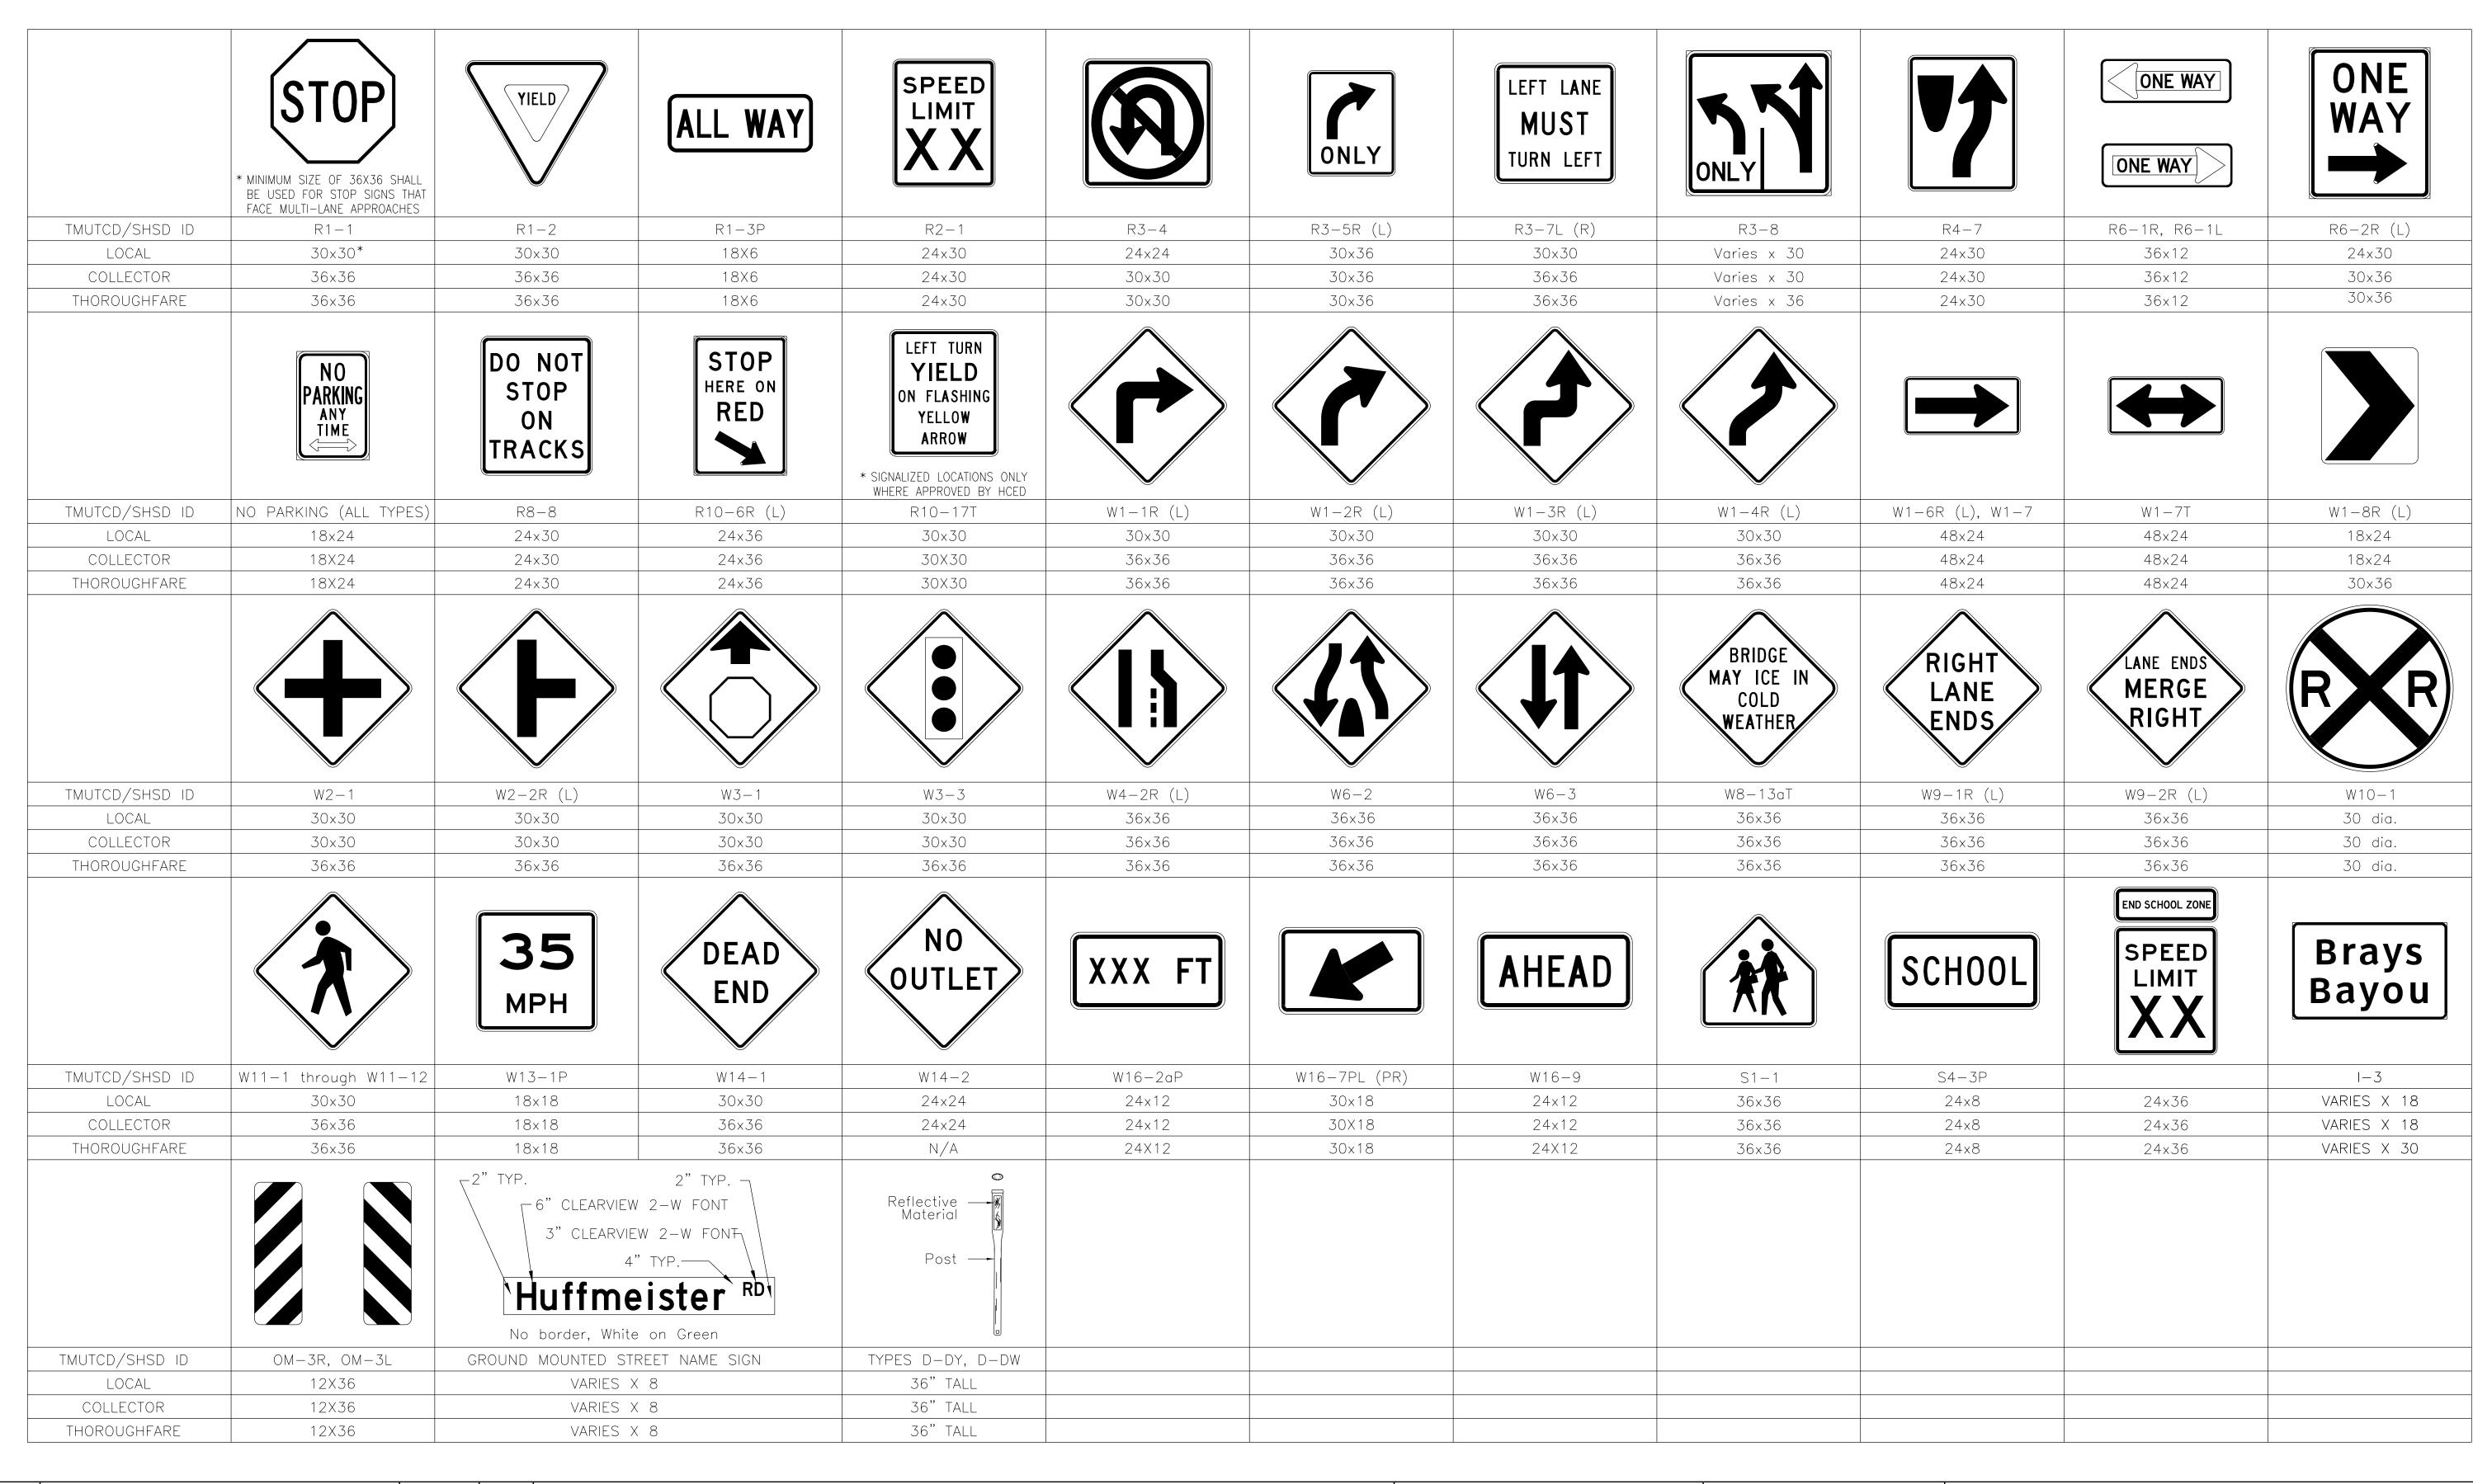

NO.	REVISIONS DATE NA	AE .		PROJECT TITLE: HUTCHINS/CLEBURNE STREETS ON-STREET BIKEWAY
			1'OOLE	HOTCHINS/ CELBONNE STREET BIREWAT
			DESIGN	SHEET DESCRIPTION:
$\overline{\wedge}$			8484 Georgia Avenue, Suite 800, Silver Spring, MD 20910	SMALL SIGN DETAILS
		1 + N(31N++ K1N(3 1)+ PAK1M+ N1	TEL (301) 927-1900 TEDE Desistration No. 14667	DRAWN BY: SHEET 1 OF 1
			TBPE Registration No. 14667	CB/FL CB/FL CB/FL CK'D BY: SCALE: S O4/12/2019 JC NTS

TRAFFIC STANDARD

DATE: 03/19/19 SHEET NO: 301



R10-15L(BIKE) 30×30 SEE DETAIL SHEET 314



R10-15R(BIKE) 30×30 SEE DETAIL SHEET 314



BEGIN RIGHT TURN LANE

36×12

R4 - 436×30

YIELD TO BIKES



R4-11 30×30

BIKE LANE

R3-17

30×24

ENDS

R3-17b


30x12





R3-7bP 30x12



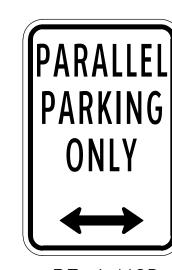

R7-1 MOD 12x18



R2 - 124X30

HOUSTON BIKEWAYS



R10 - 2212x18




R5 - 136×36



36×24



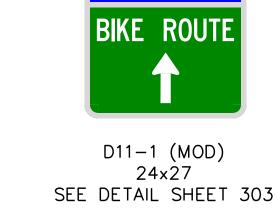





12×24



R7-2aR

R7-201a

12x24



R7-2aLR

R7-201a

12×24



R7-2aLC

R7-201a

12×24





R7-2aRC R7-201a 12×24

PROPOSED SIGNING & PAVEMENT MARKING LEGEND

	TYPE I - 4" BROKEN WHITE
2	TYPE I - 4" SOLID WHITE
3	TYPE I - 4" BROKEN YELLOW
4	TYPE I - 4" SOLID YELLOW
(5)	TYPE I - 6" SOLID WHITE

6) TYPE I - 6" GUIDE WHITE (7) TYPE I - 8" YIELD TRIANGLES WHITE

TYPE I - 12" SOLID WHITE TYPE I - 12" SOLID YELLOW TYPE I - 18" YIELD TRIANGLES WHITE

(11) TYPE I - 24" SOLID WHITE

TYPE I - 24" SOLID YELLOW (13) TYPE I - 36" YIELD TRIANGLES WHITE

(14) REFLECTIVE PM TY C PREFORM SOLID GREEN

(15) TYPE II - MEDIAN NOSE CURB YELLOW

(16) TYPE I - WHITE WORD, SYMBOL, ARROW, RR CROSSING OR SHARROW

(17) METHYL METHACRYLATE PAVEMENT MARKING

(18) EPOXY PAVEMENT MARKING

(19) RESIN BONDED AGGREGATE SURFACING

(20) REFL PAV MRKR - TYPE I-C (21) REFL PAV MRKR - TYPE II-A-A (22) REFL PAV MRKR - TYPE II-C-R

TRAFFIC BUTTON WHITE

TRAFFIC BUTTON WHITE (METRO BUTTONS)

TRAFFIC BUTTON YELLOW

TRAFFIC BUTTON YELLOW (METRO BUTTONS)

(27) RUBBER SPEED CUSHION

ASPHALT SPEED CUSHION - ASPHALT PAVEMENT

ASPHALT SPEED CUSHION - CONCRETE PAVEMENT

CHANNELIZATION DEVICE SEPARATORS

(31) FLEXIBLE POST DELINEATORS CYCLE LANE SEPARATOR "ARMADILLO"

(33) COLLAPSABLE BOLLARD

(34) CONCRETE PLANTER (35) CONCRETE WHEEL STOP (PAID FOR AS ITEM 178)

28" SHORT SQUEEZE 2.375" HIGH PERFORMANCE FLEXIBLE CHANNELIZER POST

GREEN TUFF CURB XLP

(38) REFLECTIVE PM TY C PREFAB SYMBOL (WHITE/GREEN)

(39) OMITTED

(40) OMITTED

(41) TYPE I - 6" SOLID YELLOW

TYPE I - 6" GUIDE YELLOW

TRUNCATED DOME

DIRECTIONAL TACTILE MARKING

(45) PEDESTRIAN RAILING

PROPOSED RAISED MARKERS

PROPOSED BUTTONS

--- PROPOSED PAVEMENT MARKINGS

EXISTING SIGN (TO REMAIN)


▼ EXISTING SIGN (TO BE REMOVED)

PROPOSED SIGN

--- PROPOSED CURB AND PAVEMENT REPAIR

— PROPOSED CURB AND CONCRETE


— PROPOSED REMOVAL

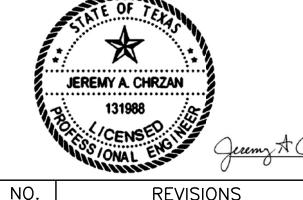

NO.	REVISIONS	DATE	NAME

TOOLE DESIGN

8484 Georgia Avenue, Suite 800, Silver Spring, MD 20910 TEL (301) 927-1900 TBPE Registration No. 14667

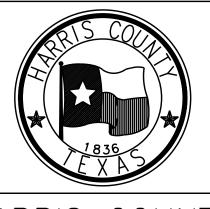


HARRIS COUNTY

ENGINEERING DEPARTMENT

PROJECT TITLE:						
	HUTCHINS/CLEBURNE STREETS ON-STREET BIKEWAY					
	SHEET DESCRIPTION:					
CB/FL	SIGNING AND PAVEMENT	MARKING				
CK'D BY:						
JC	LEGEND					
SCALE:	SHEET 1 OF 1					
NTS						
DATE:	APPROVED BY:					
04/12/19						
		SHEET NO:				



R1-5L (COH MOD) 36×36 SEE DETAIL SHEET 314

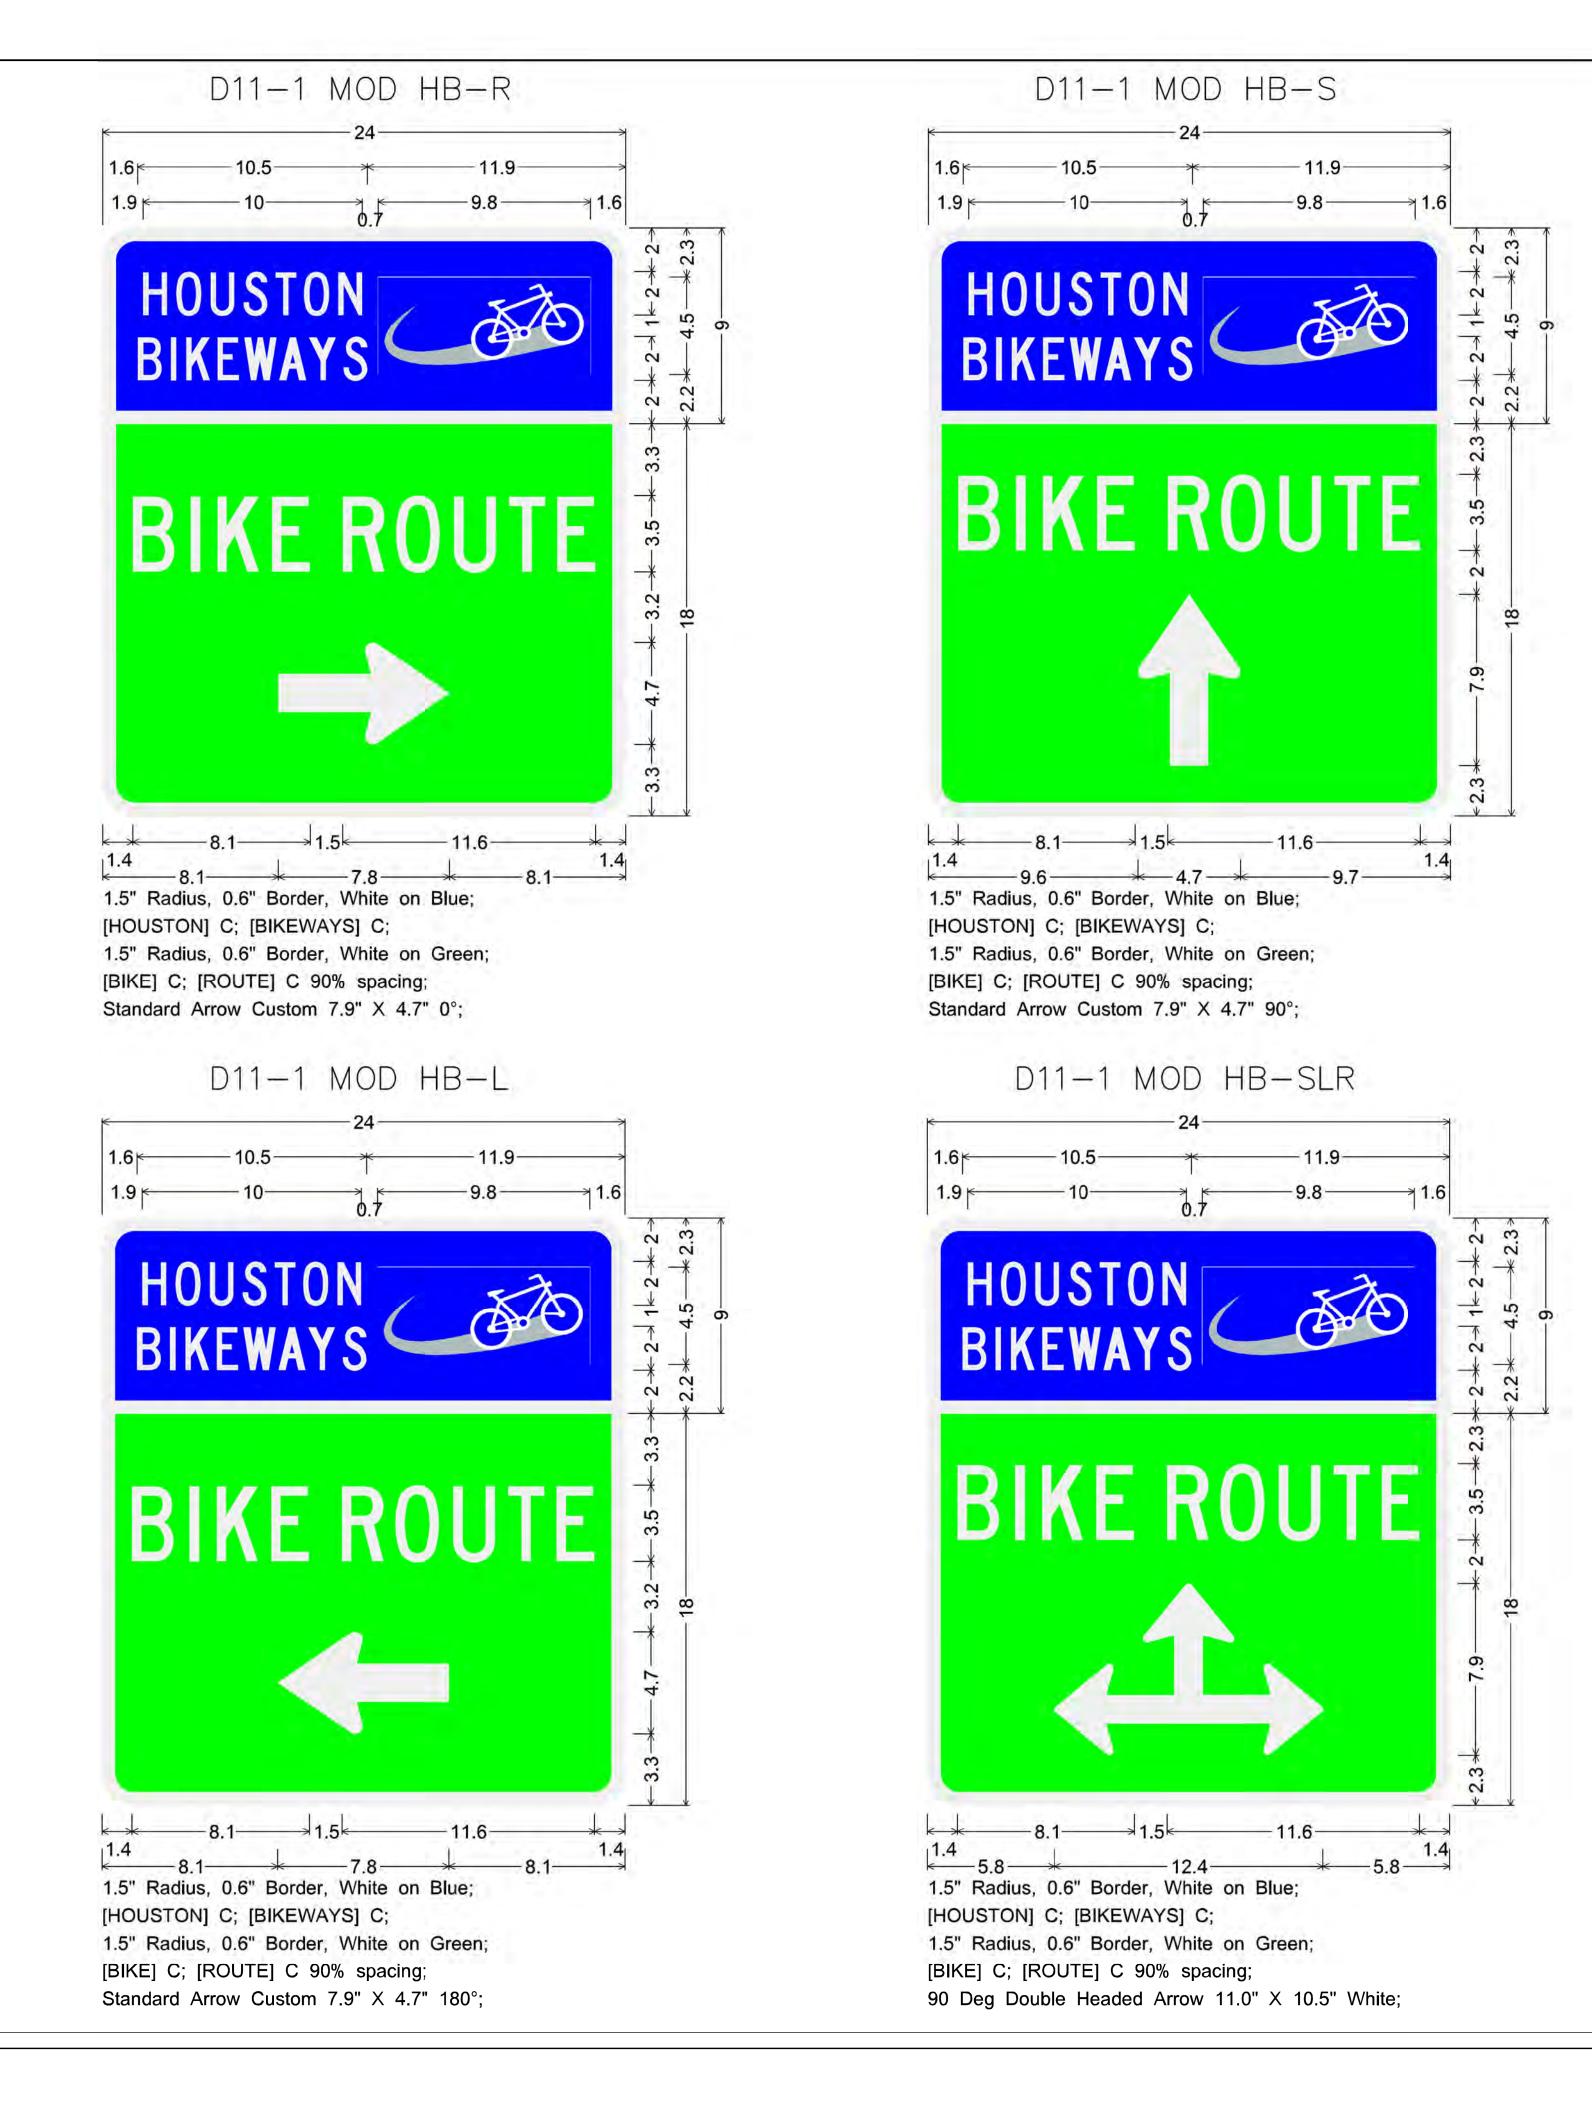






[BIKE] C; [ROUTE] C 90% spacing;


90 Deg Double Headed Arrow 11.0" X 10.5" White;

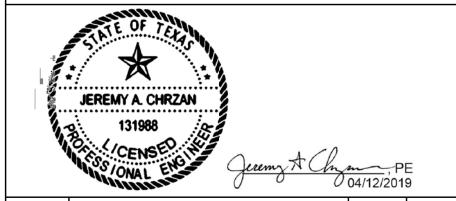

	NO.	REVISIONS	DATE	NAME

1'OOLE DESIGN

8484 Georgia Avenue, Suite 800, Silver Spring, MD 20910
TEL (301) 927-1900
TBPE Registration No. 14667

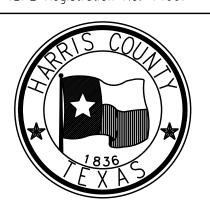

HARRIS COUNTY


ENGINEERING DEPARTMENT


PROJECT TITLE:
HUTCHINS/CLEBURNE STREETS ON-STREET BIKEWAY
DRAWN BY: SHEET DESCRIPTION:
CB/FL HOUSTON BIKEWAYS SIGN DETAILS
CK'D BY:
JC
SCALE:
NTS SHEET 1 OF 1

DATE:
04/12/19
SHEET NO:
303


DATE: 12-Apr-2019 04: 37 P₩: 37: 23 PM FILE: \\dca-file01\\50000\\5653.06_S_Th

TYPICAL CROSSWALK DETAILS

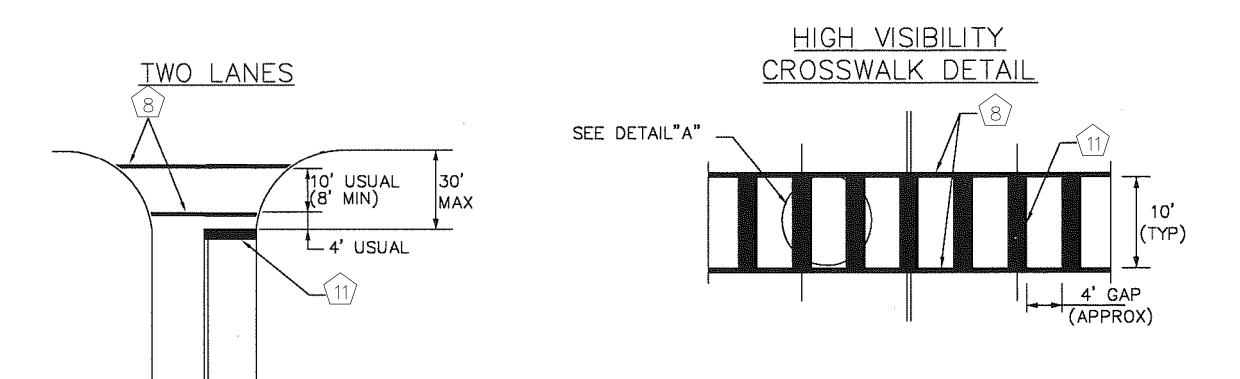


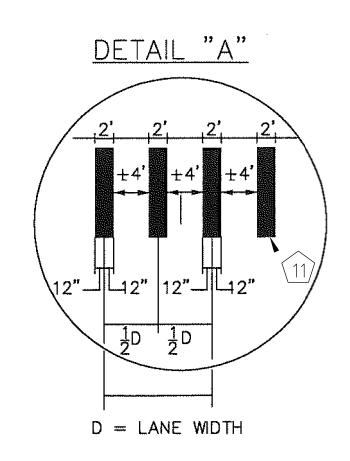

STANDARD PAVEMENT MARKINGS

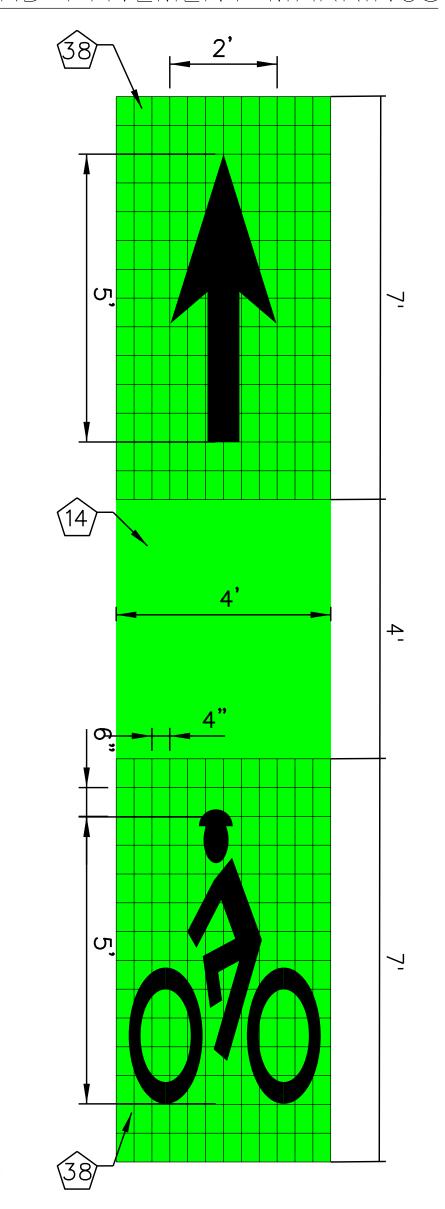


* 6'x3'4" * 4'x 2'

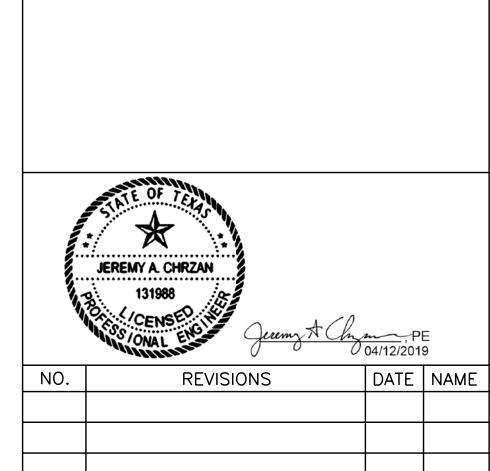

100LE DESIGN


8484 Georgia Avenue, Suite 800, Silver Spring, MD 20910 TEL (301) 927-1900 TBPE Registration No. 14667

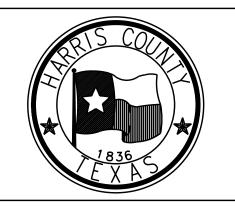


HARRIS COUNTY ENGINEERING DEPARTMENT


PROJECT TITLE:					
HUTCHINS/CLEBURNE STREETS ON-STREET BIKEWAY					
DRAWN BY:	SHEET DESCRIPTION:				
CB/FL	PAVEMENT MARKING [DETAILS			
CK'D BY:					
JC					
SCALE:	CHEET 1 OF 4				
NTS	SHEET 1 OF 4				
DATE:	APPROVED BY:				
04/12/19					
		SHEET NO:			
		304			


TYPICAL CONFLICT MARKINGS

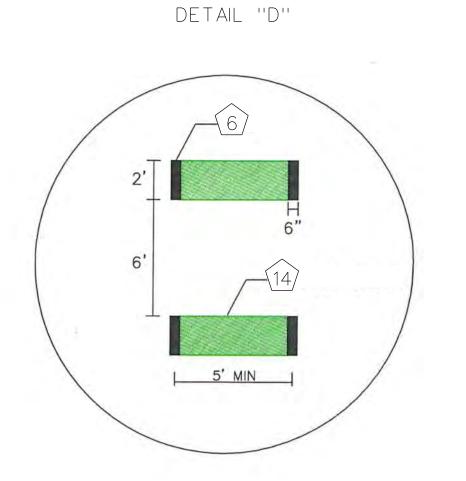


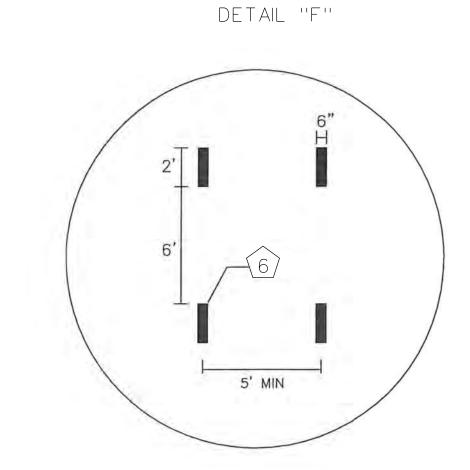


ARMADILLO BARRIERS

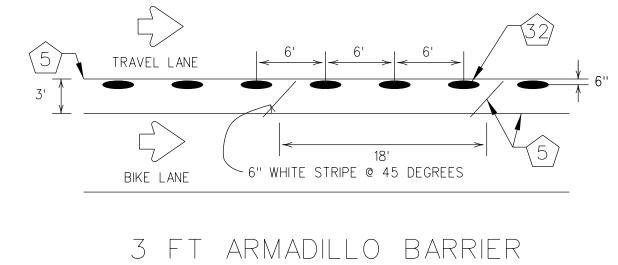


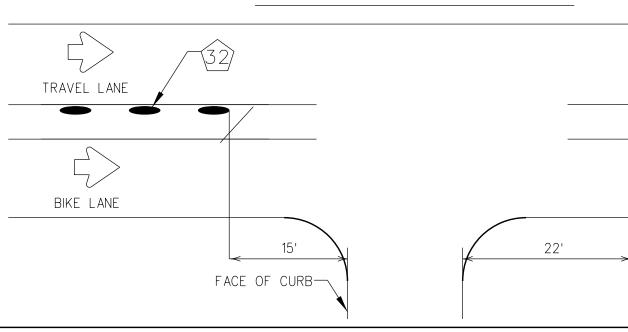


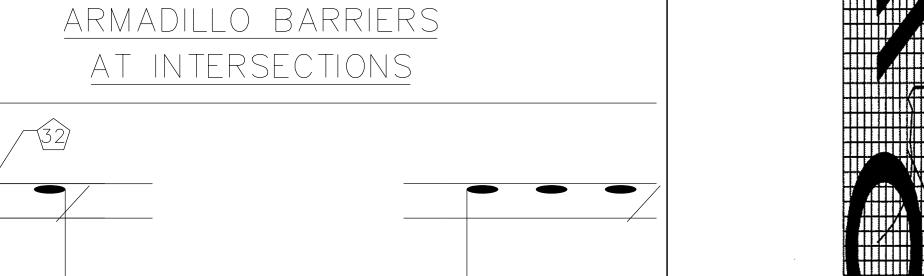

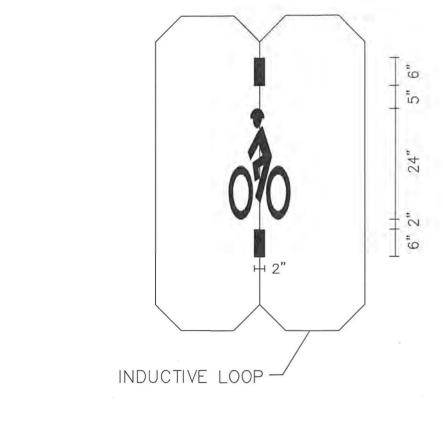



BICYCLE DETECTION MARKING

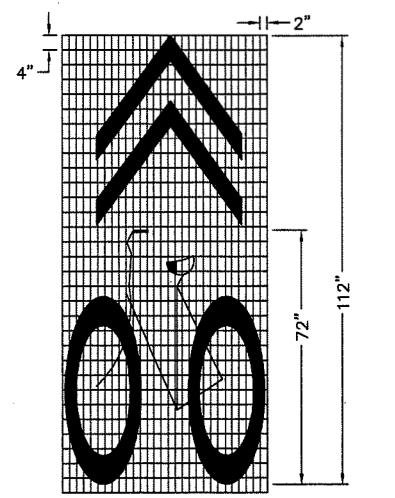

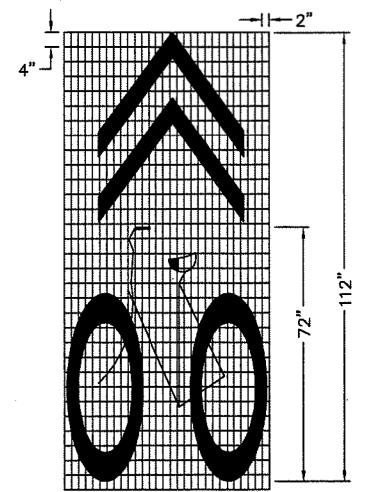



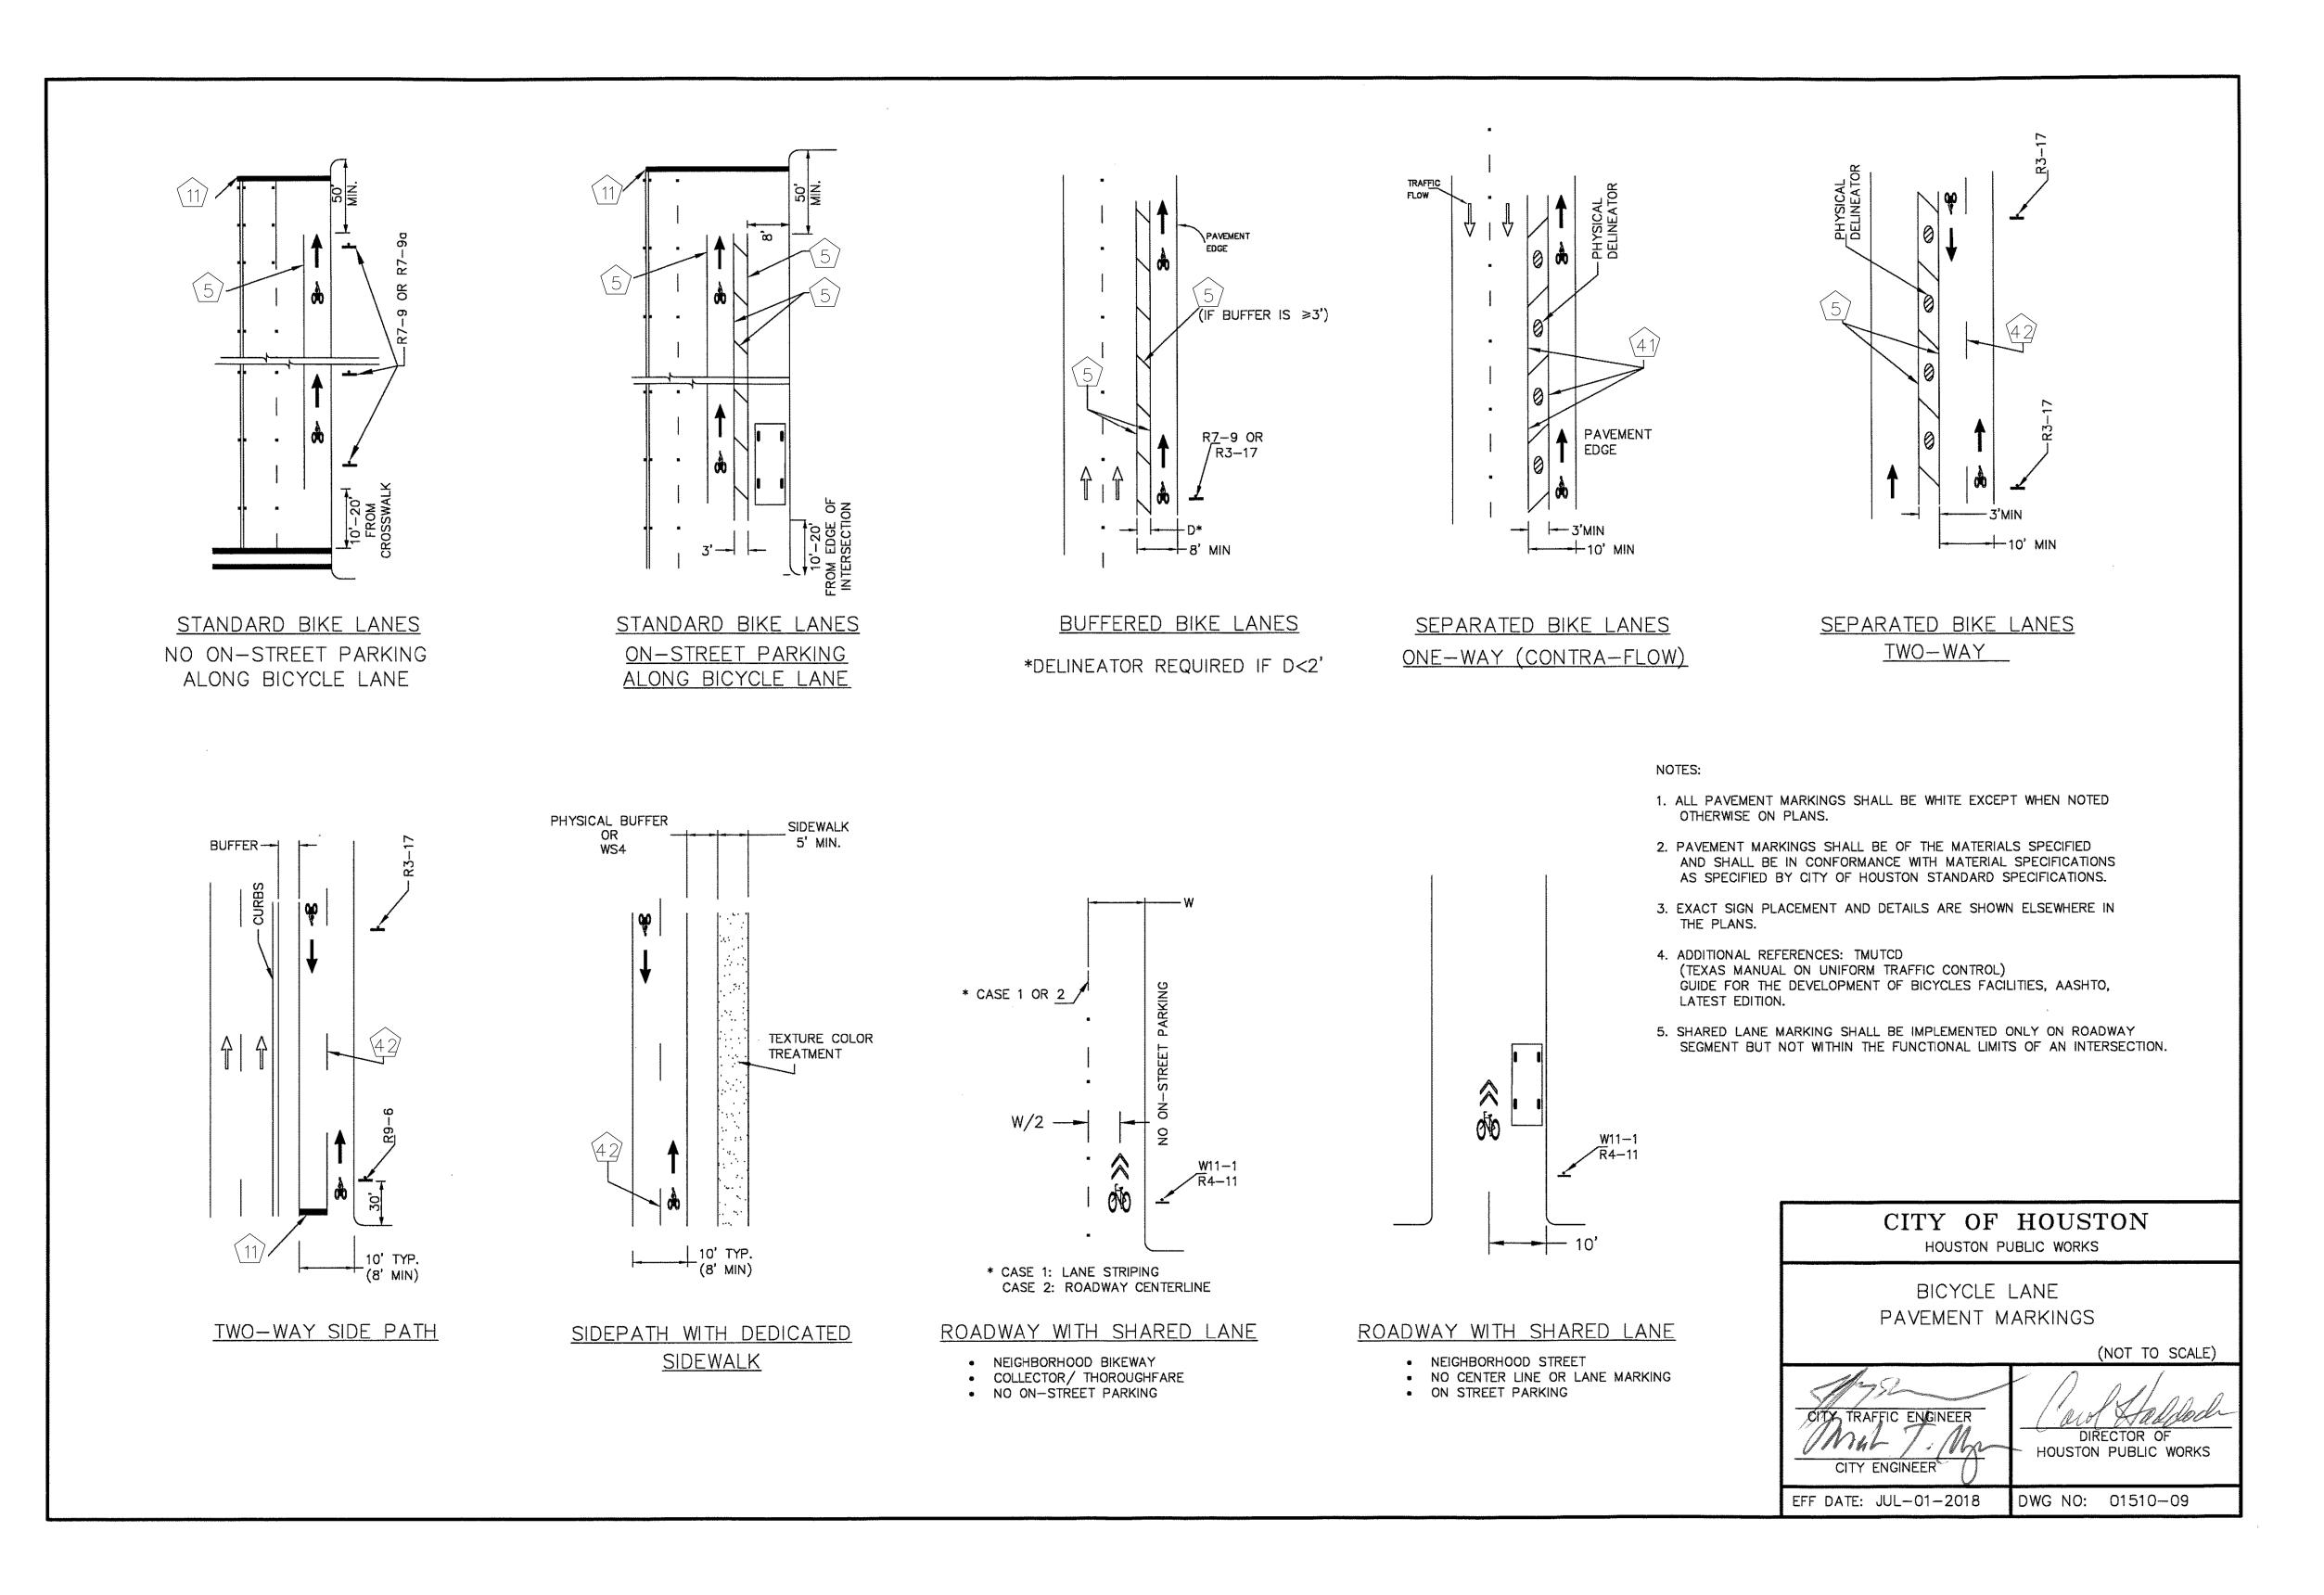


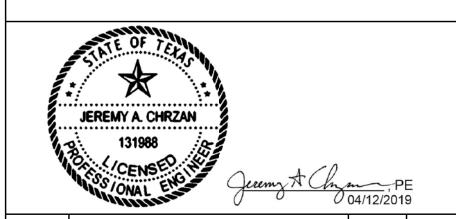

NO.	REVISIONS	DATE	NAME

TOOLE DESIGN


8484 Georgia Avenue, Suite 800, Silver Spring, MD 20910 TEL (301) 927-1900 TBPE Registration No. 14667

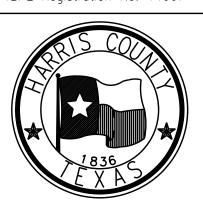



HARRIS COUNTY


ENGINEERING DEPARTMENT

	CLEBURNE STREETS ON—STR	EET BIK	ŒWAY
DRAWN BY:	SHEET DESCRIPTION:		
CB/FL	PAVEMENT MARKING [DETAILS	
CK'D BY: JC			
SCALE: NTS	SHEET 2 OF 4		
DATE:	APPROVED BY:		
04/12/19			
		SHEET	NO:

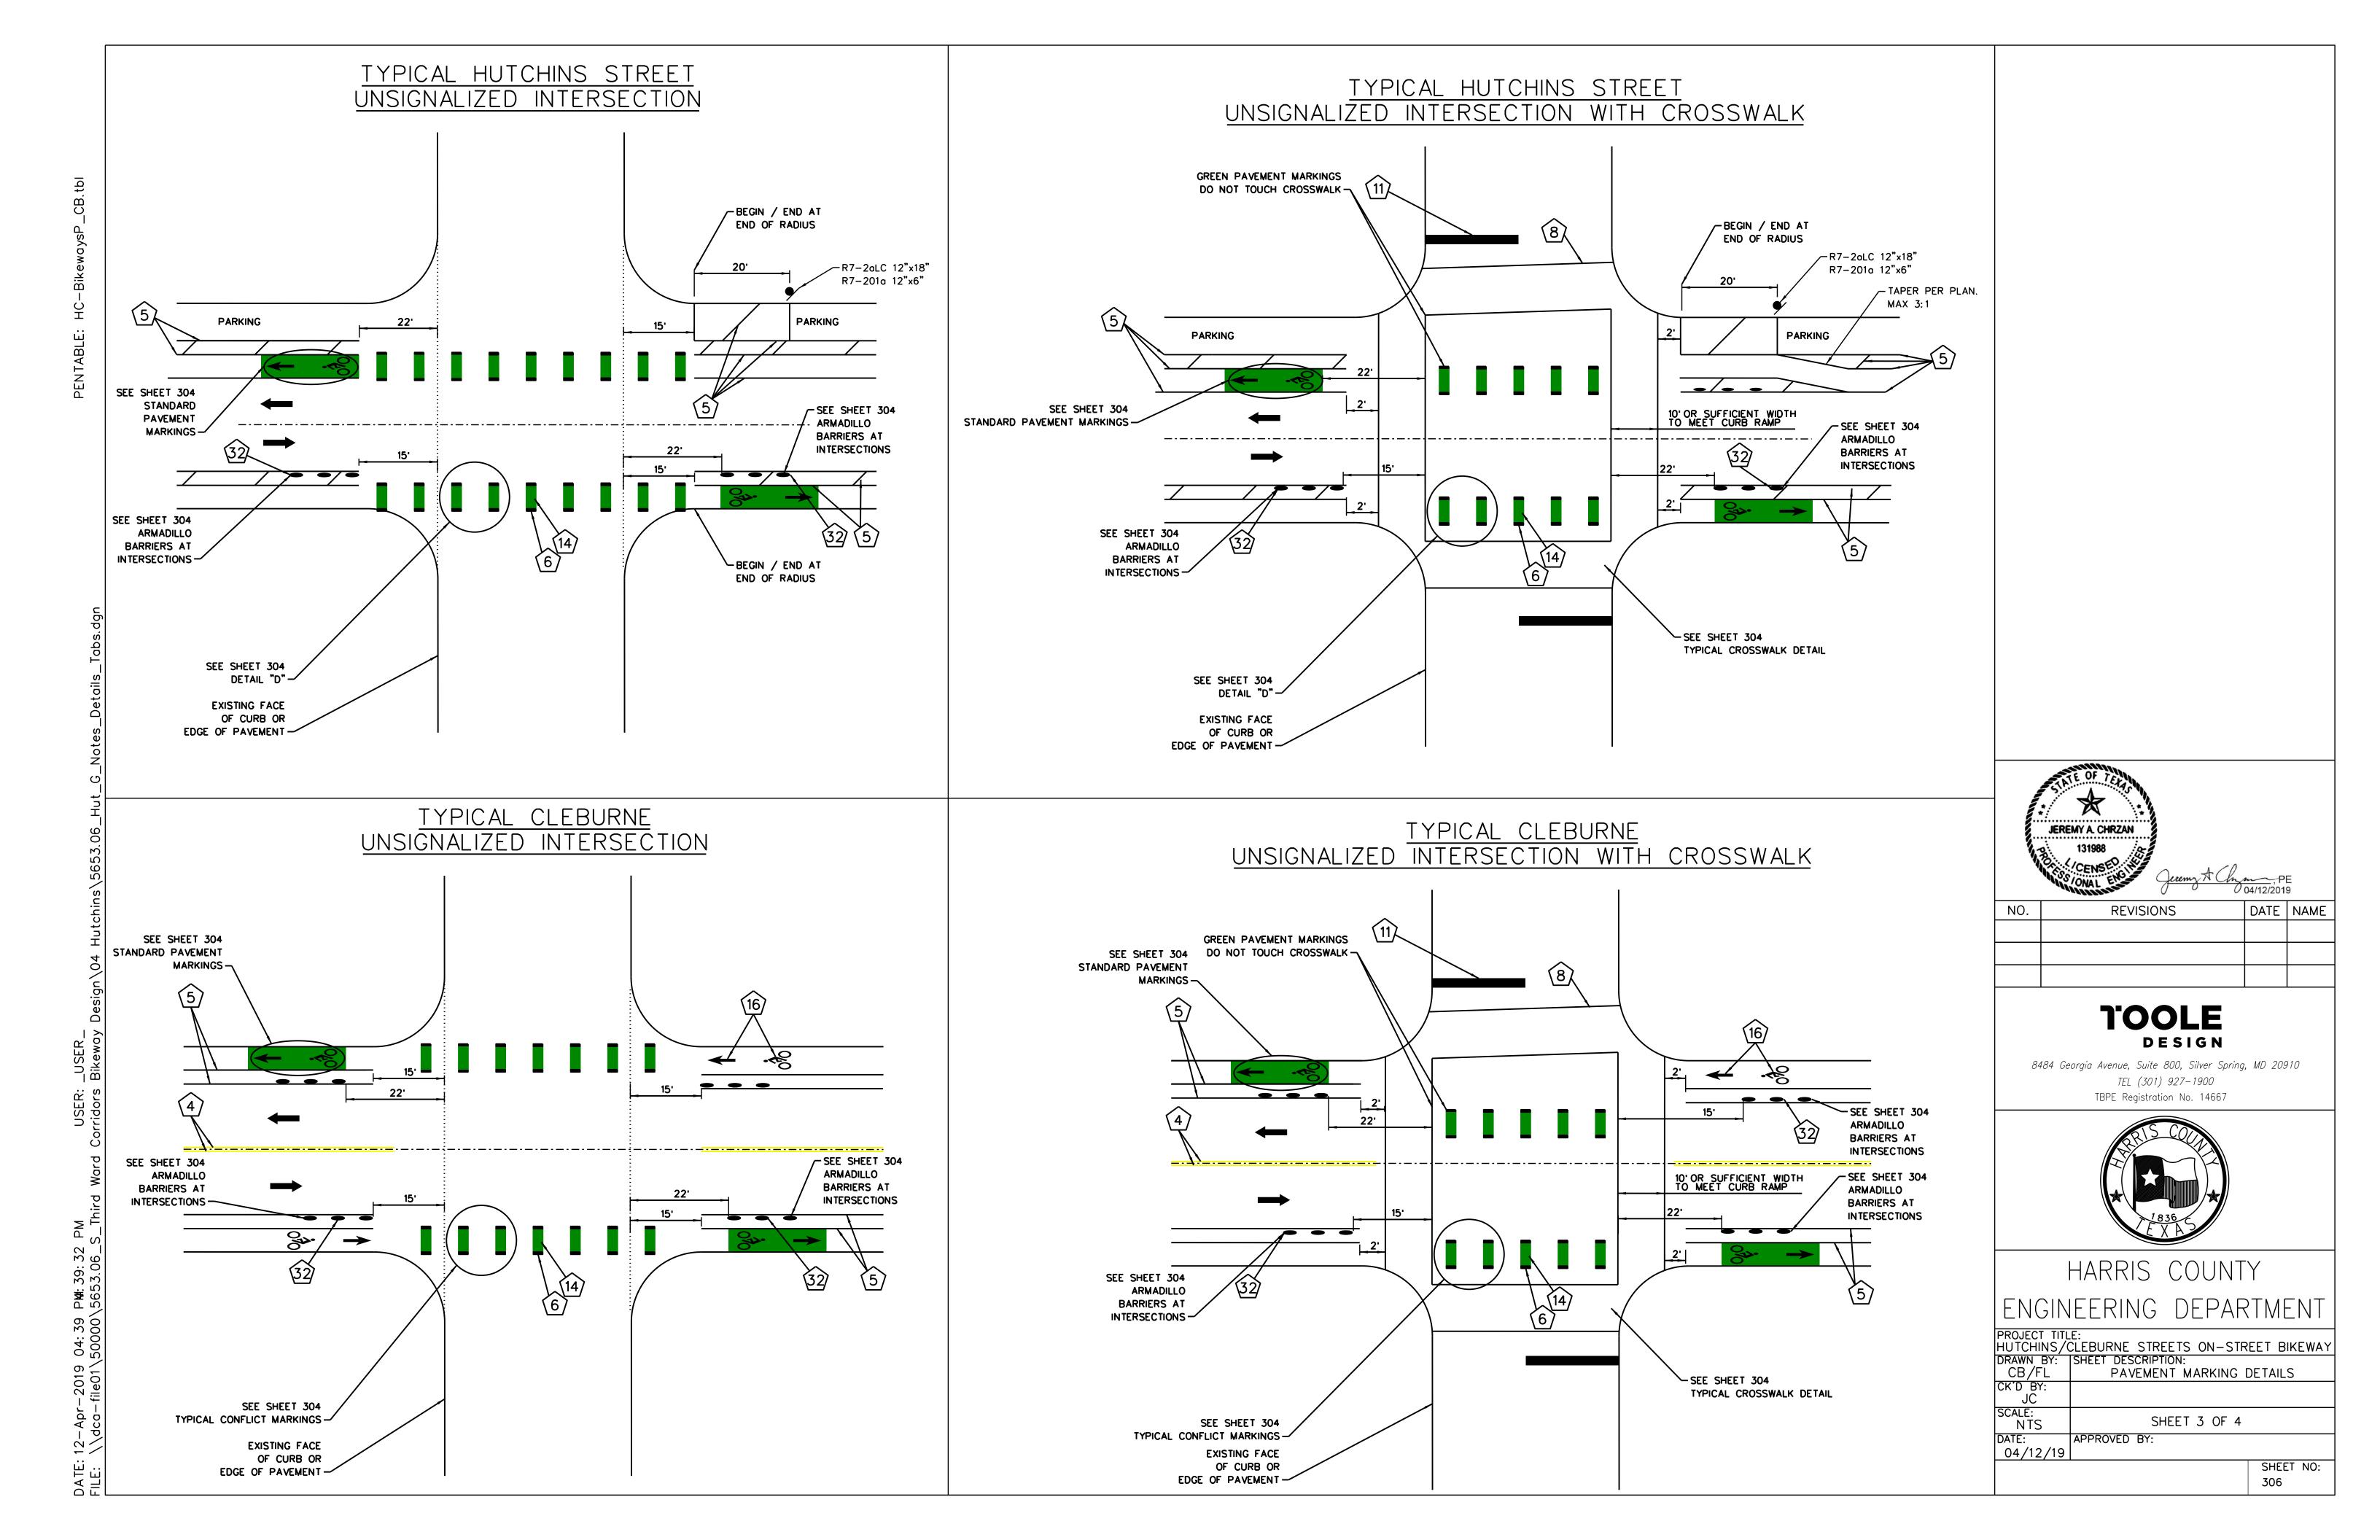

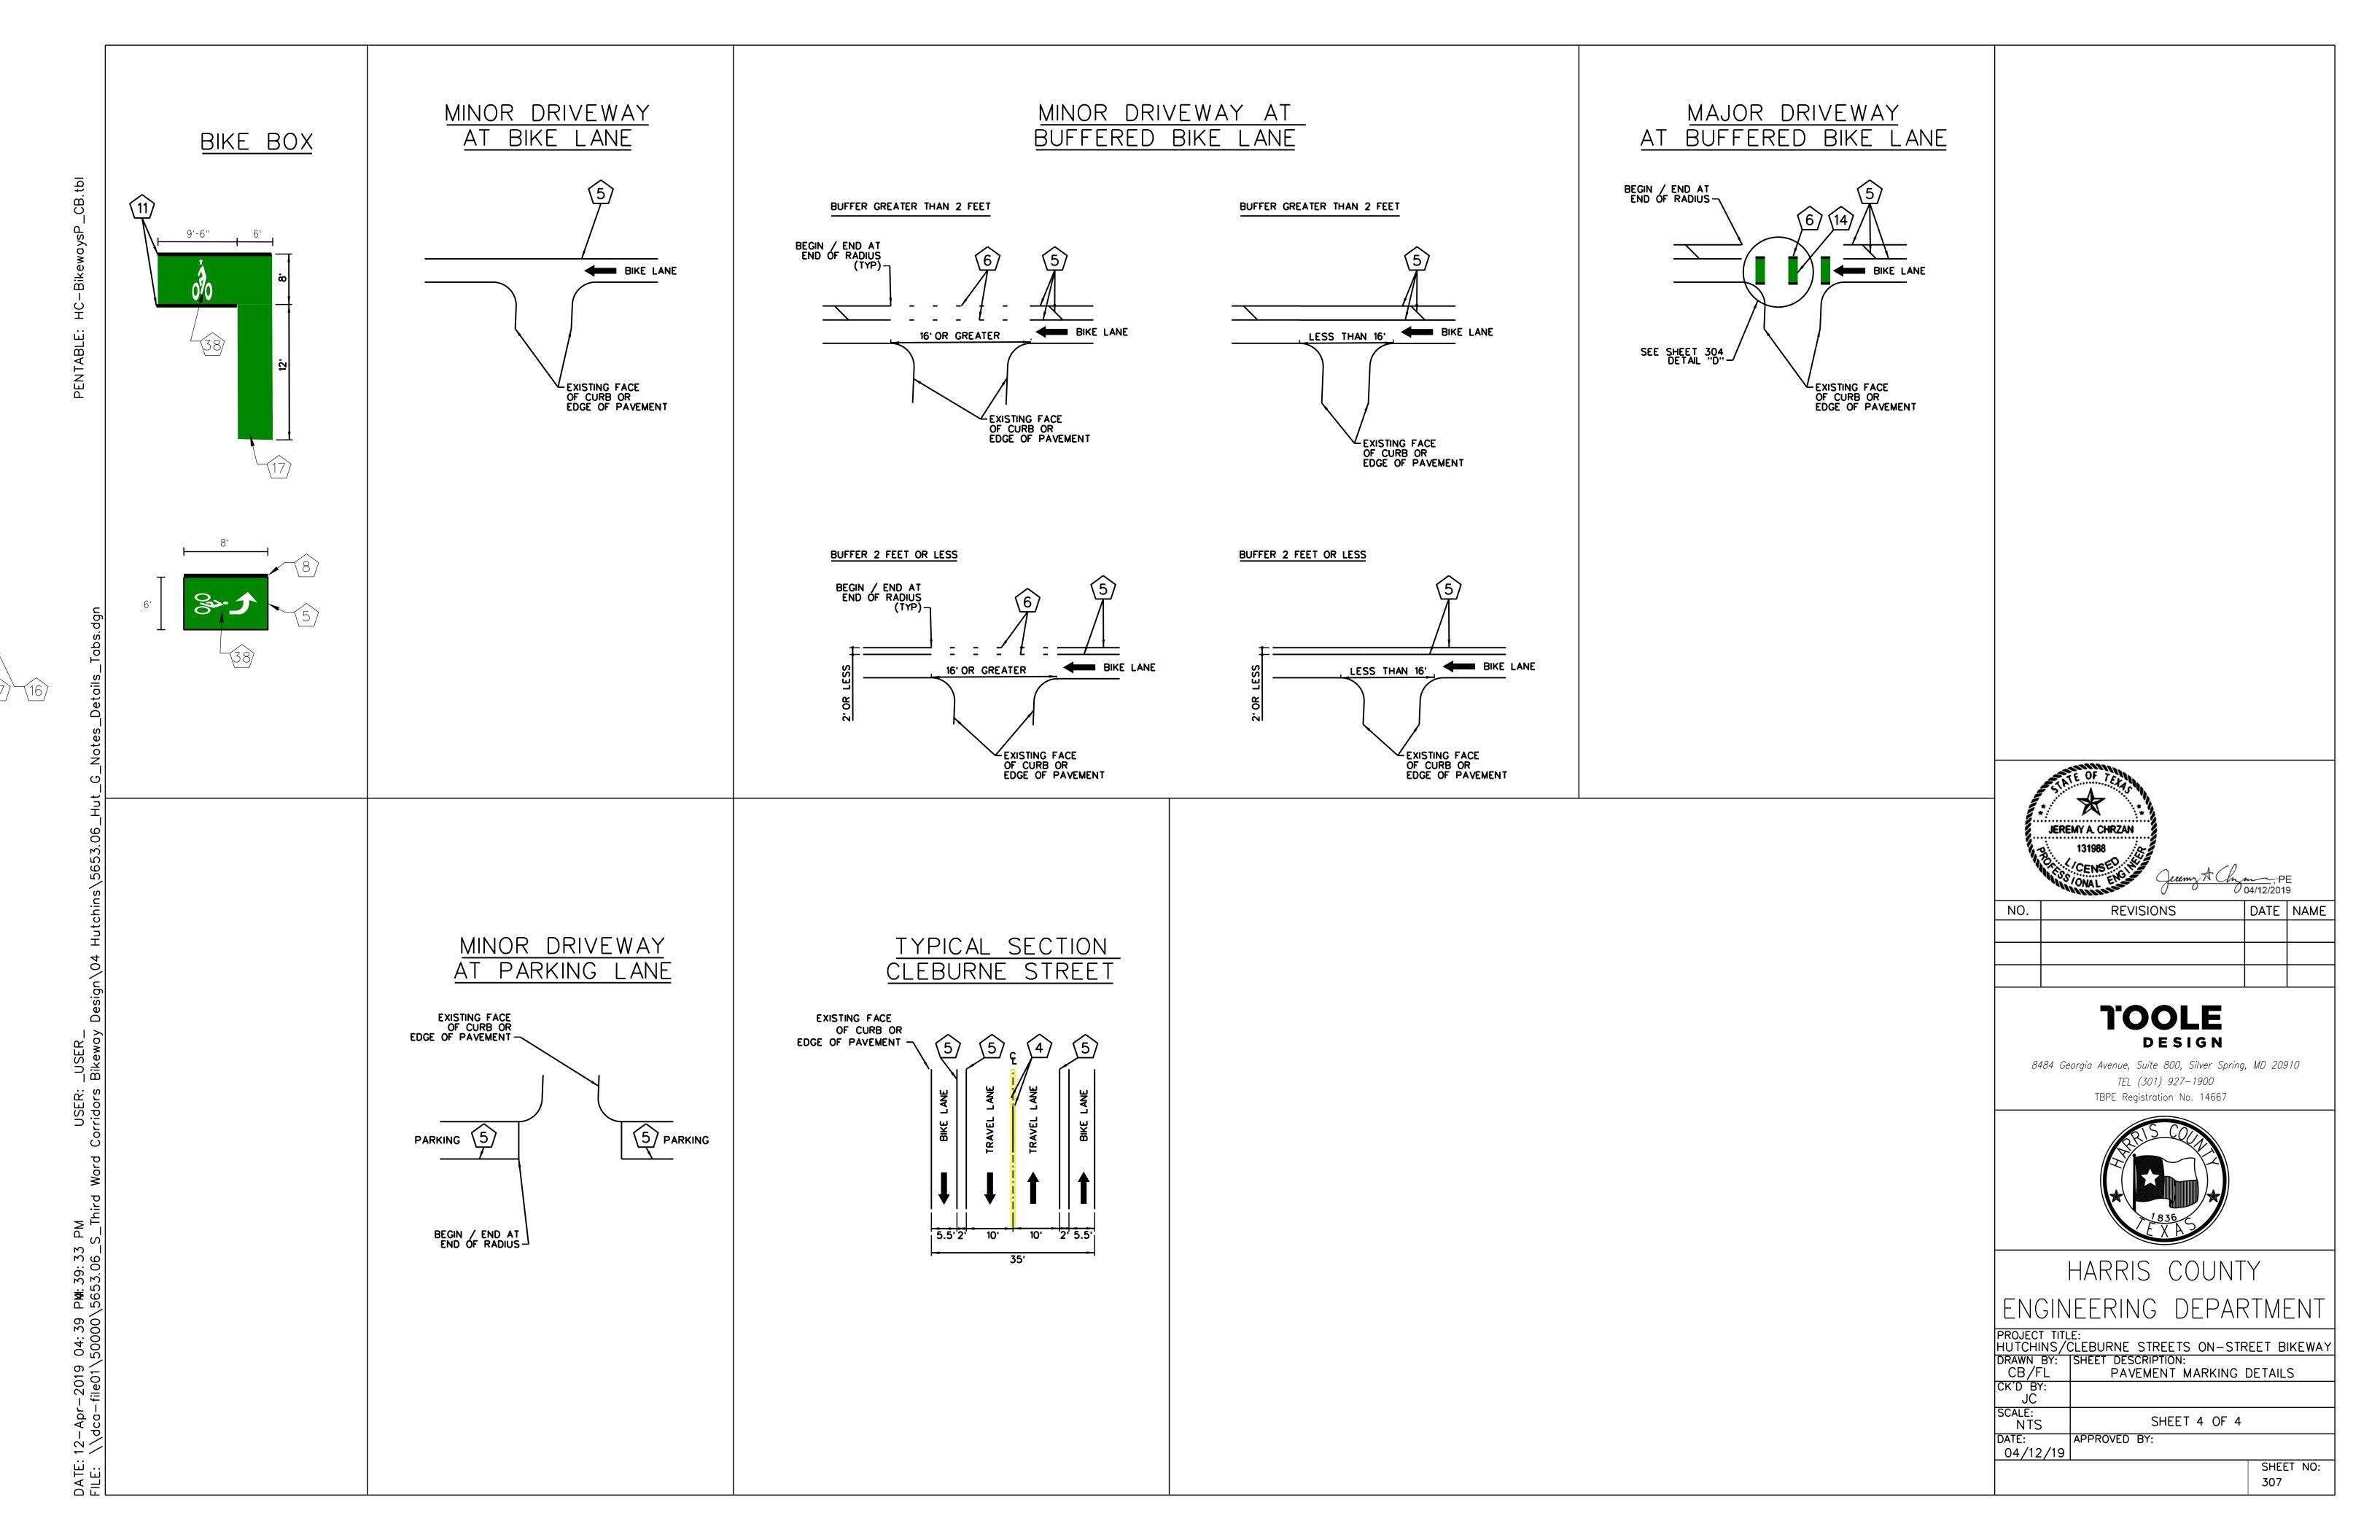

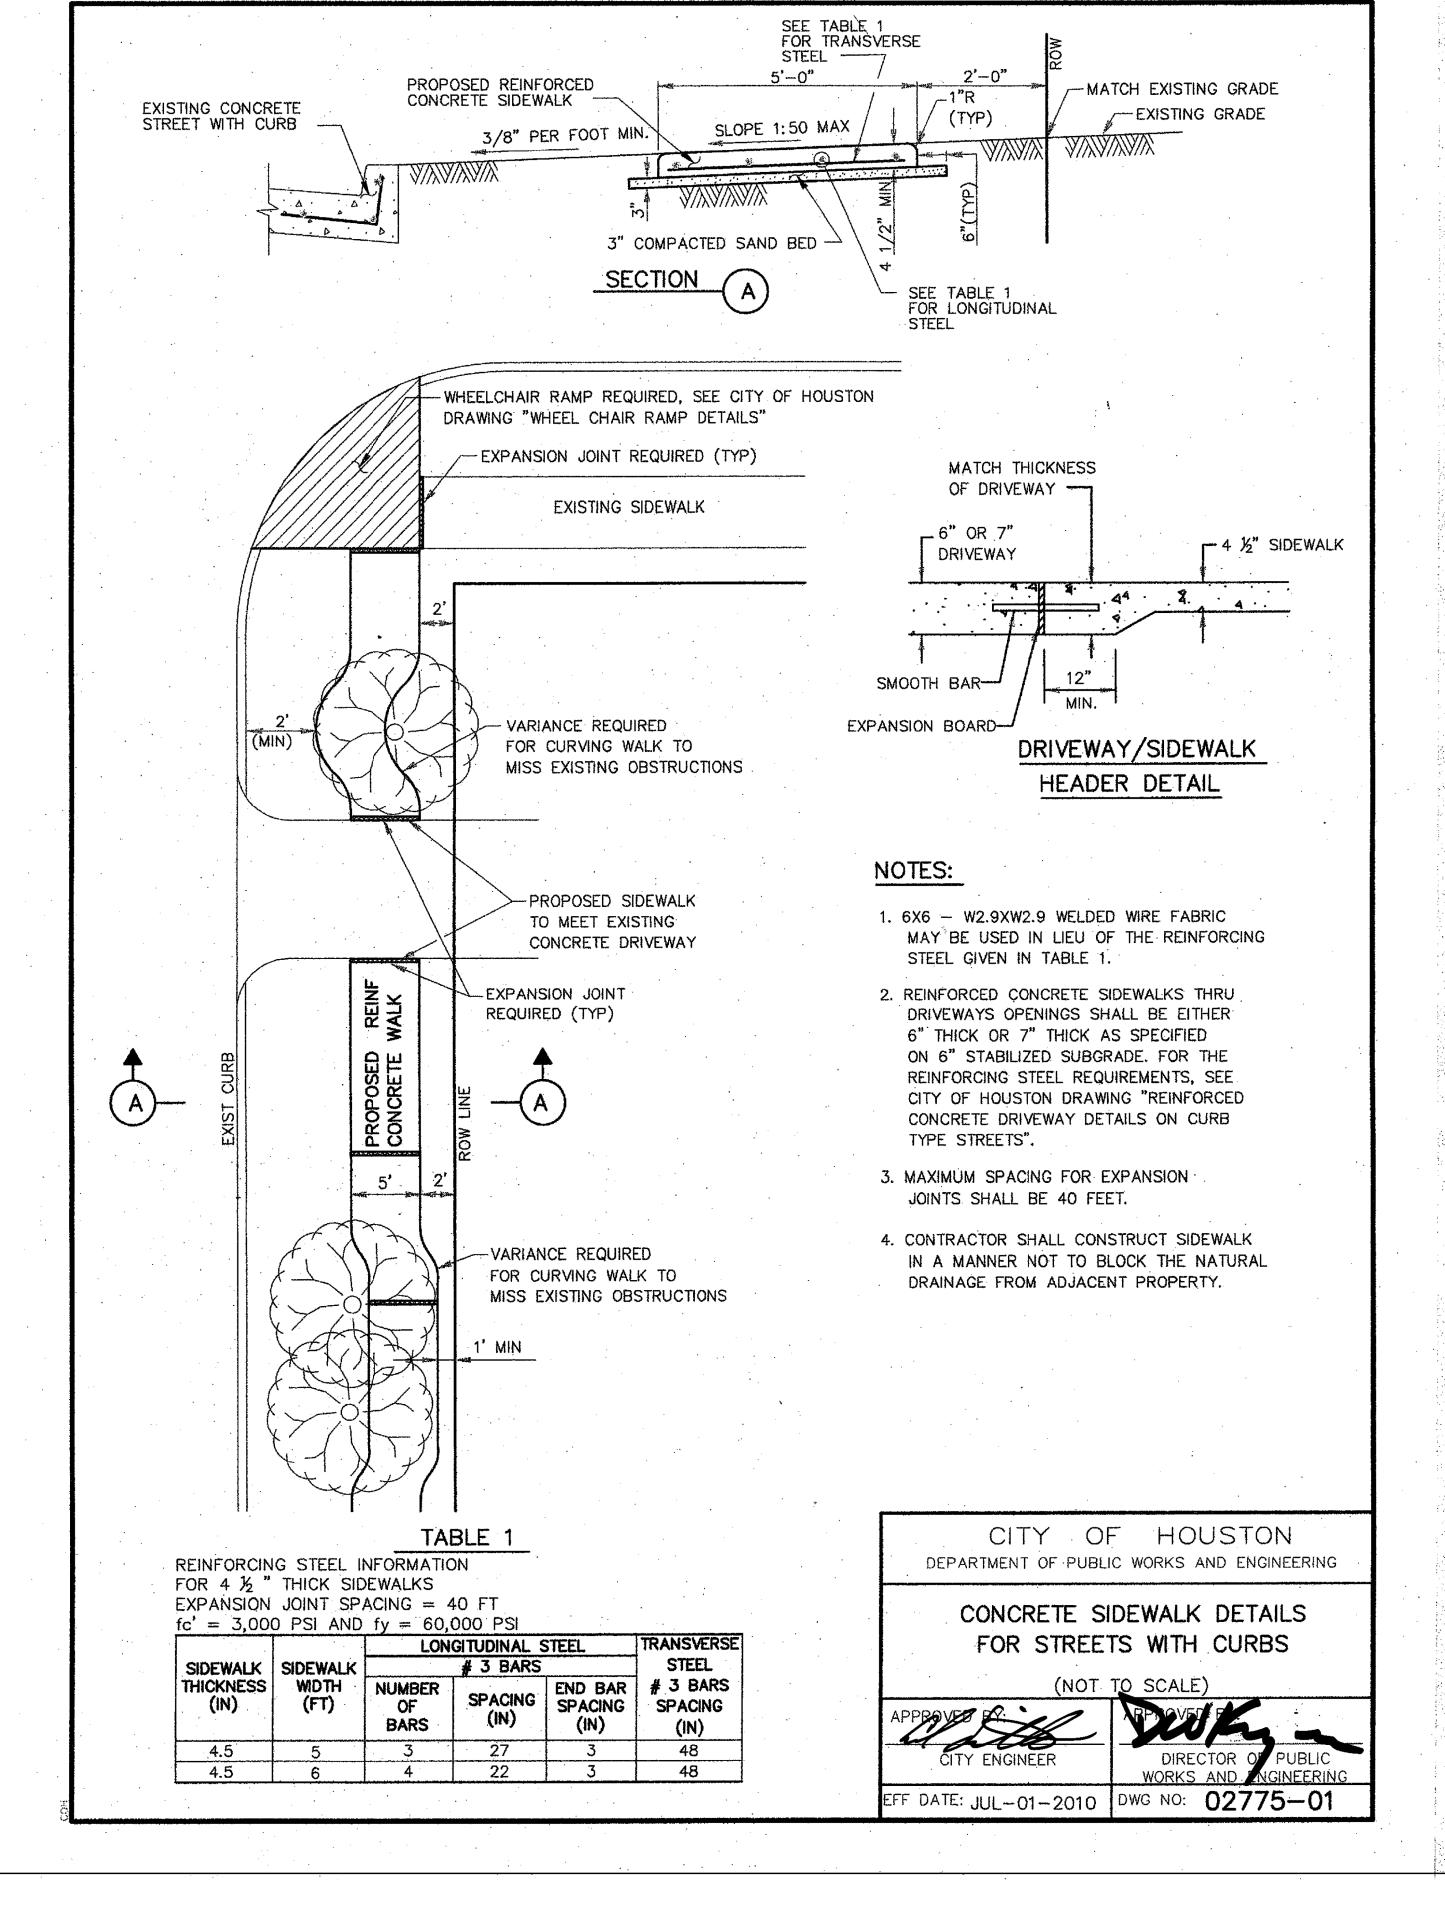


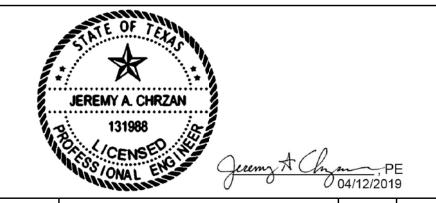

NO.	REVISIONS	DATE	NAME

100LE DESIGN

8484 Georgia Avenue, Suite 800, Silver Spring, MD 20910
TEL (301) 927-1900
TBPE Registration No. 14667

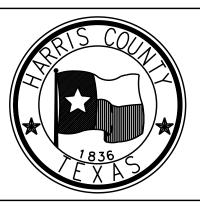


HARRIS COUNTY ENGINEERING DEPARTMENT


PROJECT TITLE:
HUTCHINS/CLEBURNE STREETS ON-STREET BIKEWAY
DRAWN BY: SHEET DESCRIPTION:
CB/FL CONCRETE SIDEWALK DETAILS


CB/FL CONCRETE SIDEWALK DETAILS
CK'D BY:
 JC
SCALE:
 NTS SHEET 1 OF 1

DATE: APPROVED BY: 04/12/19

SHEET NO: 308

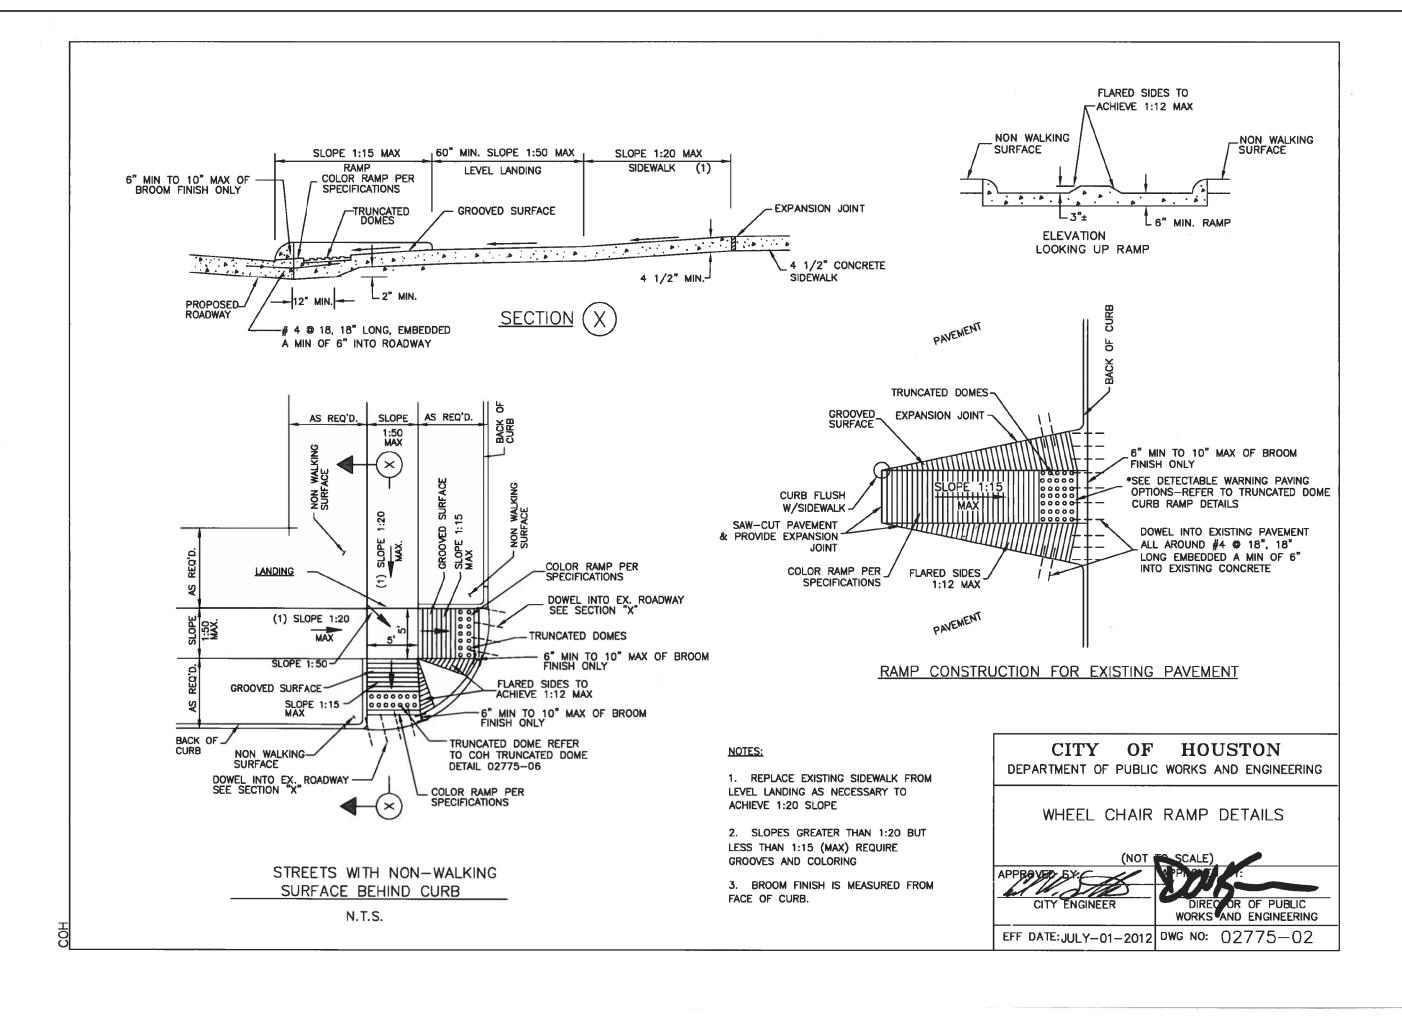

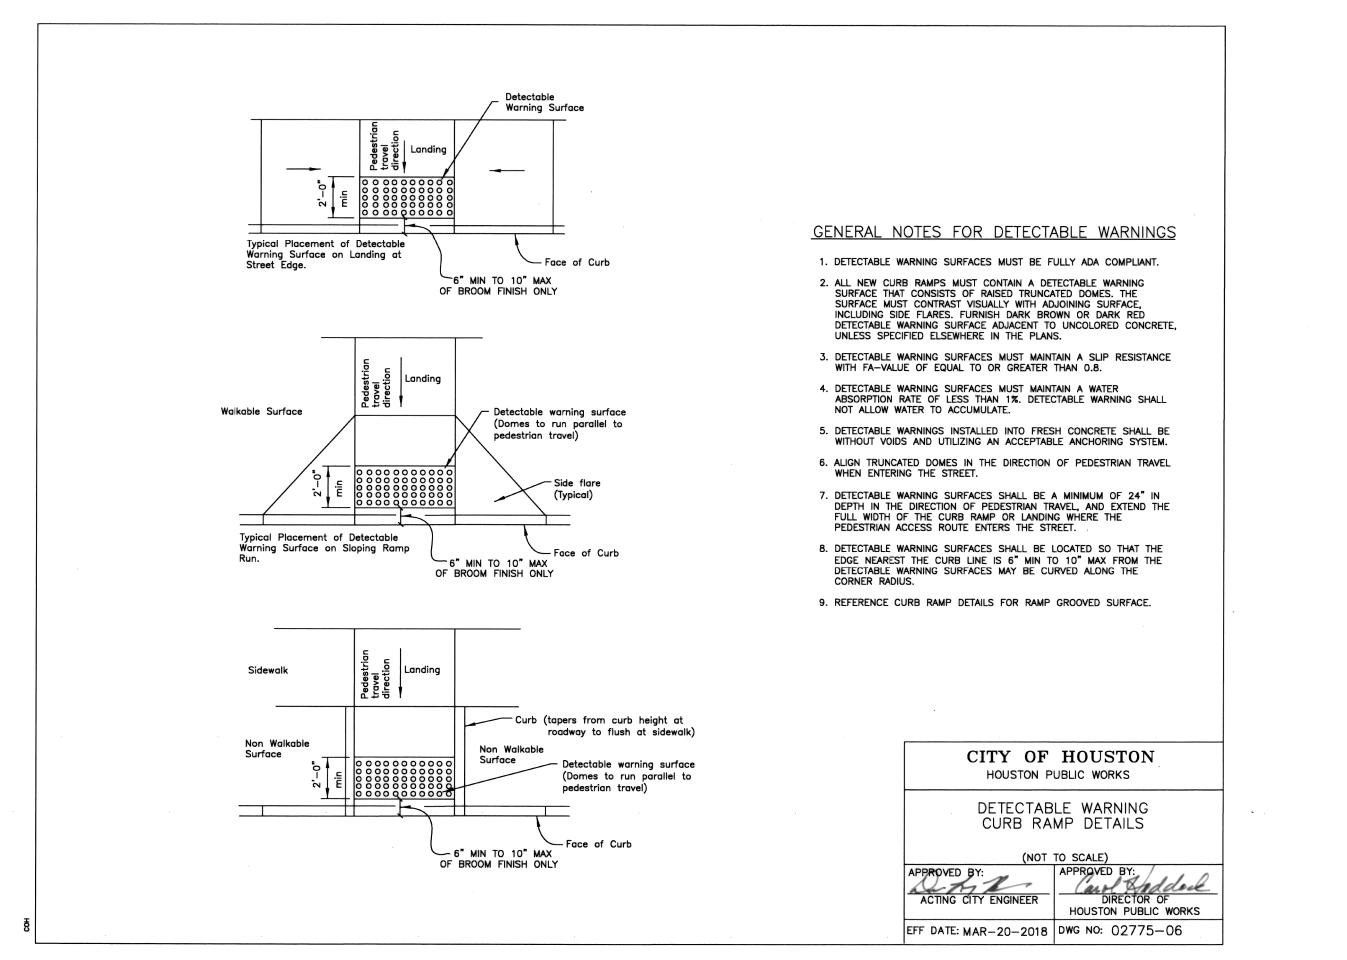


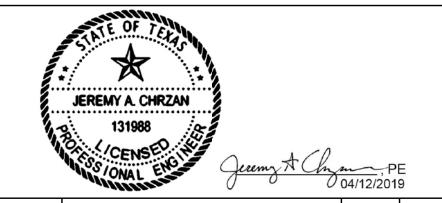

NO.	REVISIONS	DATE	NAME

TOOLE DESIGN


8484 Georgia Avenue, Suite 800, Silver Spring, MD 20910 TEL (301) 927-1900 TBPE Registration No. 14667

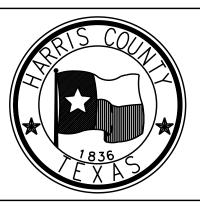

ENGINEERING DEPARTMENT


HARRIS COUNTY

PROJECT TITL		
HUTCHINS/0	CLEBURNE STREETS ON-STR	EET BIKEWA'
	SHEET DESCRIPTION:	
CB/FL	CURB RAMP DETA	\ILS
CK'D BY:		
JC		
SCALE:	SHEET 1 OF 1	
NTS		
DATE:	APPROVED BY:	
04/12/19		
		SHEET NO:
		309

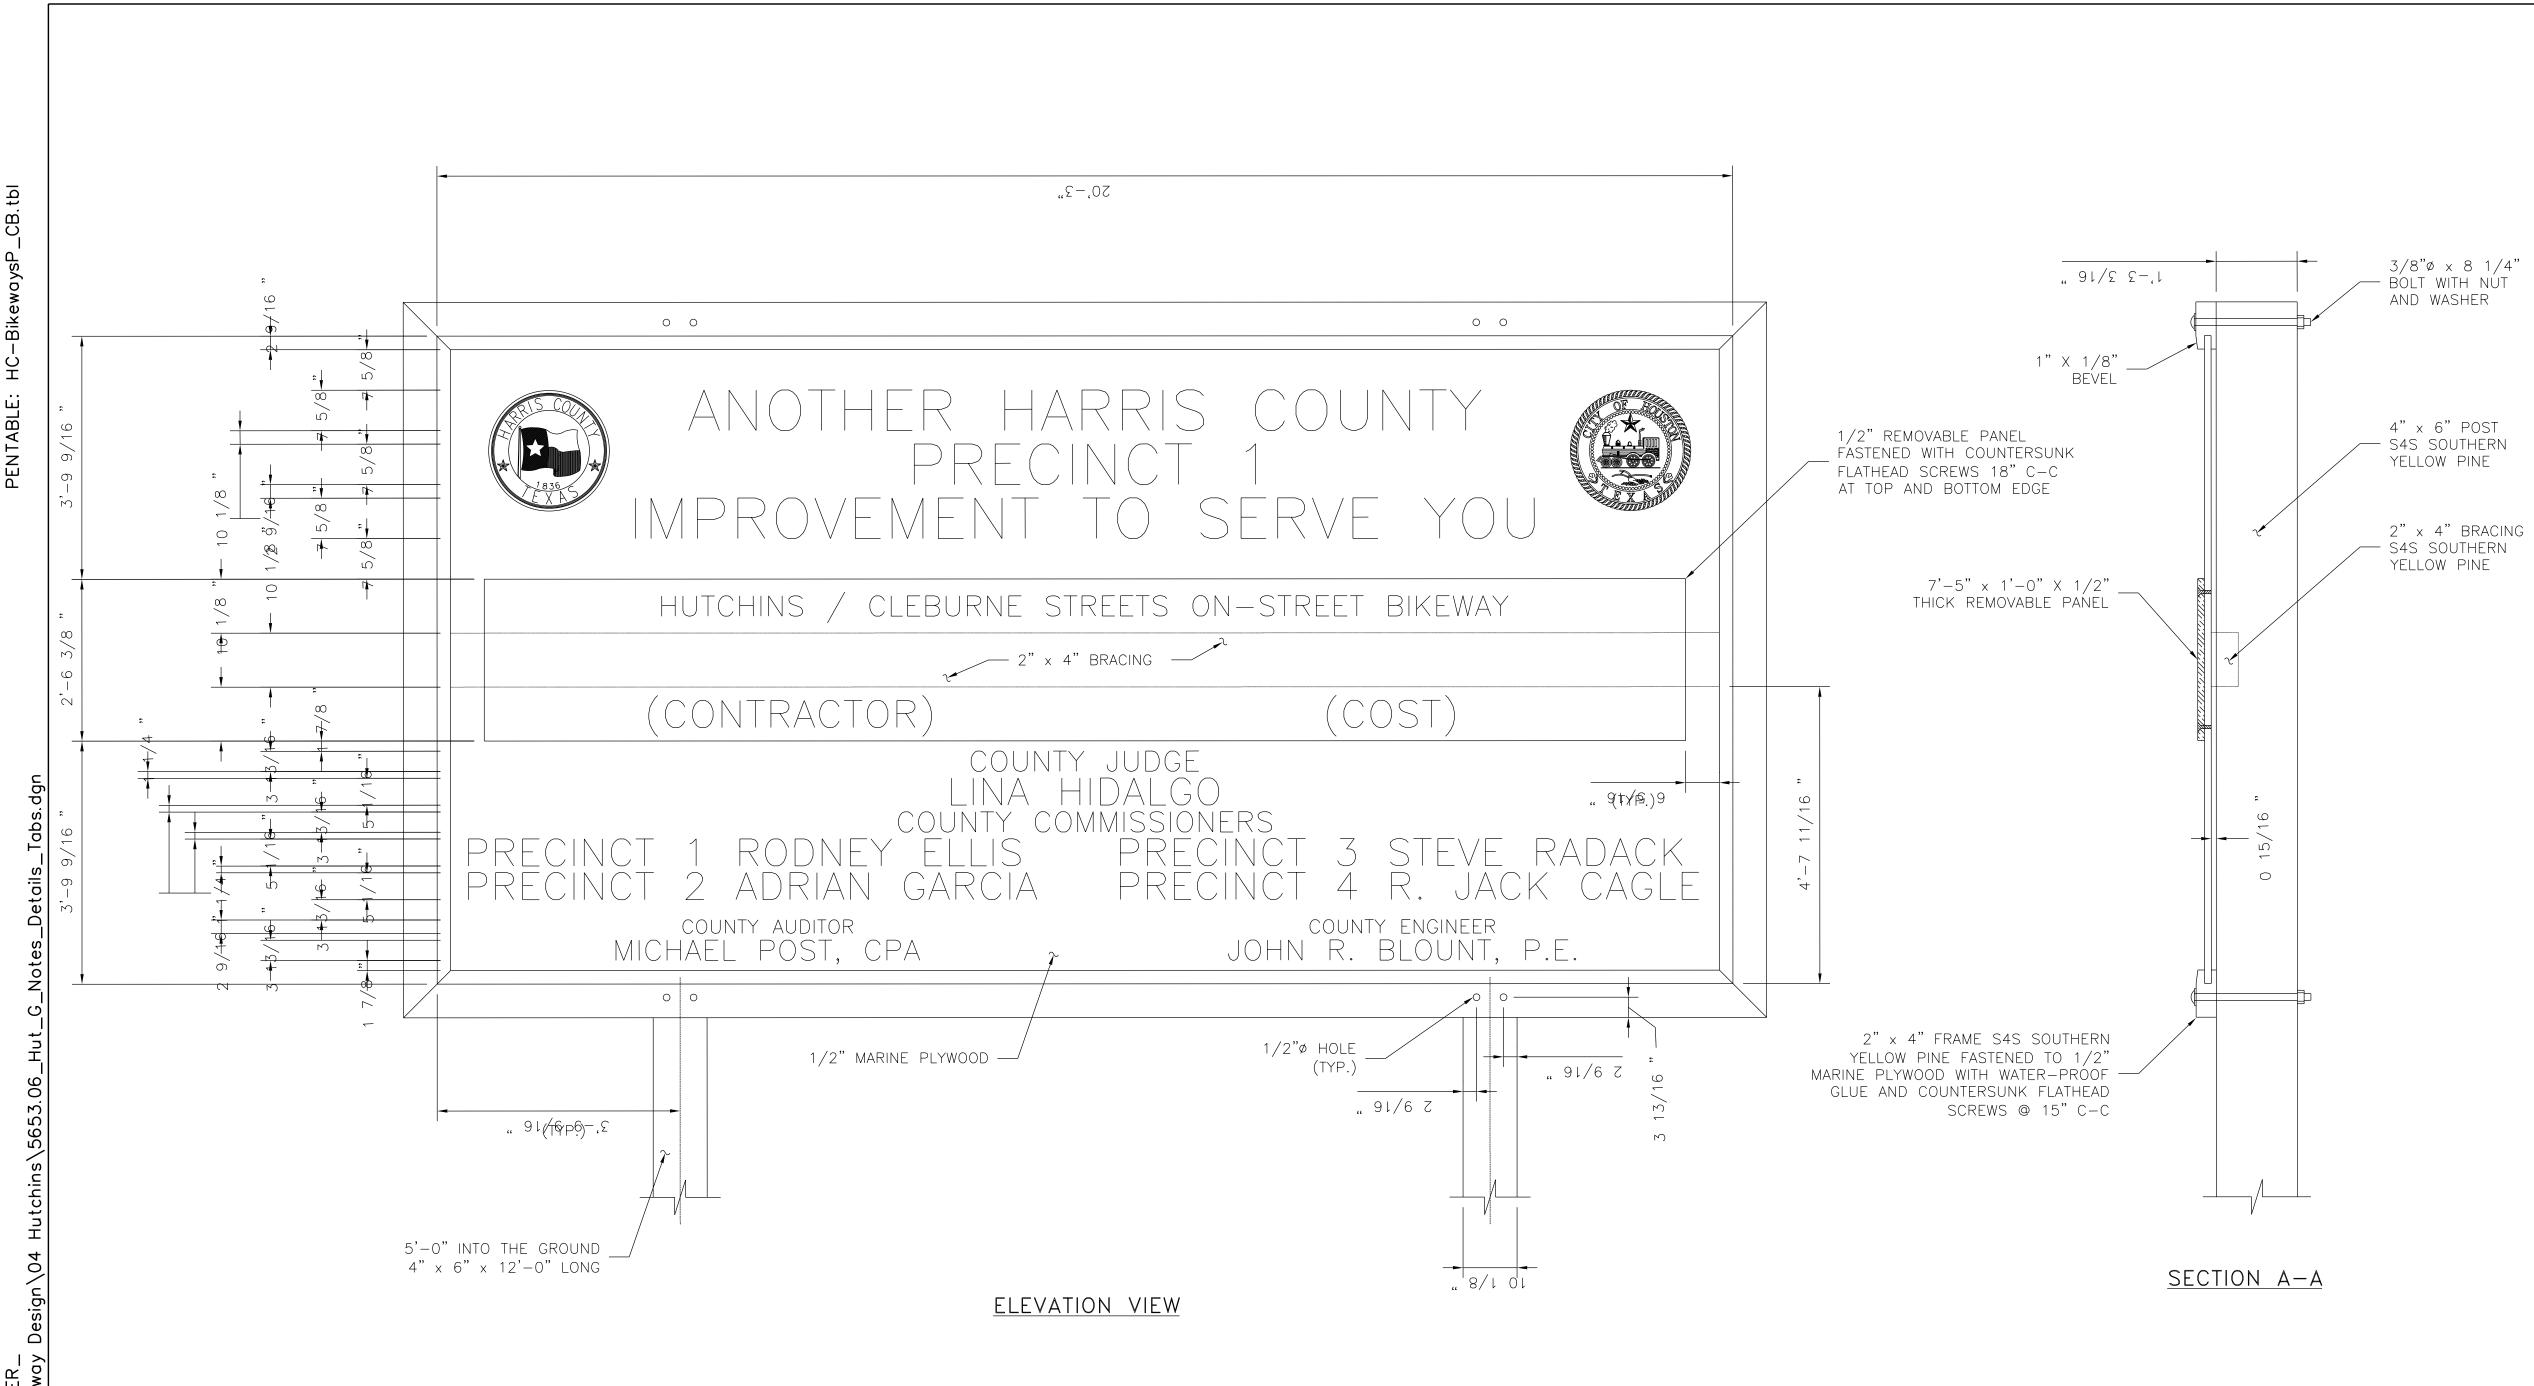

GENERAL NOTES:


- 1. THE SIGN SHALL HAVE BLACK LETTERS WITH WHITE BACKGROUND. 2. SIGN SHALL BE MOUNTED ON 4" x 6" POSTS AND LOCATED BY THE
- ENGINEER.
- 3. REMOVABLE PANEL SHALL BE 1/2" MARINE PLYWOOD. 4. ALL BOLTS, SCREWS, NAILS, NUTS AND WASHERS SHALL BE GALVANIZED
- 4. ALL BOLTS, SCREWS, NAILS, NOTS AND WASHERS SHALL BE GALVANIZ OR CADMIUM PLATED.
- 5. 4" x 6" POST SHALL BE WOLMANIZED OR PENTACHLOROPHENOL TREATED.
 6. ALL WOOD SURFACES SHALL HAVE PRIME COAT AND TWO (2) COATS OF SHERWIN-WILLIAMS KEM-LUSTRA ENAMEL OR EQUAL.

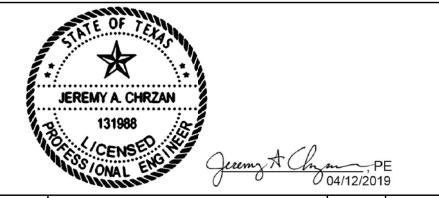

NO.	REVISIONS	DATE	NAME	
				1
				1

TOOLEDESIGN


8484 Georgia Avenue, Suite 800, Silver Spring, MD 20910
TEL (301) 927-1900
TBPE Registration No. 14667

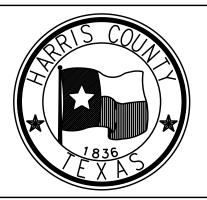


HARRIS COUNTY

ENGINEERING DEPARTMENT

		· · · · · · · · · · · · · · · · · · ·	
PROJECT TITL			
	CLEBURNE STREETS ON-STR	FEI BIK	<u>EWAY</u>
	SHEET DESCRIPTION:		
CB/FL	PROJECT SIGN DETAIL		
CK'D BY:			
JC			
SCALE:	CUEET 1 OF 1		
	SHEET 1 OF 1		
DATE:	APPROVED BY:		
04/12/19			
		SHEET	NO:

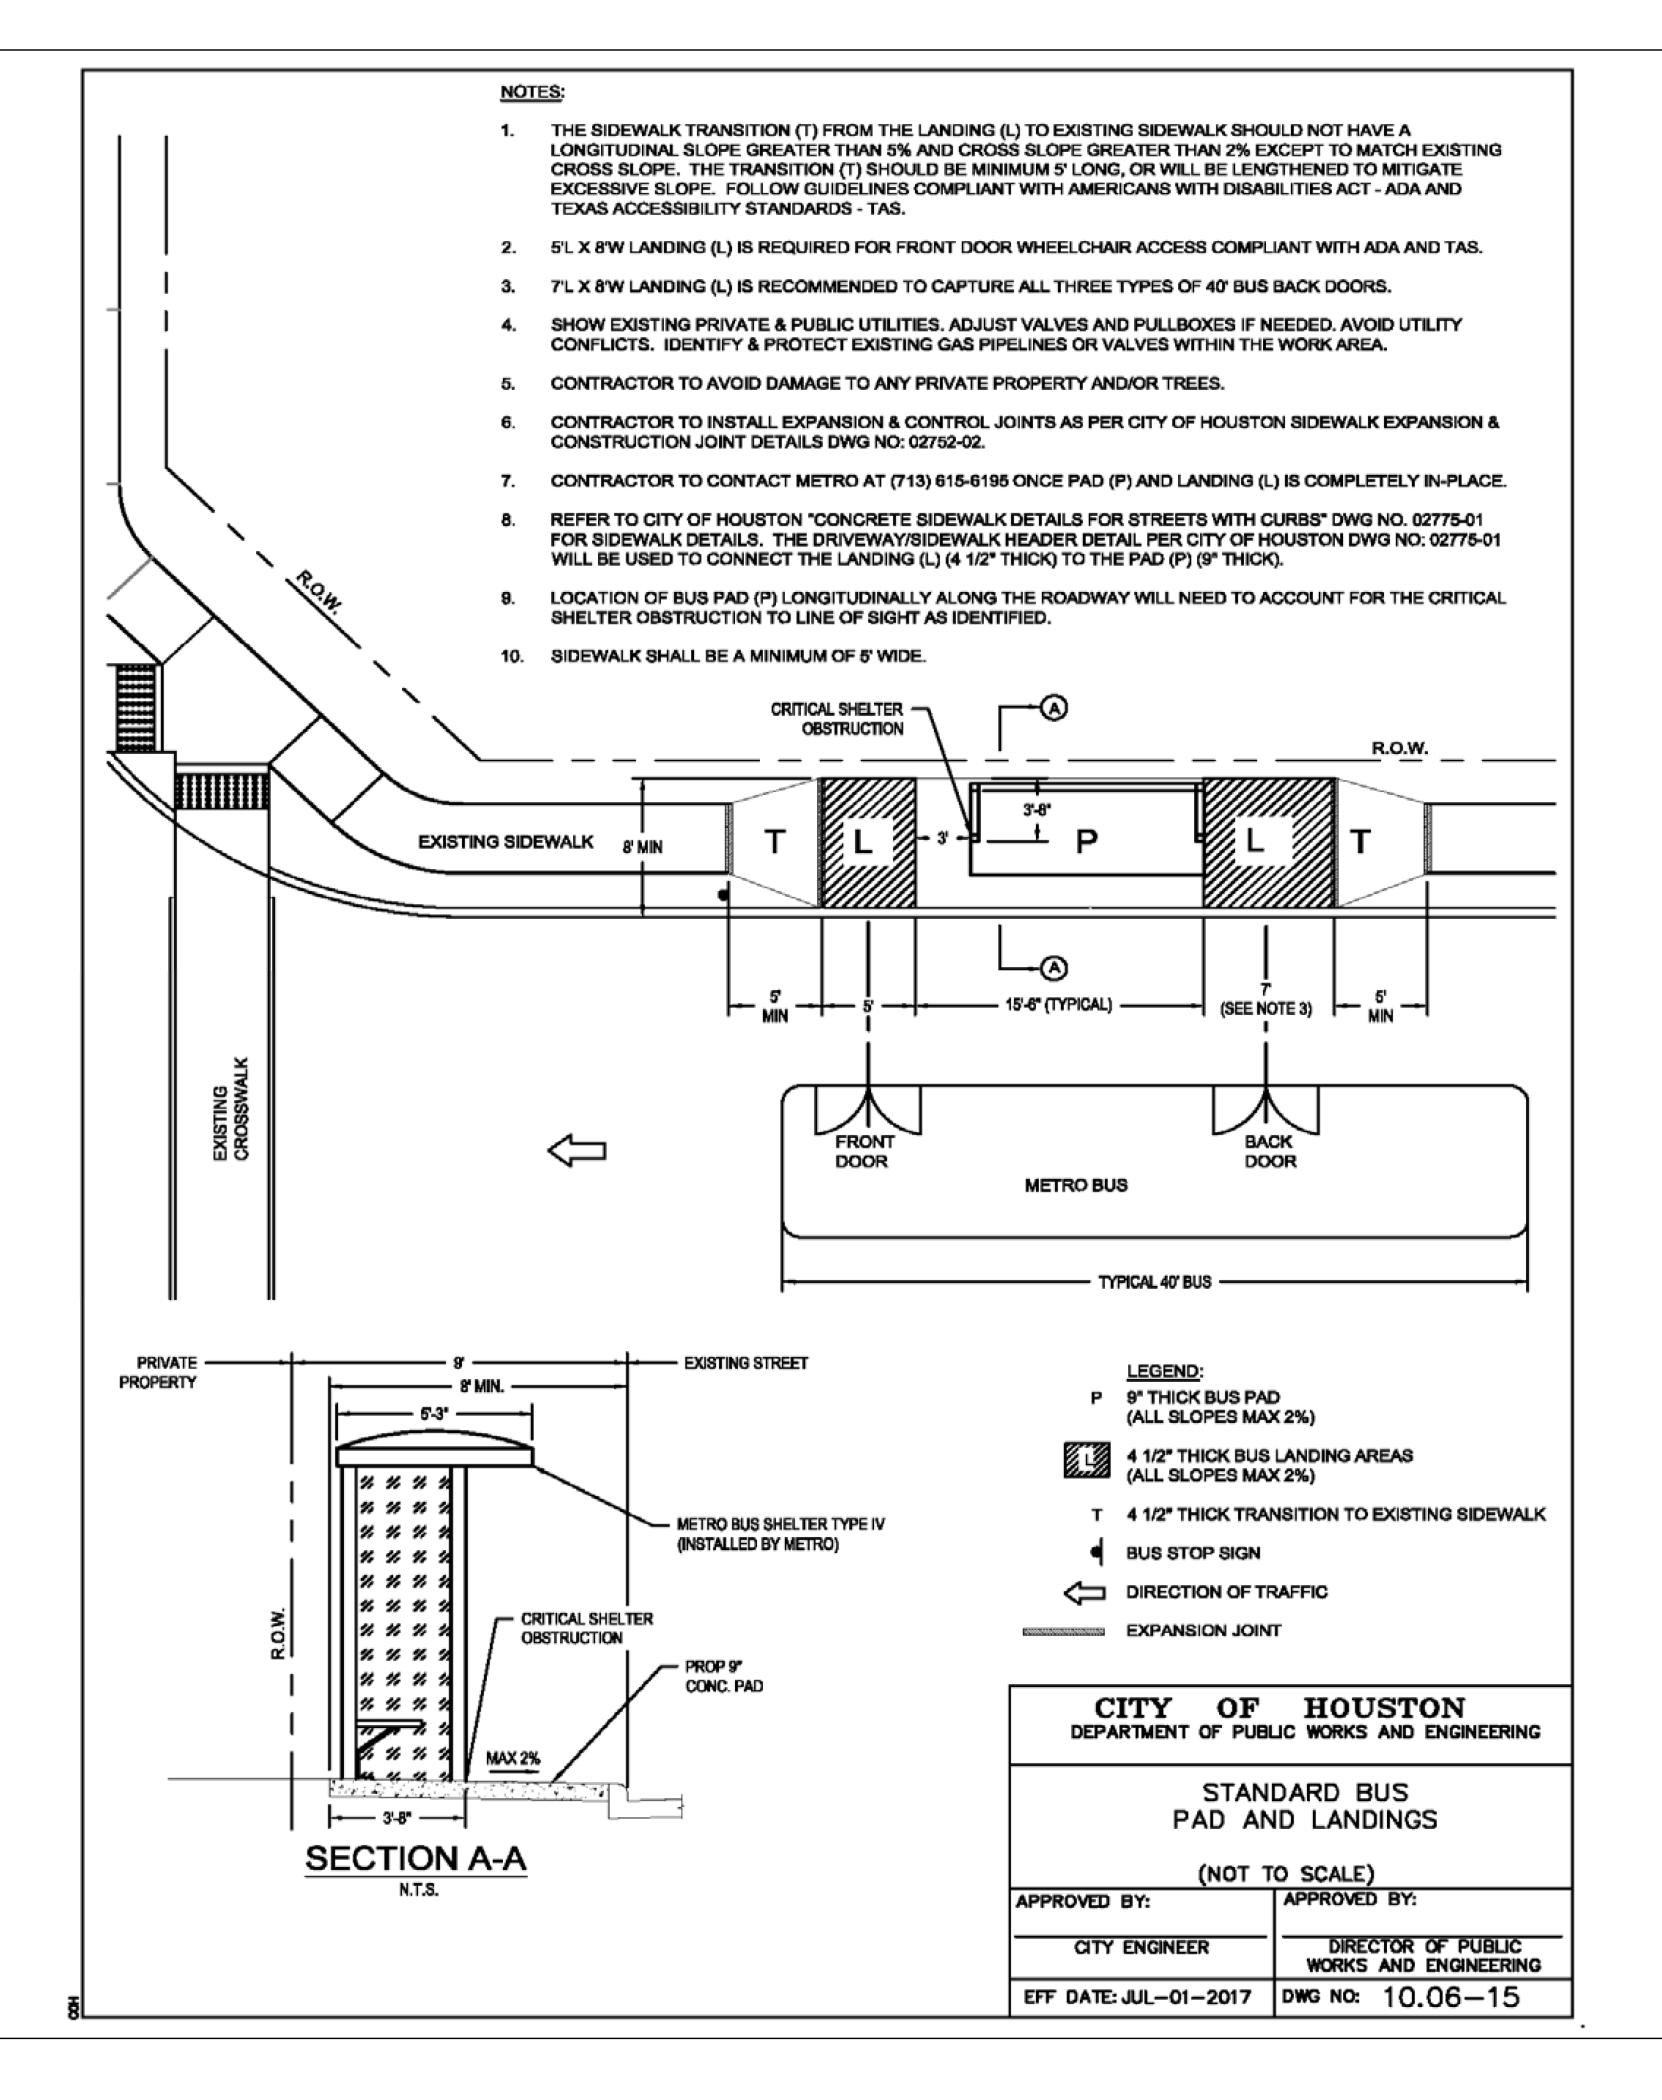


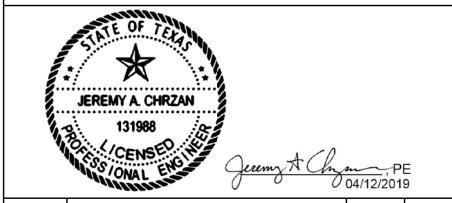

NO.	REVISIONS	DATE	NAME	


1'OOLE DESIGN

8484 Georgia Avenue, Suite 800, Silver Spring, MD 20910
TEL (301) 927-1900
TBPE Registration No. 14667

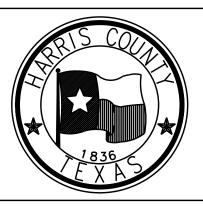



HARRIS COUNTY

	CLEBURNE STREETS ON-STR	EET BIKEWAY
DRAWN BY:	SHEET DESCRIPTION:	
CB/FL	BUS PAD AND LANDING	DETAILS
CK'D BY: JC		
SCALE:	SHEET 1 OF 1	
DATE:	APPROVED BY:	
04/12/19		
		SHEET NO:
		311

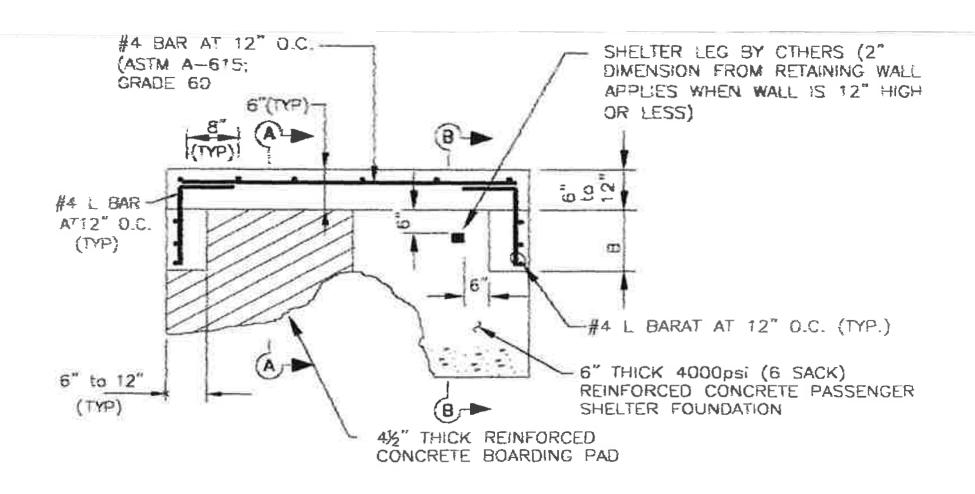


PLAN RETAINING WALL DETAIL

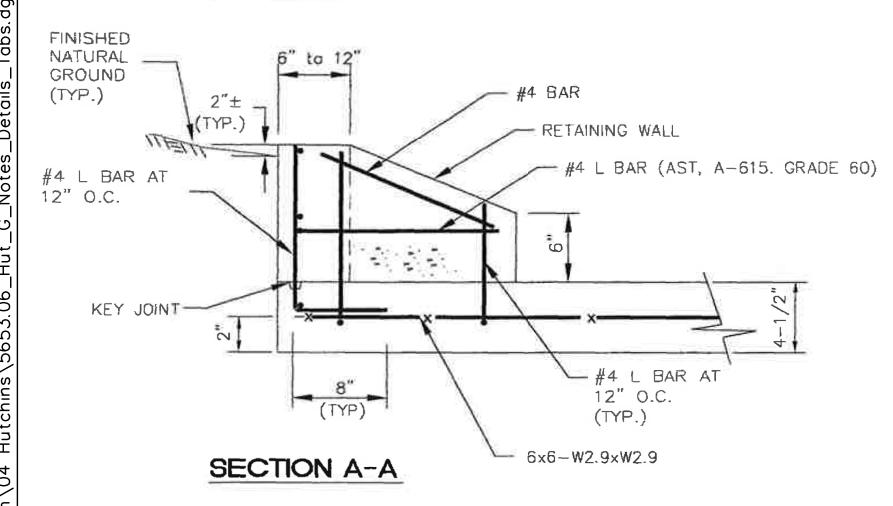


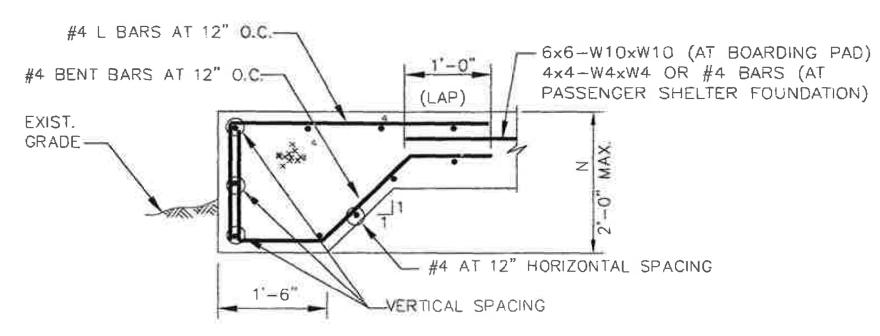


(WHEN REQUIRED WILL BE INDICATED ON SITE PLAN)

GRADE BEAM DETAIL (TYP)

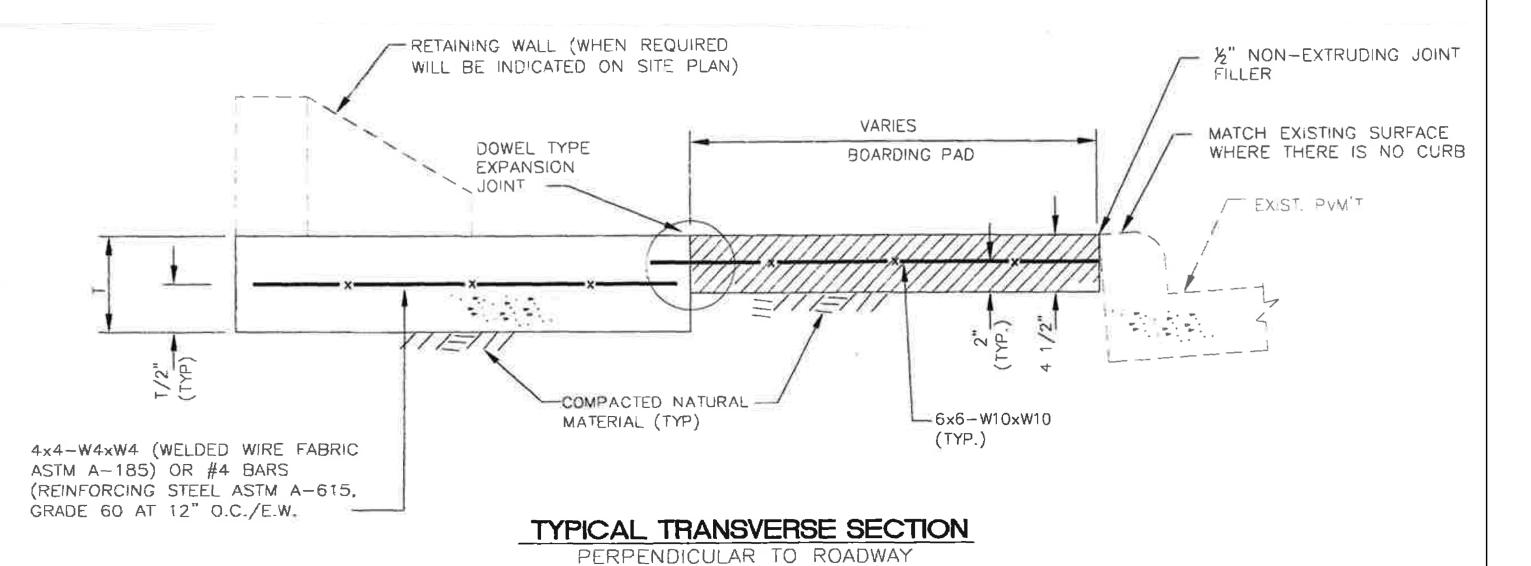

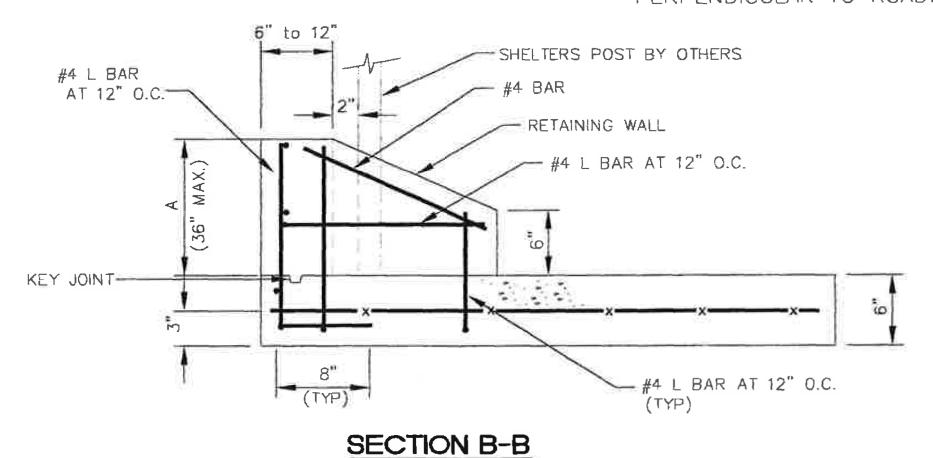

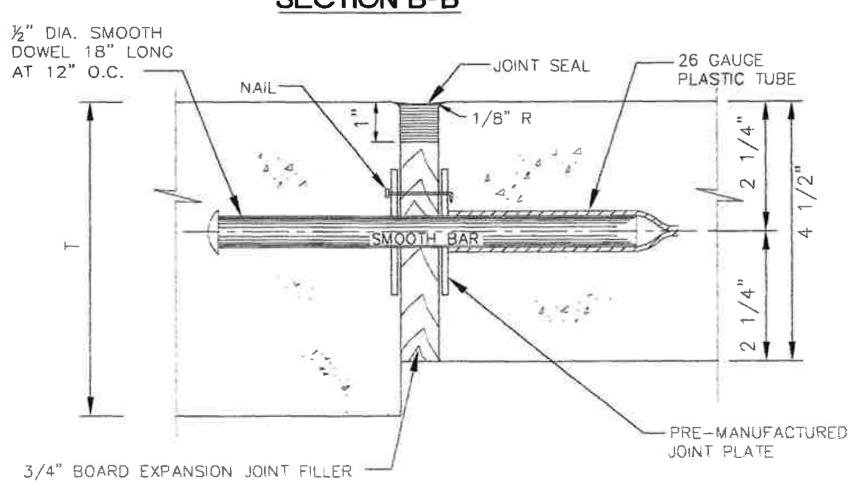


DOWEL TYPE EXPANSION JOINT

JEREMY A. CHRZAN CENSE N

NO.	REVISIONS	DATE	NAME

TOOLE DESIGN

8484 Georgia Avenue, Suite 800, Silver Spring, MD 20910 TEL (301) 927-1900 TBPE Registration No. 14667

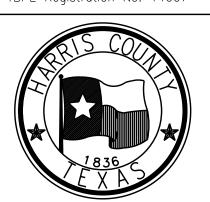

NOTES FOR RETAINING WALL

1. SEE SITE PLAN FOR VALUES OF 'A' AND 'B'.

3. FOR THICKNESS SEE SPECIFIC SITE DRAWING.


2. US 1" CHAMFER STRIP AROUND EXPOSED

EDGES OF RETAINING WALL.

HARRIS COUNTY

PROJECT TITL	PROJECT TITLE:				
	HUTCHINS/CLEBURNE STREETS ON-STREET BIKEWAY				
DRAWN_BY:	SHEET DESCRIPTION:				
CB/FL	PASSENGER SHELTER FOUND	ATION			
CK'D BY:					
JC	JC DETAILS TYPE I, II, AND IV				
SCALE:	SHEET 1 OF 1				
NTS					
DATE:	APPROVED BY:				
04/12/19					
	SHE	ET NO:			
	312	2			
1					



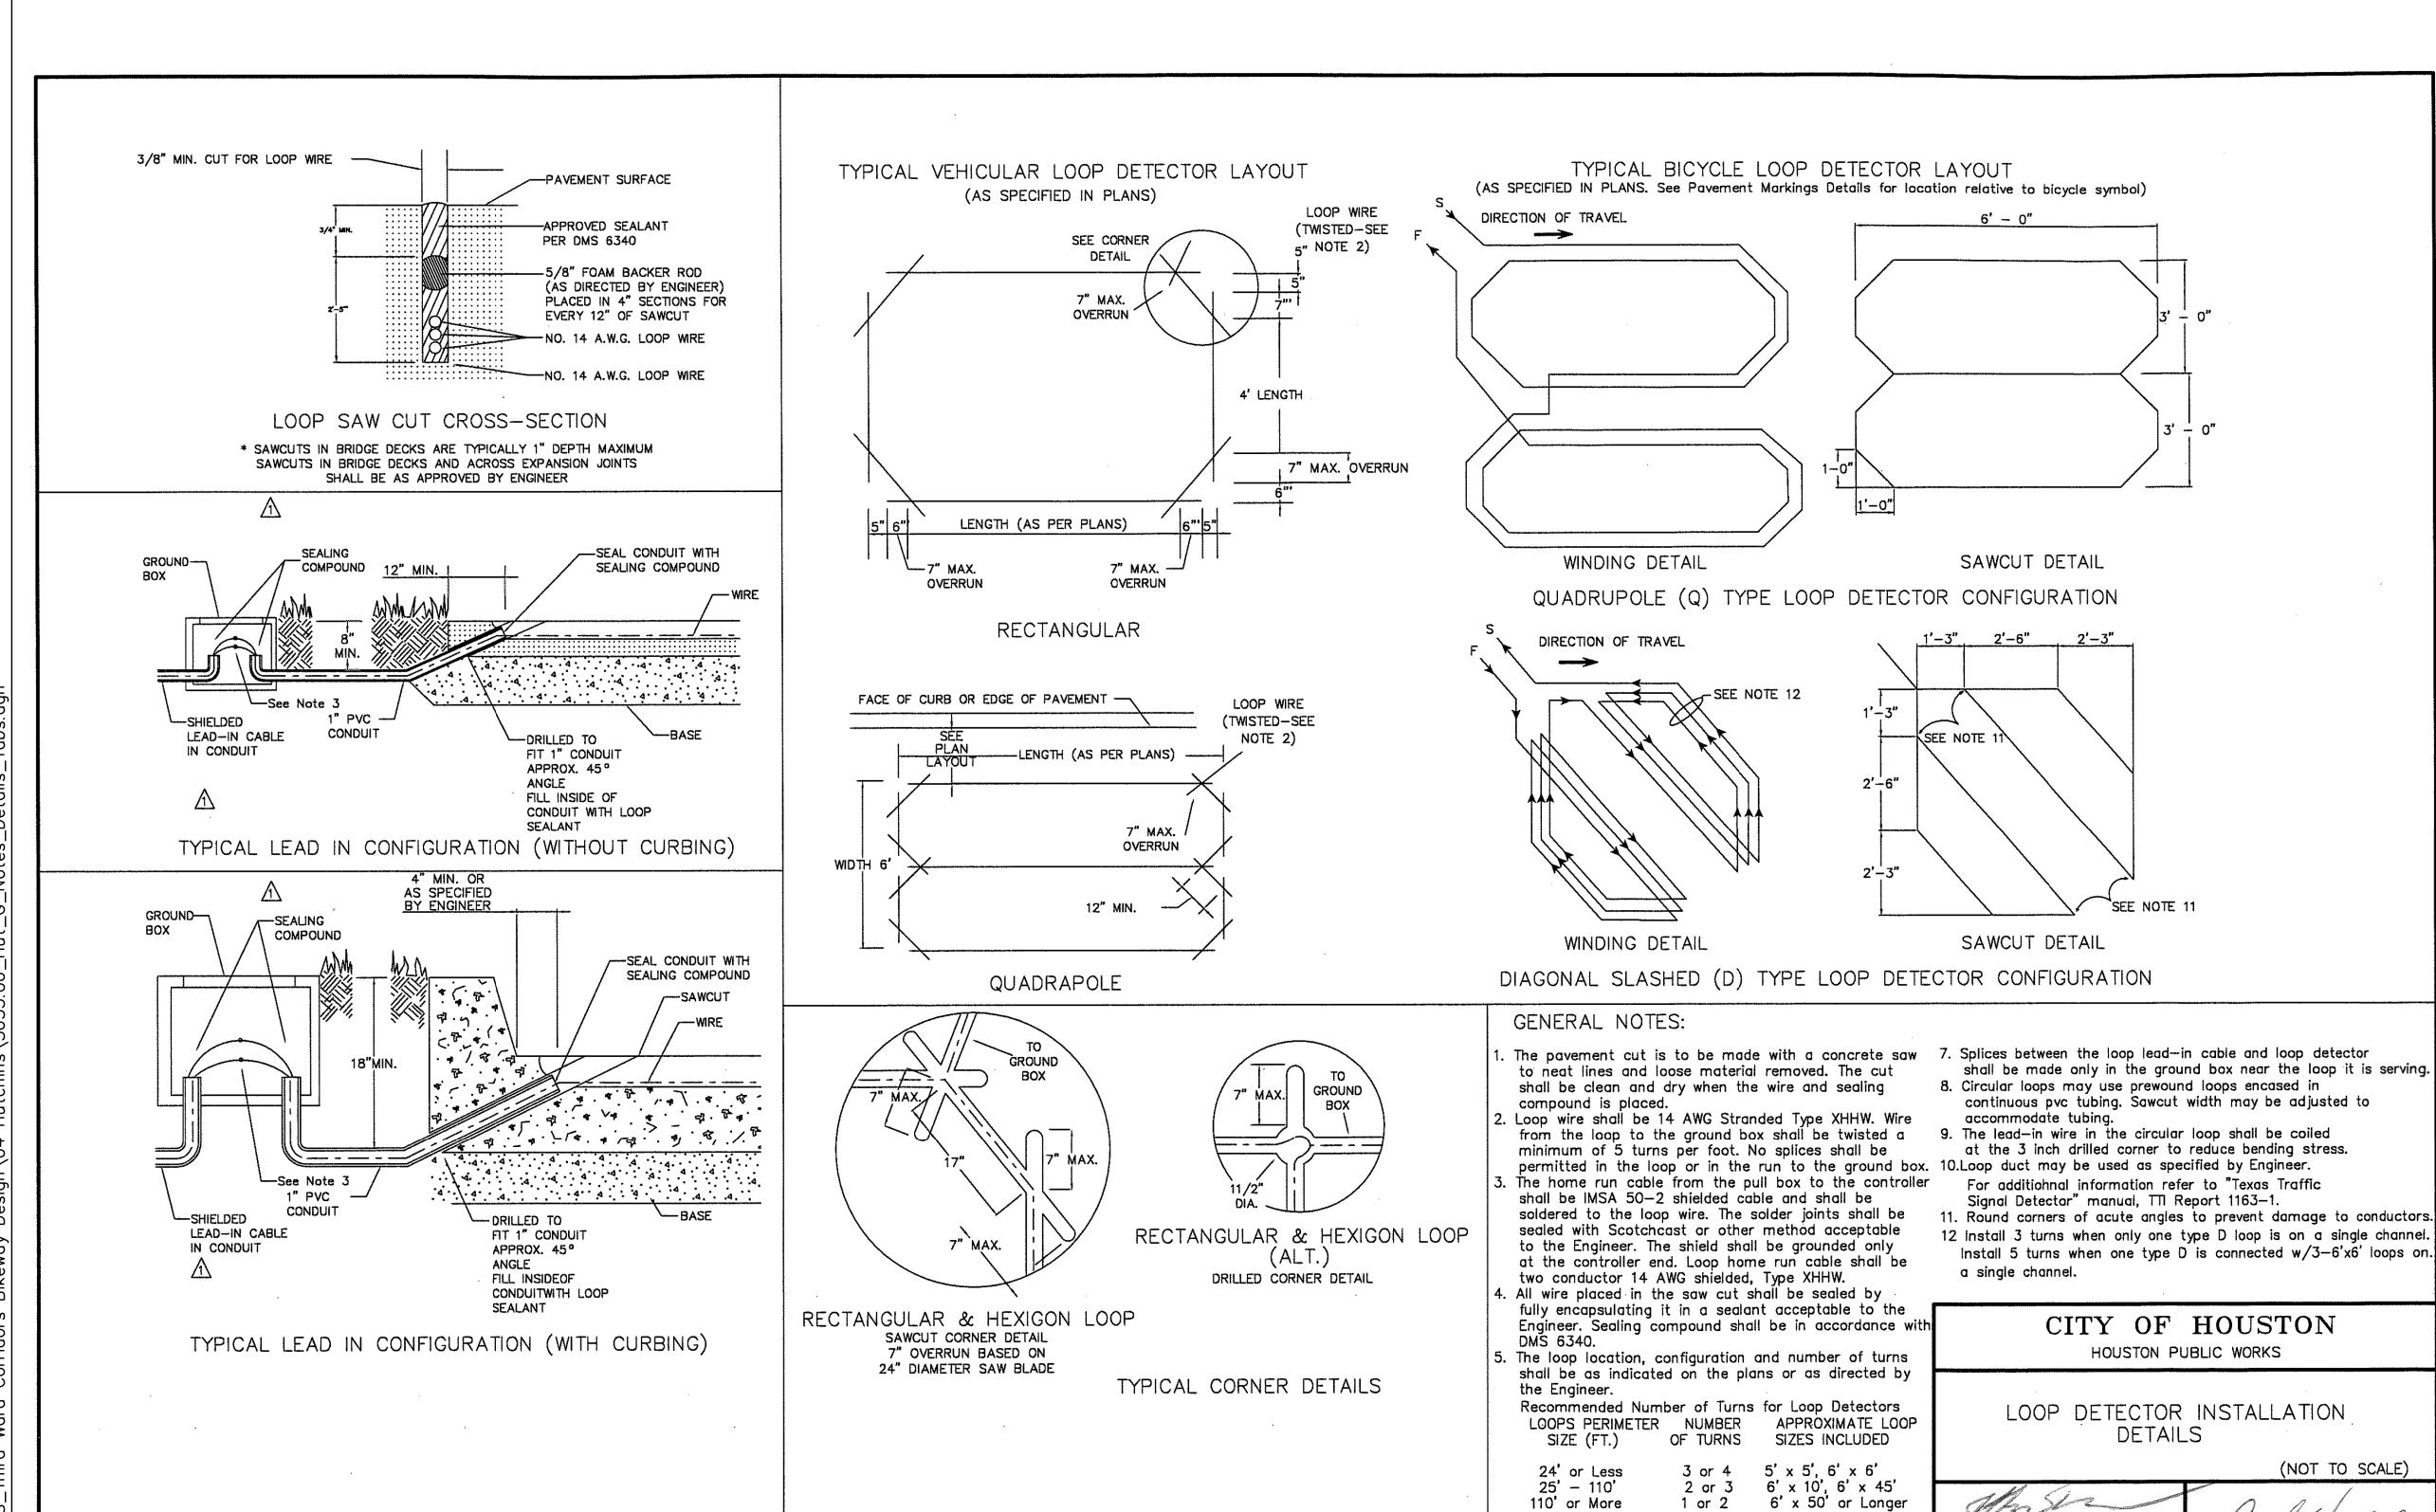



TOOLE DESIGN

8484 Georgia Avenue, Suite 800, Silver Spring, MD 20910 TEL (301) 927-1900 TBPE Registration No. 14667

CITY OF HOUSTON

HOUSTON PUBLIC WORKS

(NOT TO SCALE)

DIRECTOR OF HOUSTON PUBLIC WORKS

DWG NO: 02893-11

DETAILS


CITY TRAFFIC ENGINEER

CITY ENGINEER U

EFF DATE: JUL-01-2018

6. A separate saw cut shall be made from each loop to the


edge of pavement or as specified by the Engineer.

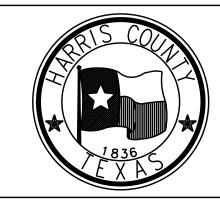

HARRIS COUNTY ENGINEERING DEPARTMENT

PROJECT TITLE:
HUTCHINS/CLEBURNE STREETS ON-STREET BIKEWAY
DRAWN BY: SHEET DESCRIPTION:
CB/FL LOOP DETECTOR INSTALLATION DETAILS CK'D BY: JC SHEET 1 OF 1 NTS APPROVED BY: 04/12/19

SHEET NO:

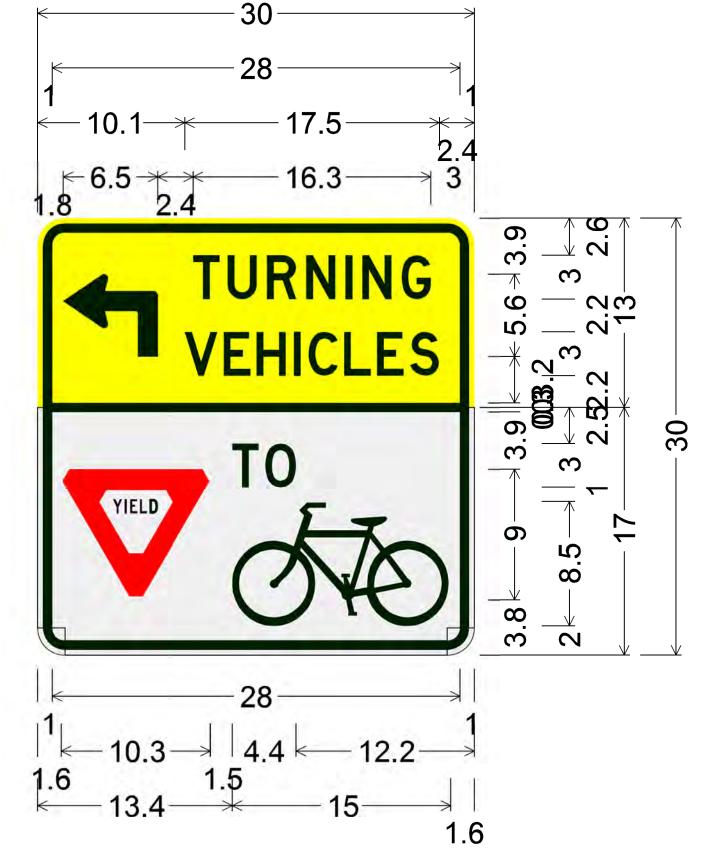

Identifier: R10-15L(BIKE) (MOD);

1.9" Radius, 0.6" Border, 0.4" Indent, Black on Yellow; 90 Deg Advance Turn Arrow Custom 6.5" X 5.7";


[TURNING] D specified length;

[VEHICLES] D specified length;

1.9" Radius, 0.6" Border, 0.4" Indent, Black on White;

[TO] D specified length;

Symbol RG025;

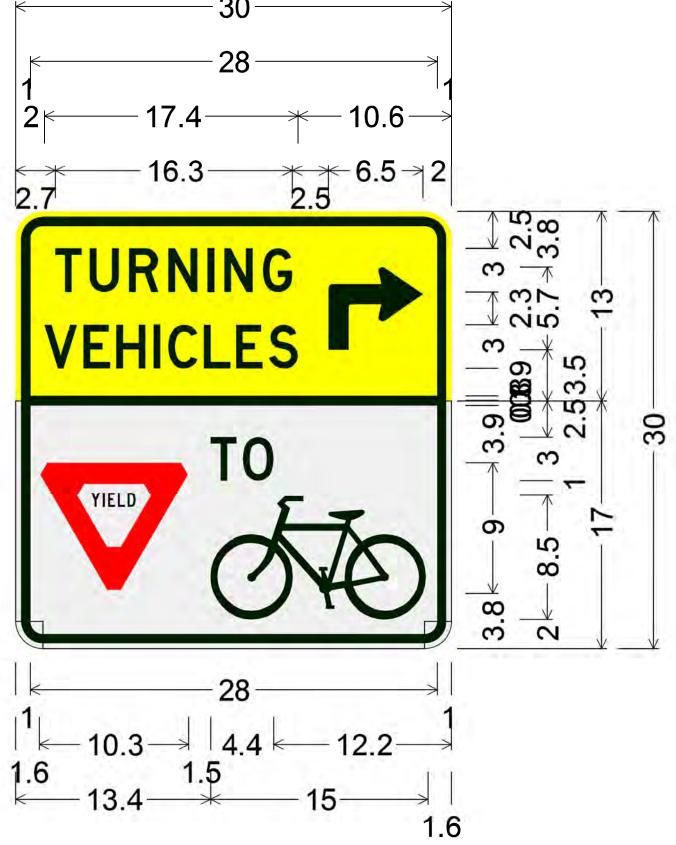

Identifier: R10-15L(BIKE)(MOD);


1.9" Radius, 0.6" Border, 0.4" Indent, Black on Yellow; [TURNING] D specified length;

[VEHICLES] D specified length;

90 Deg Advance Turn Arrow Custom 6.5" X 5.7";

1.9" Radius, 0.6" Border, 0.4" Indent, Black on White; [TO] D specified length;

Symbol RG025;

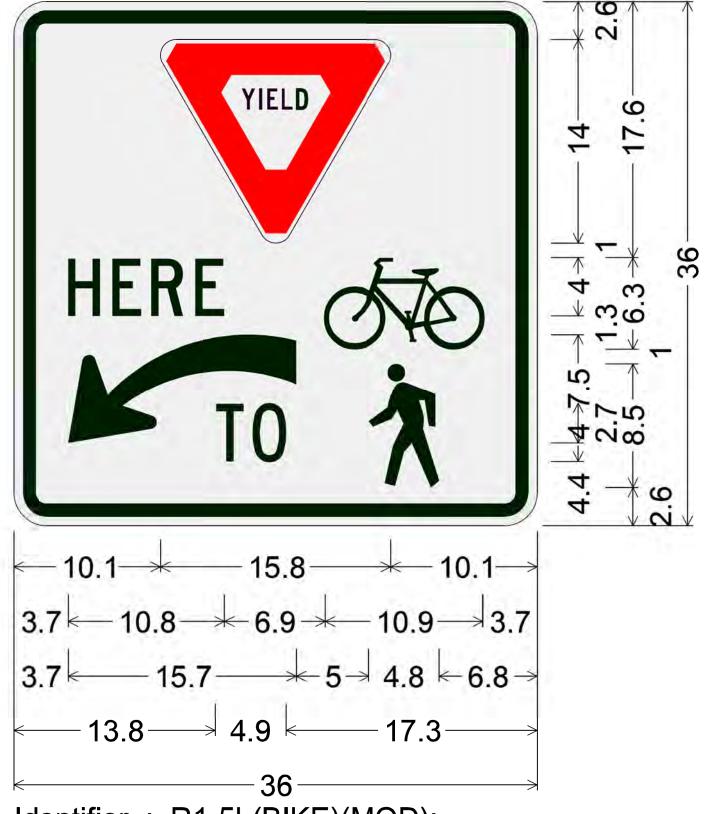


Identifier: R1-5L(BIKE)(MOD);

2.3" Radius, 0.9" Border, 0.6" Indent, Black on White; [HERE] C specified length;

[TO] C specified length;

Symbol RG025 White;

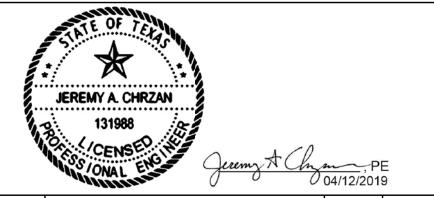

REVISIONS

TOOLE DESIGN




HARRIS COUNTY

ENGINEERING DEPARTMENT


PROJECT TITLE:
HUTCHINS/CLEBURNE STREETS ON-STREET BIKEWAY
DRAWN BY: SHEET DESCRIPTION:
CB/FL ADDITIONAL SIGN DETAILS CB/FL CK'D BY: SHEET 1 OF 1 DATE: APPROVED BY: 04/12/19 SHEET NO:




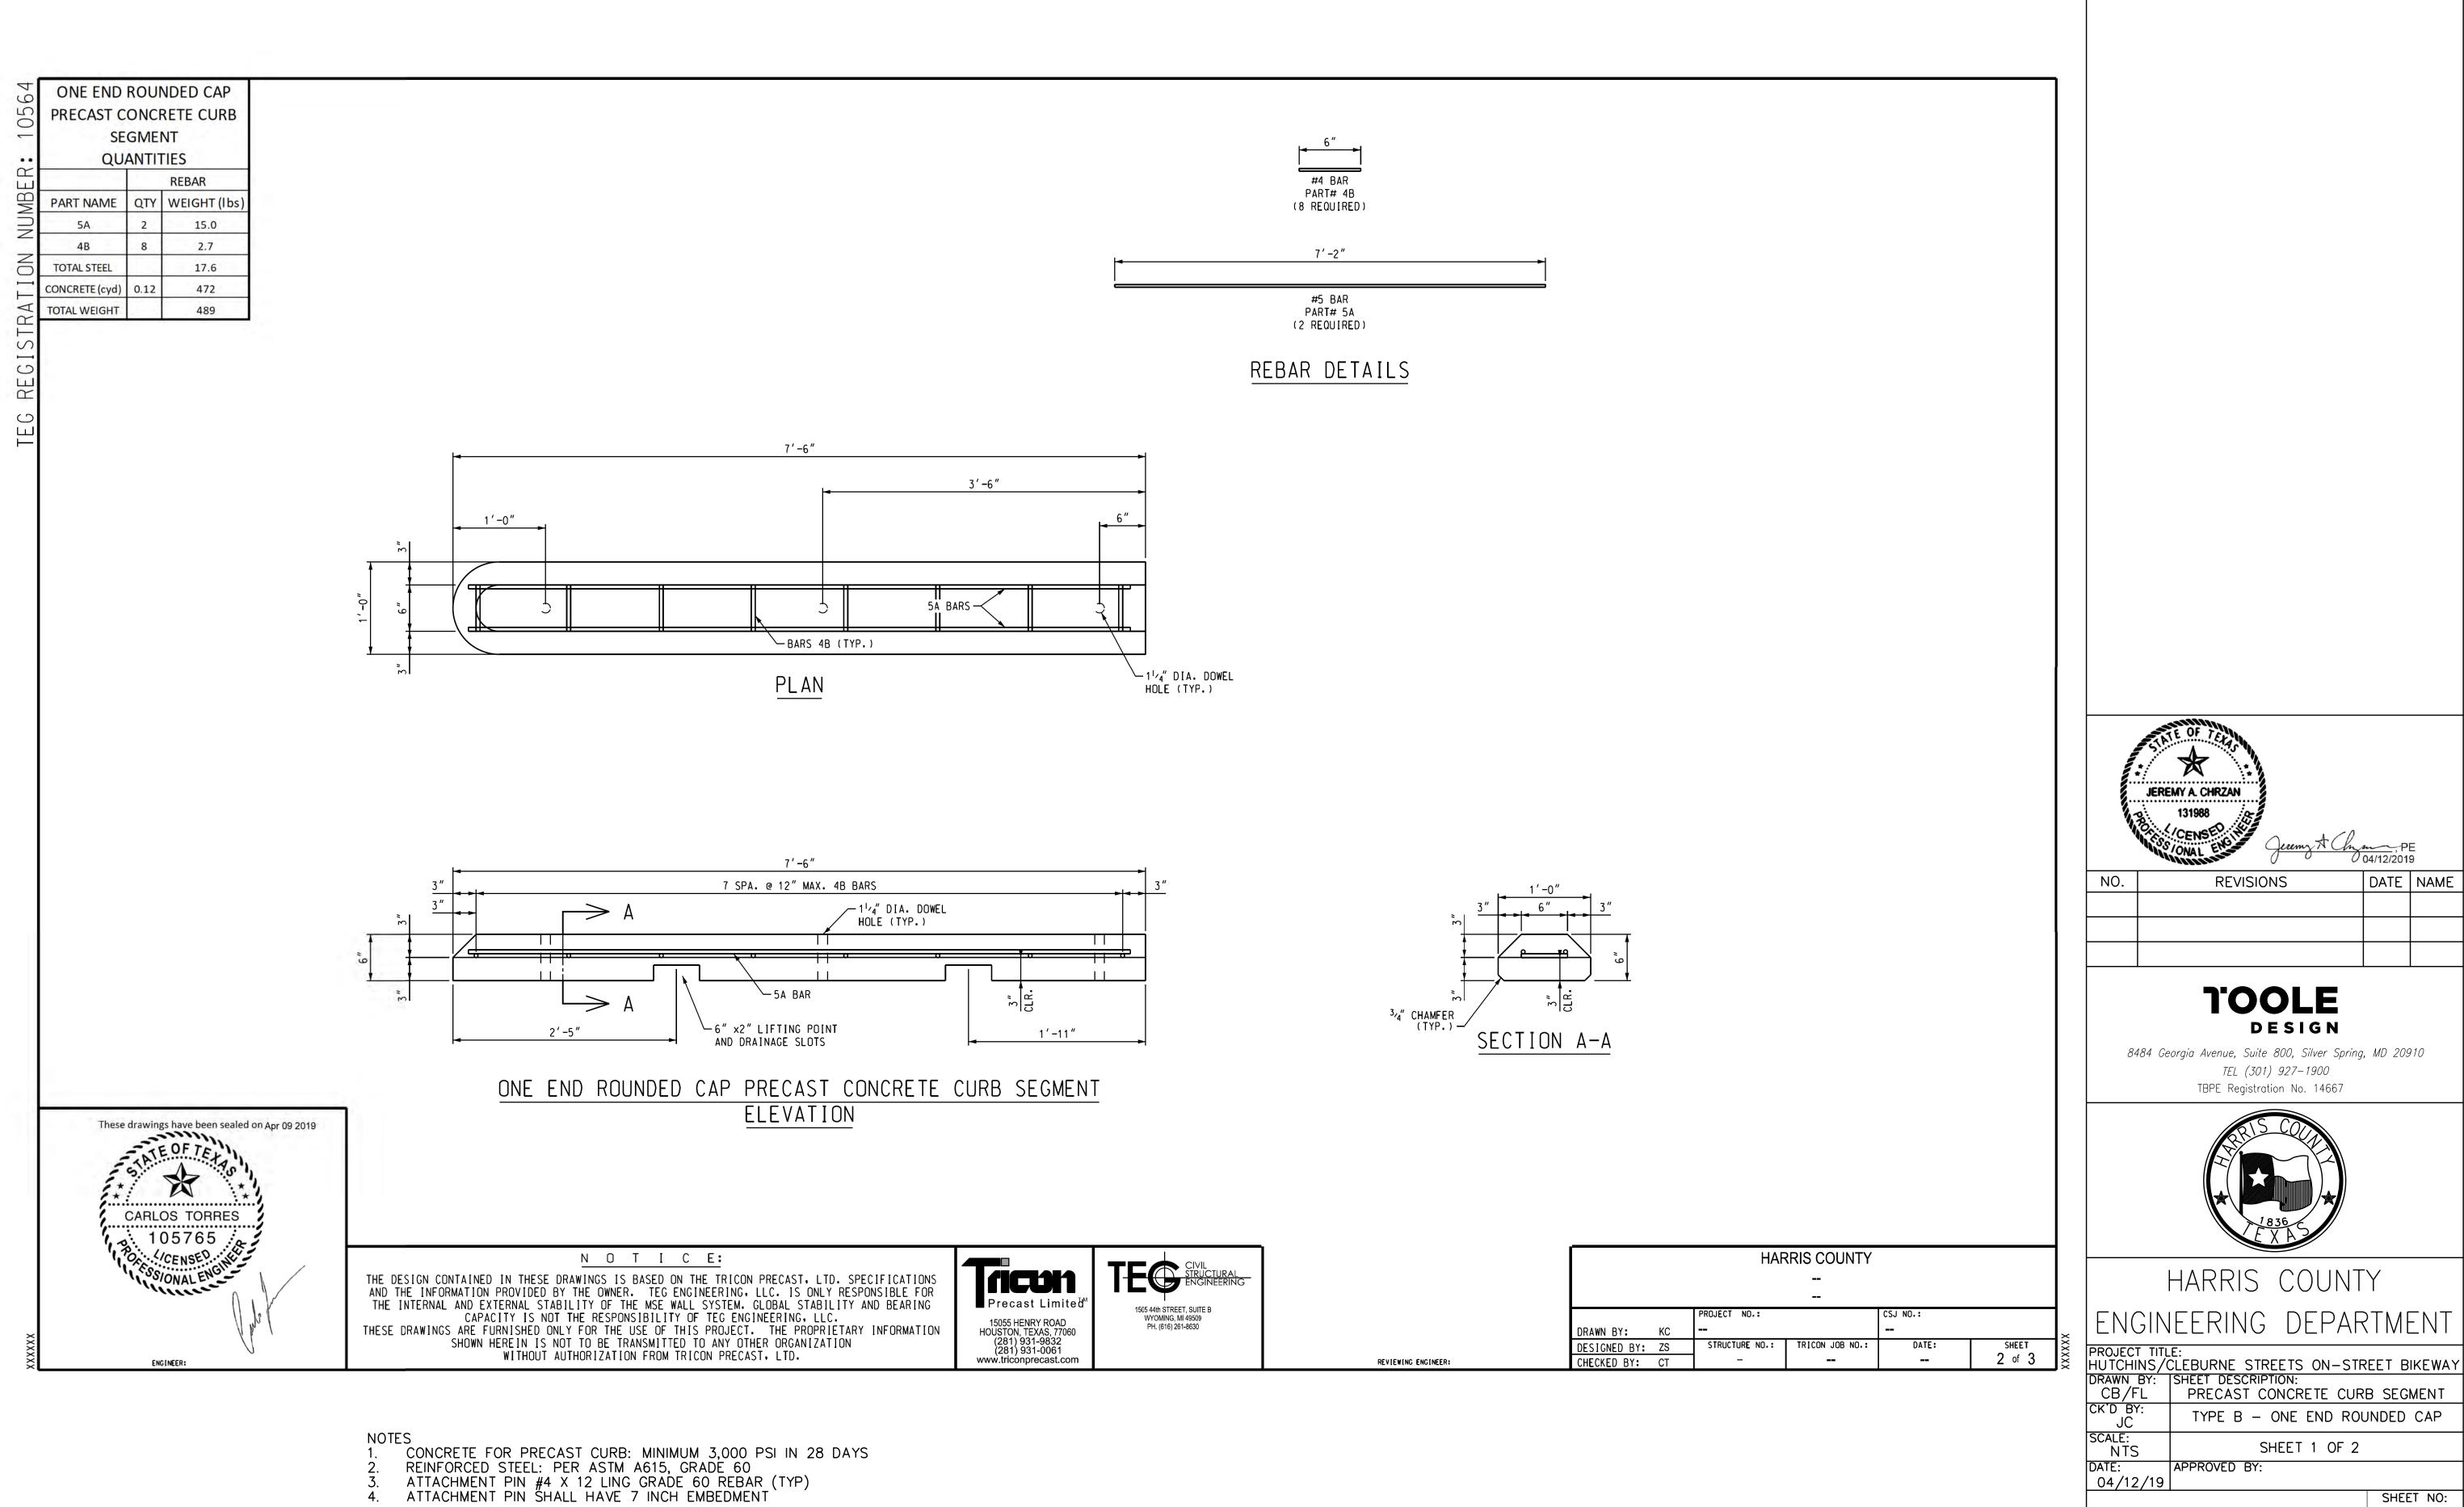

DATE NAME

SHEET NO:

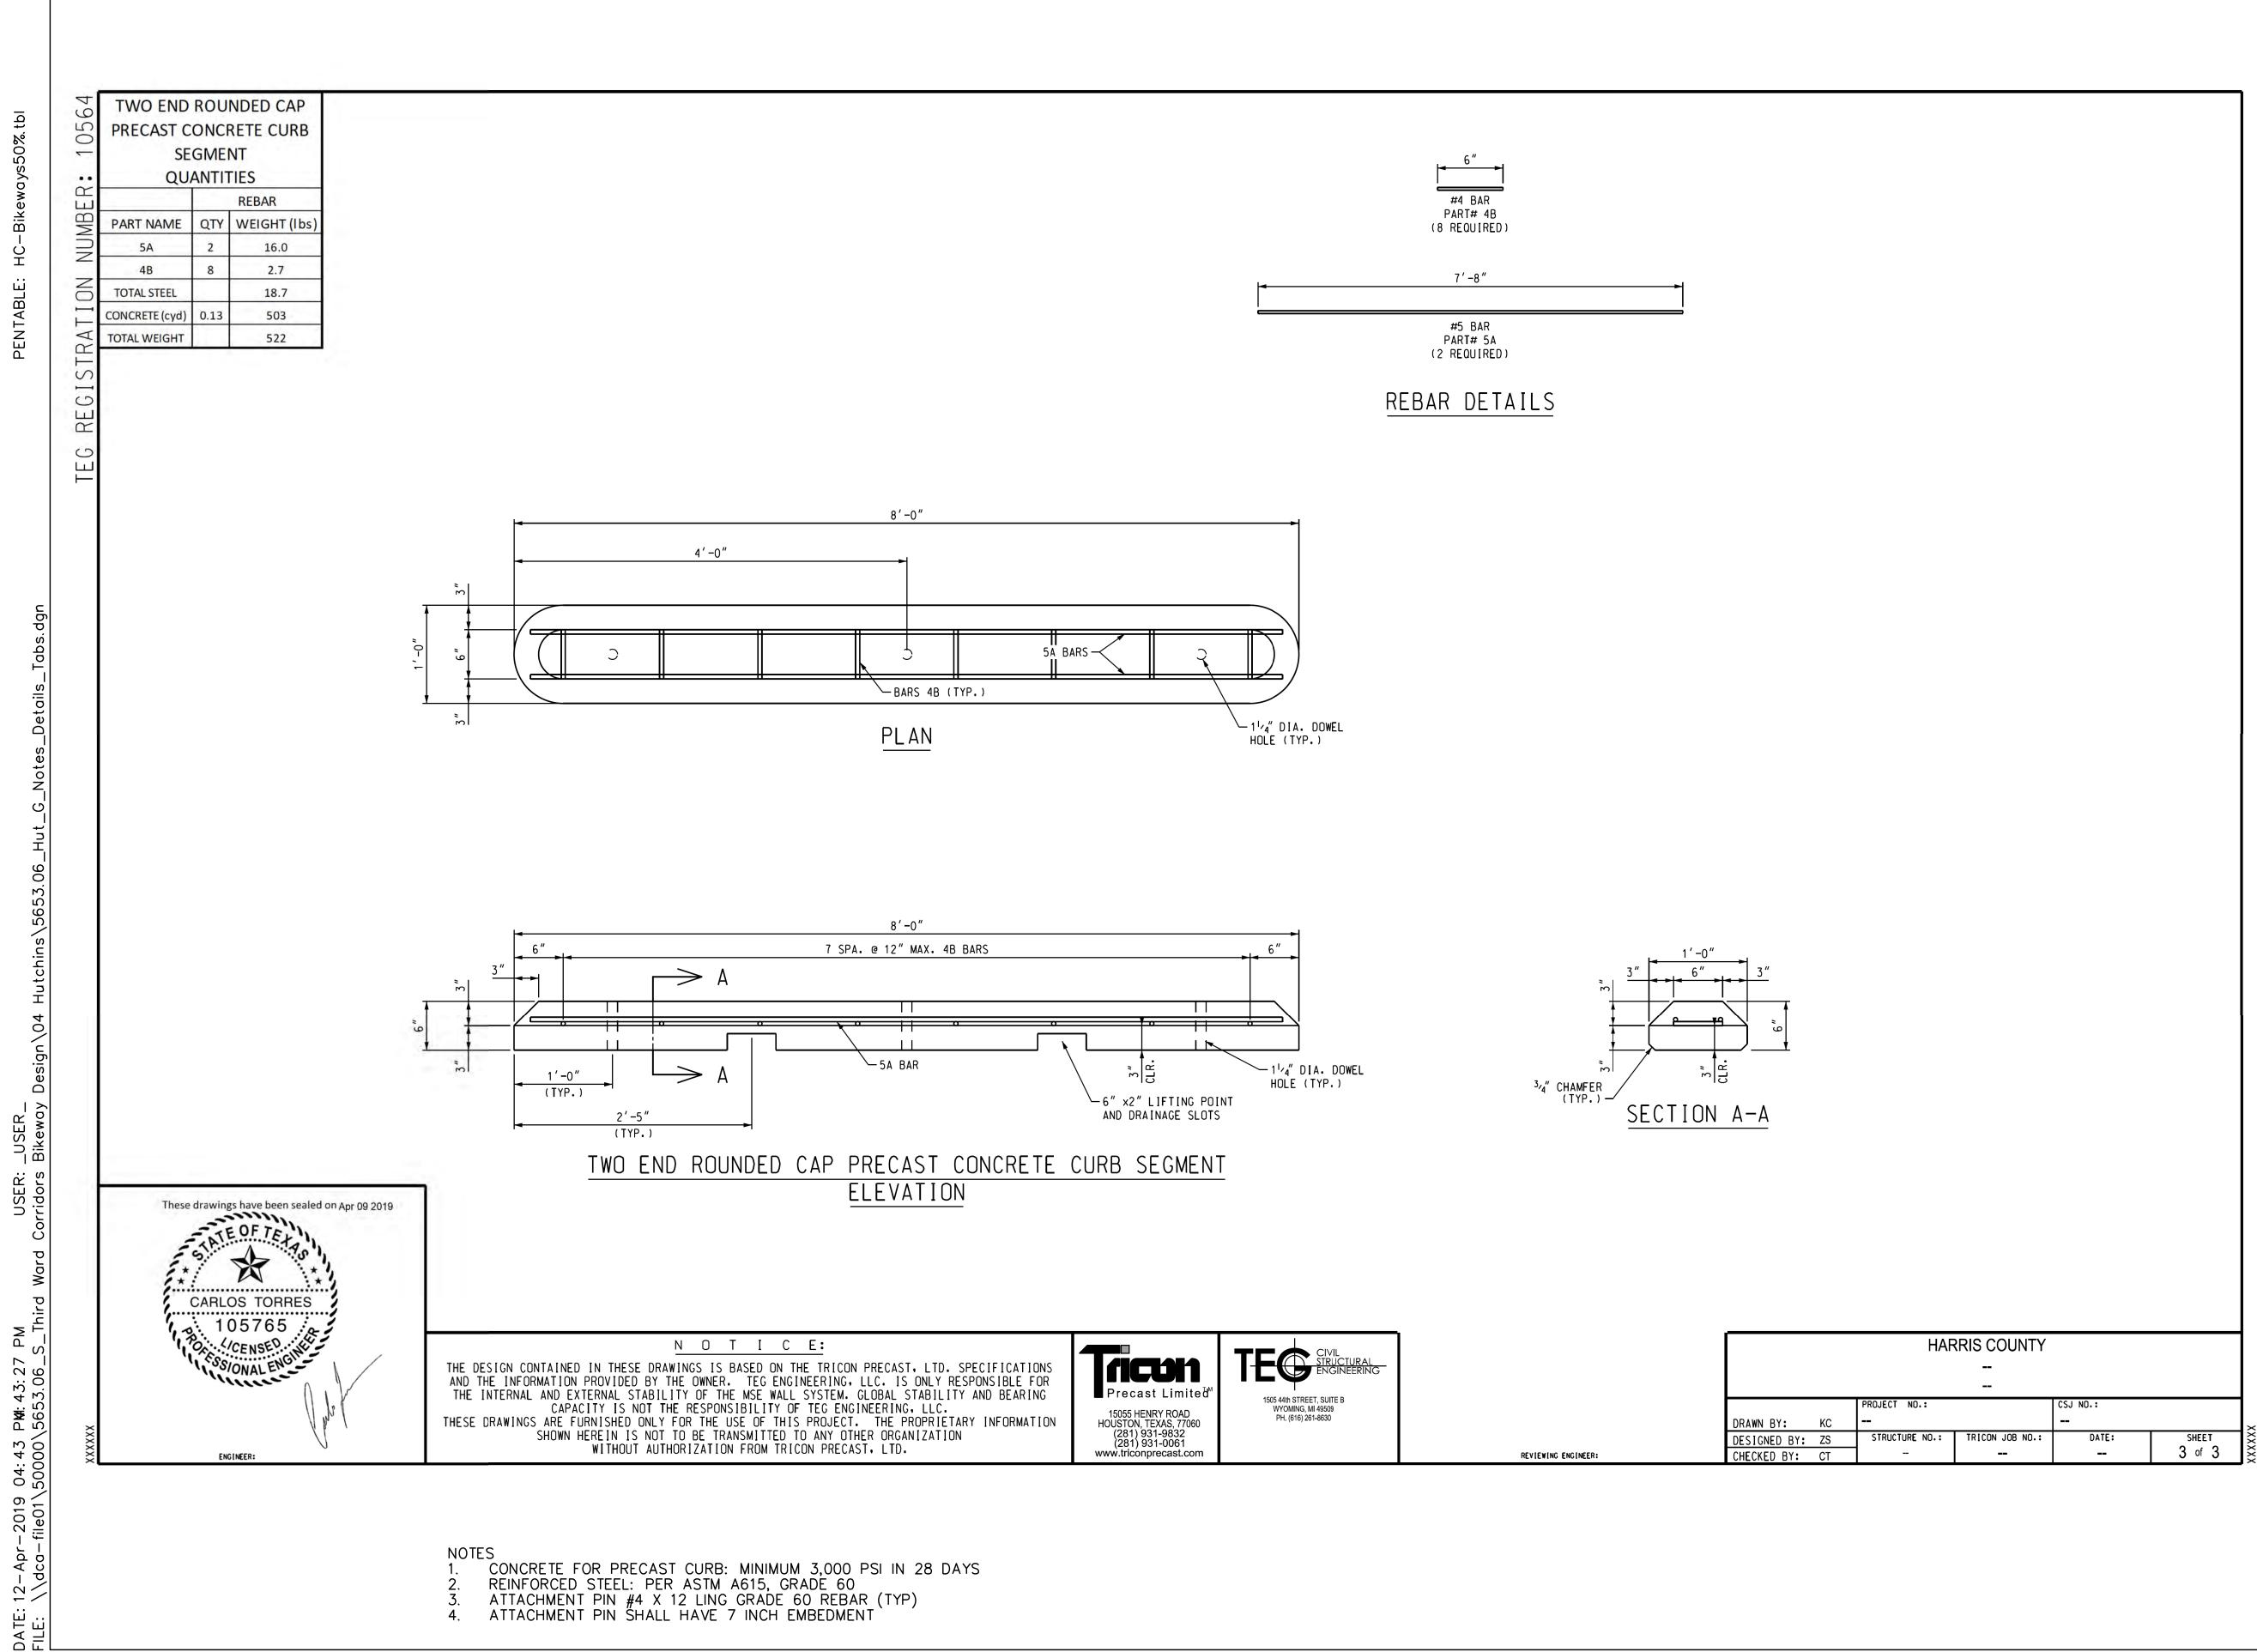


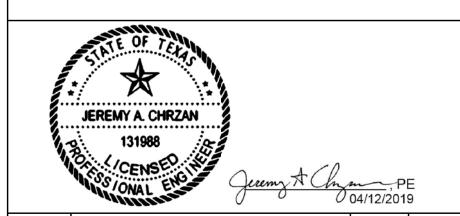

NO.	REVISIONS	DATE	NAME	

TOOLE DESIGN

8484 Georgia Avenue, Suite 800, Silver Spring, MD 20910 TEL (301) 927-1900 TBPE Registration No. 14667

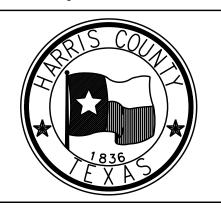


HARRIS COUNTY ENGINEERING DEPARTMENT


>		
Š	PROJECT TITL HUTCHINS/(E: CLEBURNE STREETS ON—STREET BIKEWAY
		SHEET DESCRIPTION: PRECAST CONCRETE CURB SEGMENT
	CK'D BY: JC	TYPE C - TWO END ROUNDED CAP
	SCALE: NTS	SHEET 2 OF 2
	DATE: 04/12/19	APPROVED BY:

SHEET NO:

316


CONCRETE FOR PRECAST CURB: MINIMUM 3,000 PSI IN 28 DAYS REINFORCED STEEL: PER ASTM A615, GRADE 60 ATTACHMENT PIN #4 X 12 LING GRADE 60 REBAR (TYP) ATTACHMENT PIN SHALL HAVE 7 INCH EMBEDMENT

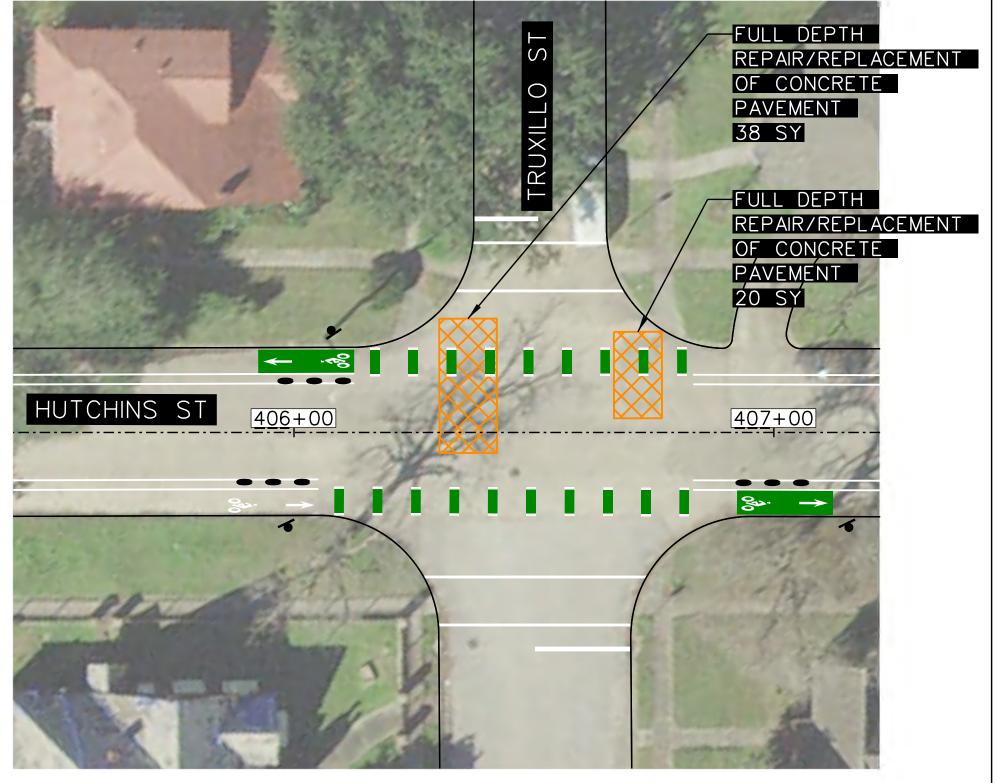

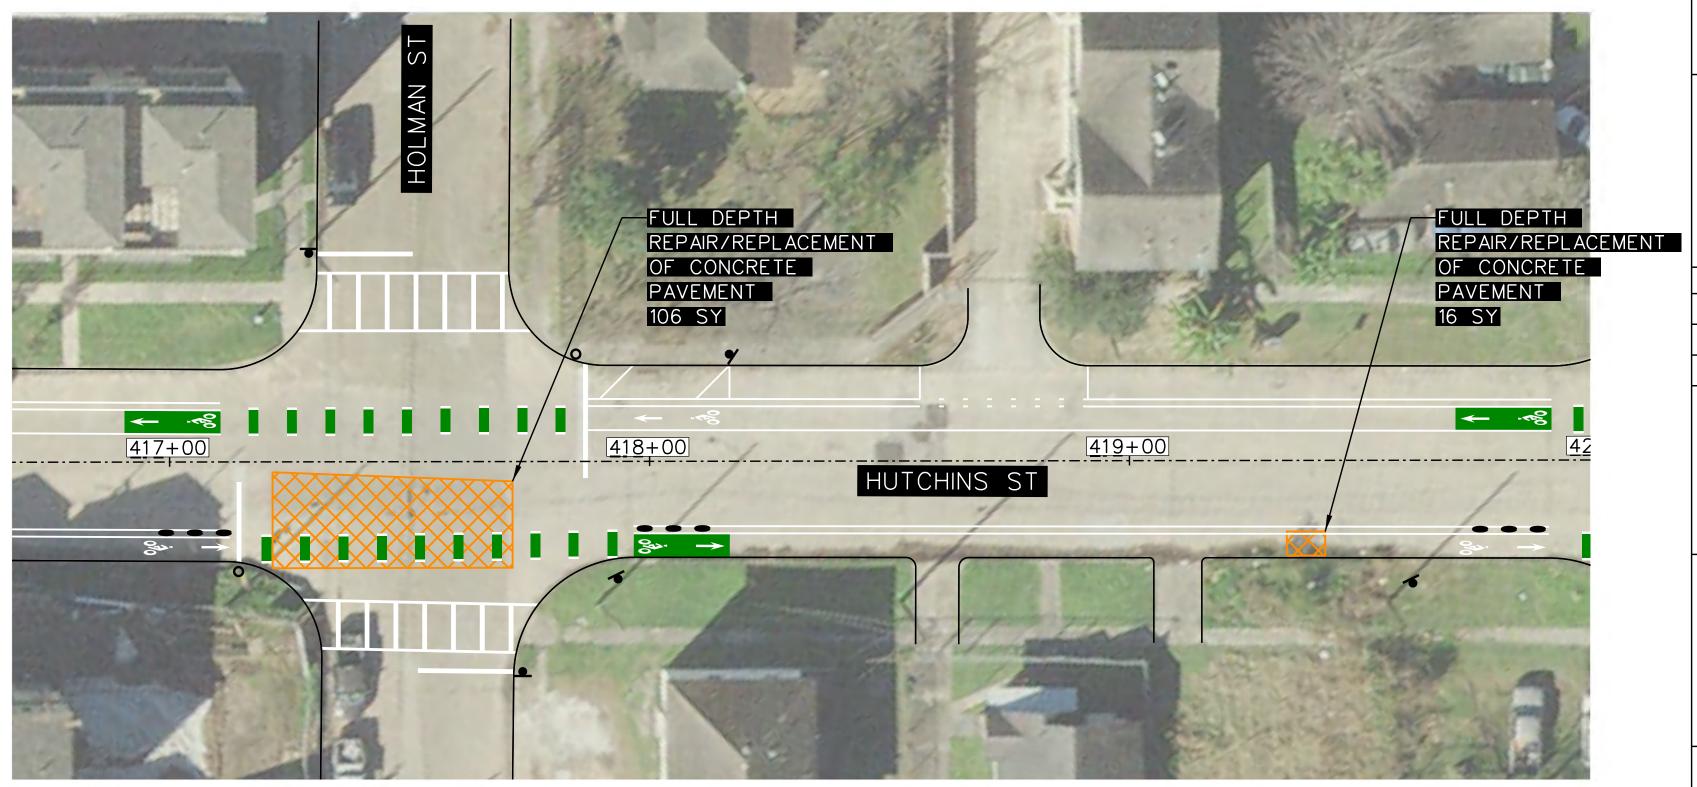




180 SY FULL DEPTH REPAIR/REPLACEMENT OF CONCRETE PAVEMENT

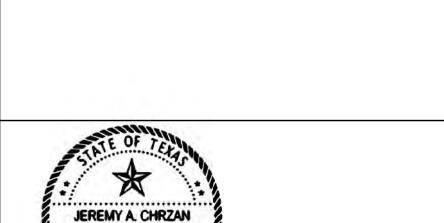

NO.	REVISIONS	DATE	NAME

TOOLEDESIGN


8484 Georgia Avenue, Suite 800, Silver Spring, MD 20910
TEL (301) 927-1900
TBPE Registration No. 14667

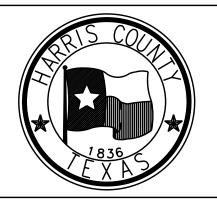


HARRIS COUNTY

ENGINEERING DEPARTMENT

	CLEBURNE STREETS ON-STR	EET B	IKE'	WAY
DRAWN BY:	SHEET DESCRIPTION:			
CB/FL	PAVING SHEETS			
CK'D BY: JC	HUTCHINS ST PAVING REPAIR TRUXILLO ST AND HOLMAN ST	AT		
SCALE: 1"=20'	SHEET 1 OF 1			
DATE:	APPROVED BY:			
04/12/19				
		SHEE	TN	10:

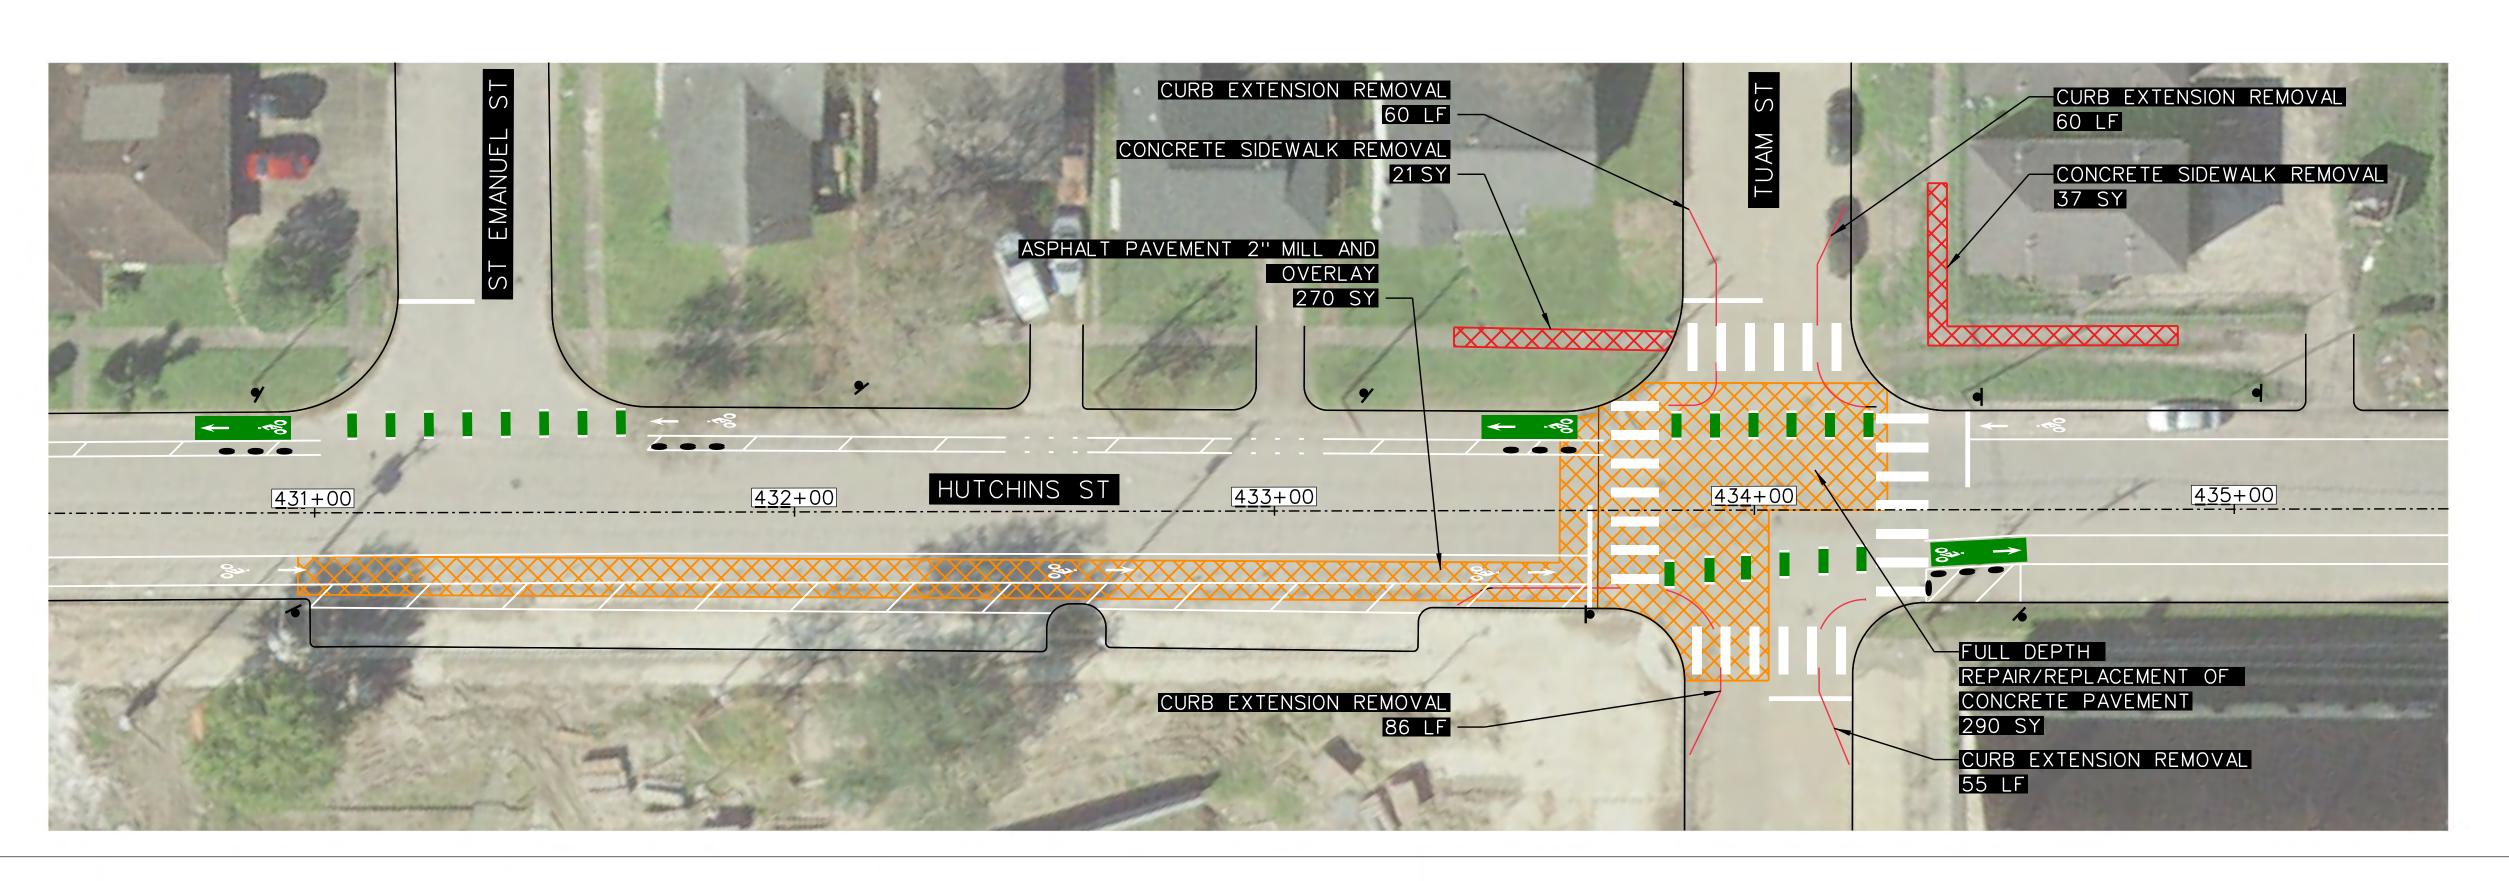

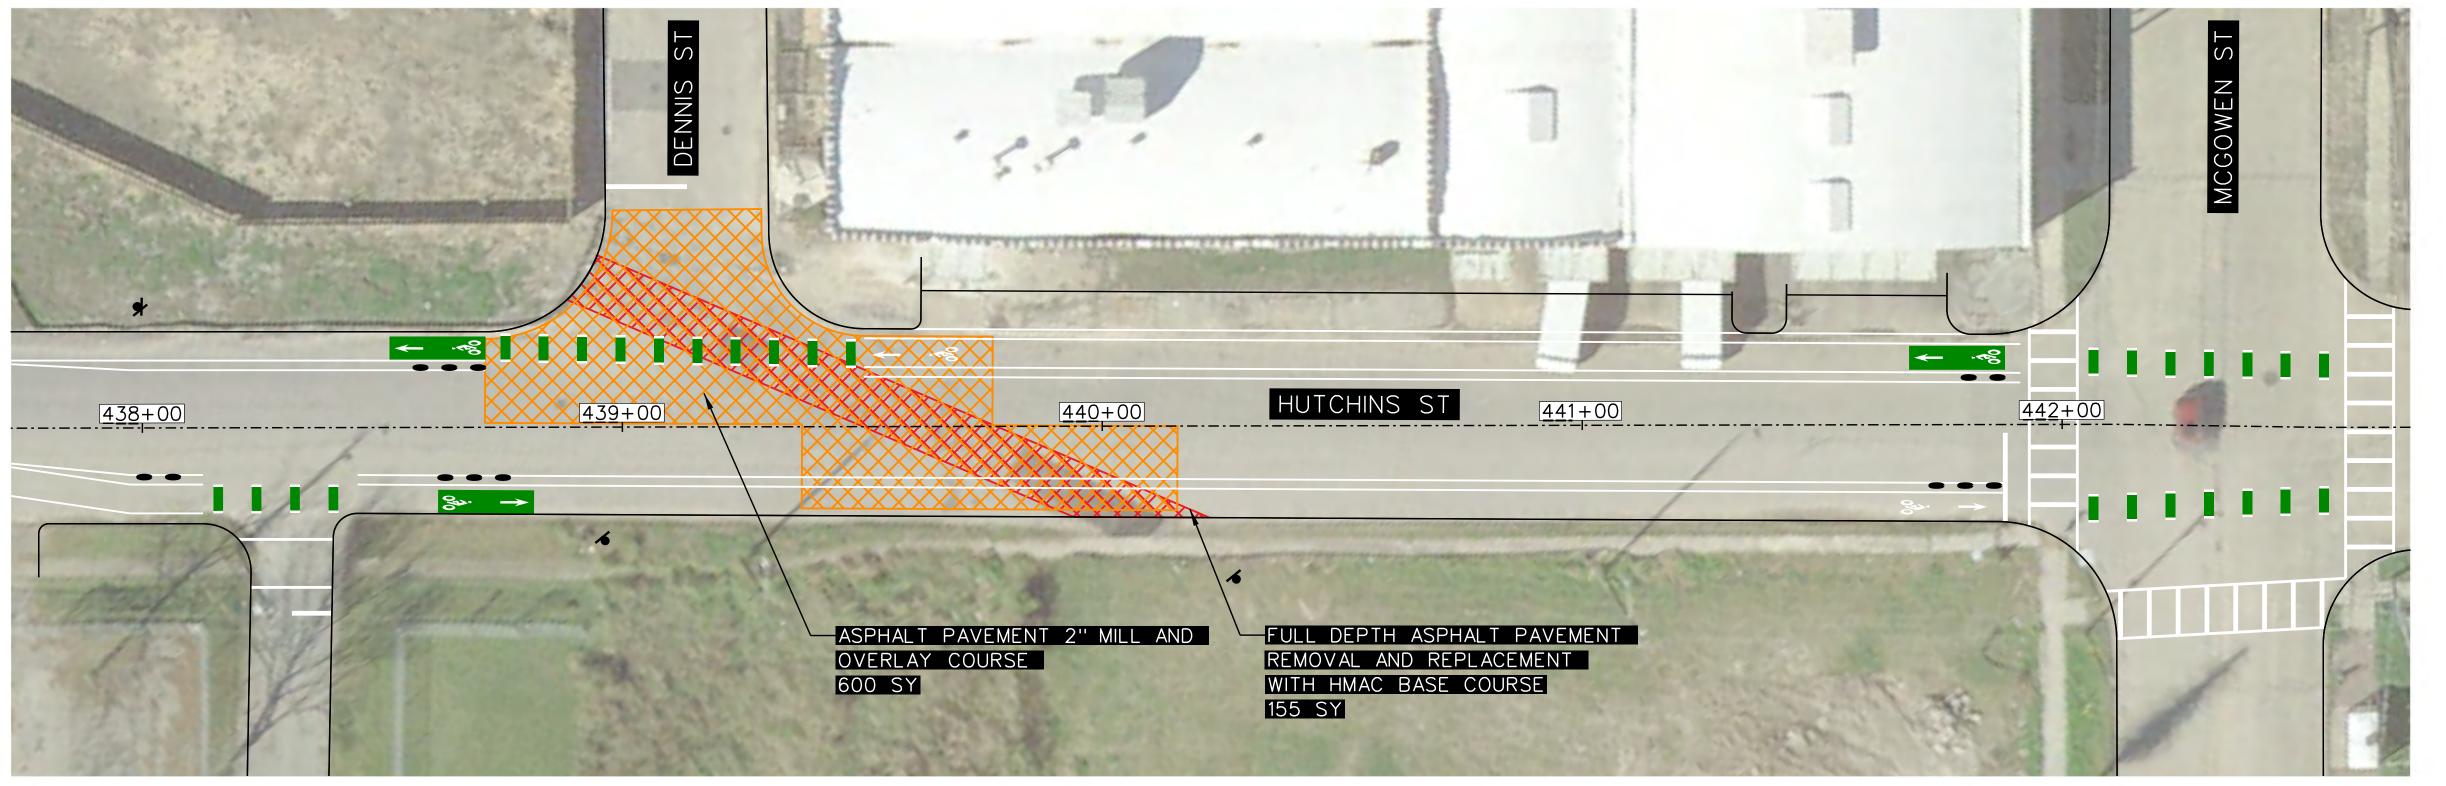

QUANTITIES (THIS SHEET ONLY)

290 SY FULL DEPTH REPAIR/REPLACEMENT OF CONCRETE PAVEMENT


CONCRETE SIDEWALK REMOVAL

870 SY 2" MILL AND OVERLAY OF ASPHALT PAVEMENT

155 SY FULL DEPTH ASHPHALT PAVEMENT REMOVAL AND REPLACEMENT WITH

HMAC BASE COURSE


261 LF CURB EXTENSION REMOVAL

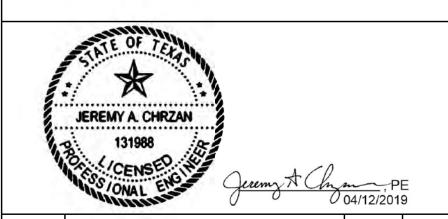

NO.	REVISIONS	DATE	NAME

TOOLE DESIGN

8484 Georgia Avenue, Suite 800, Silver Spring, MD 20910 TEL (301) 927-1900 TBPE Registration No. 14667

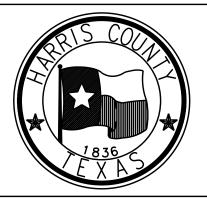

HARRIS COUNTY


ENGINEERING DEPARTMENT

PROJECT TITLE:	
HUTCHINS/CLEBURNE STREETS ON-STREET BIKEWAY	
	SHEET DESCRIPTION:
CB/FL	PAVING SHEETS
CK'D BY:	HUTCHINS ST PAVING REMOVAL AND REPAIR
JC	AT DENNIS ST AND TUAM ST
SCALE:	CUEET 1 OF 1
1"=20'	SHEET 1 OF 1
DATE:	APPROVED BY:
04/12/19	

SHEET NO:

402

DATE: 12-Apr-2019 04:44 PW:44:01 PM FILE: \\dca-file01\50000\5653.06_S_Third

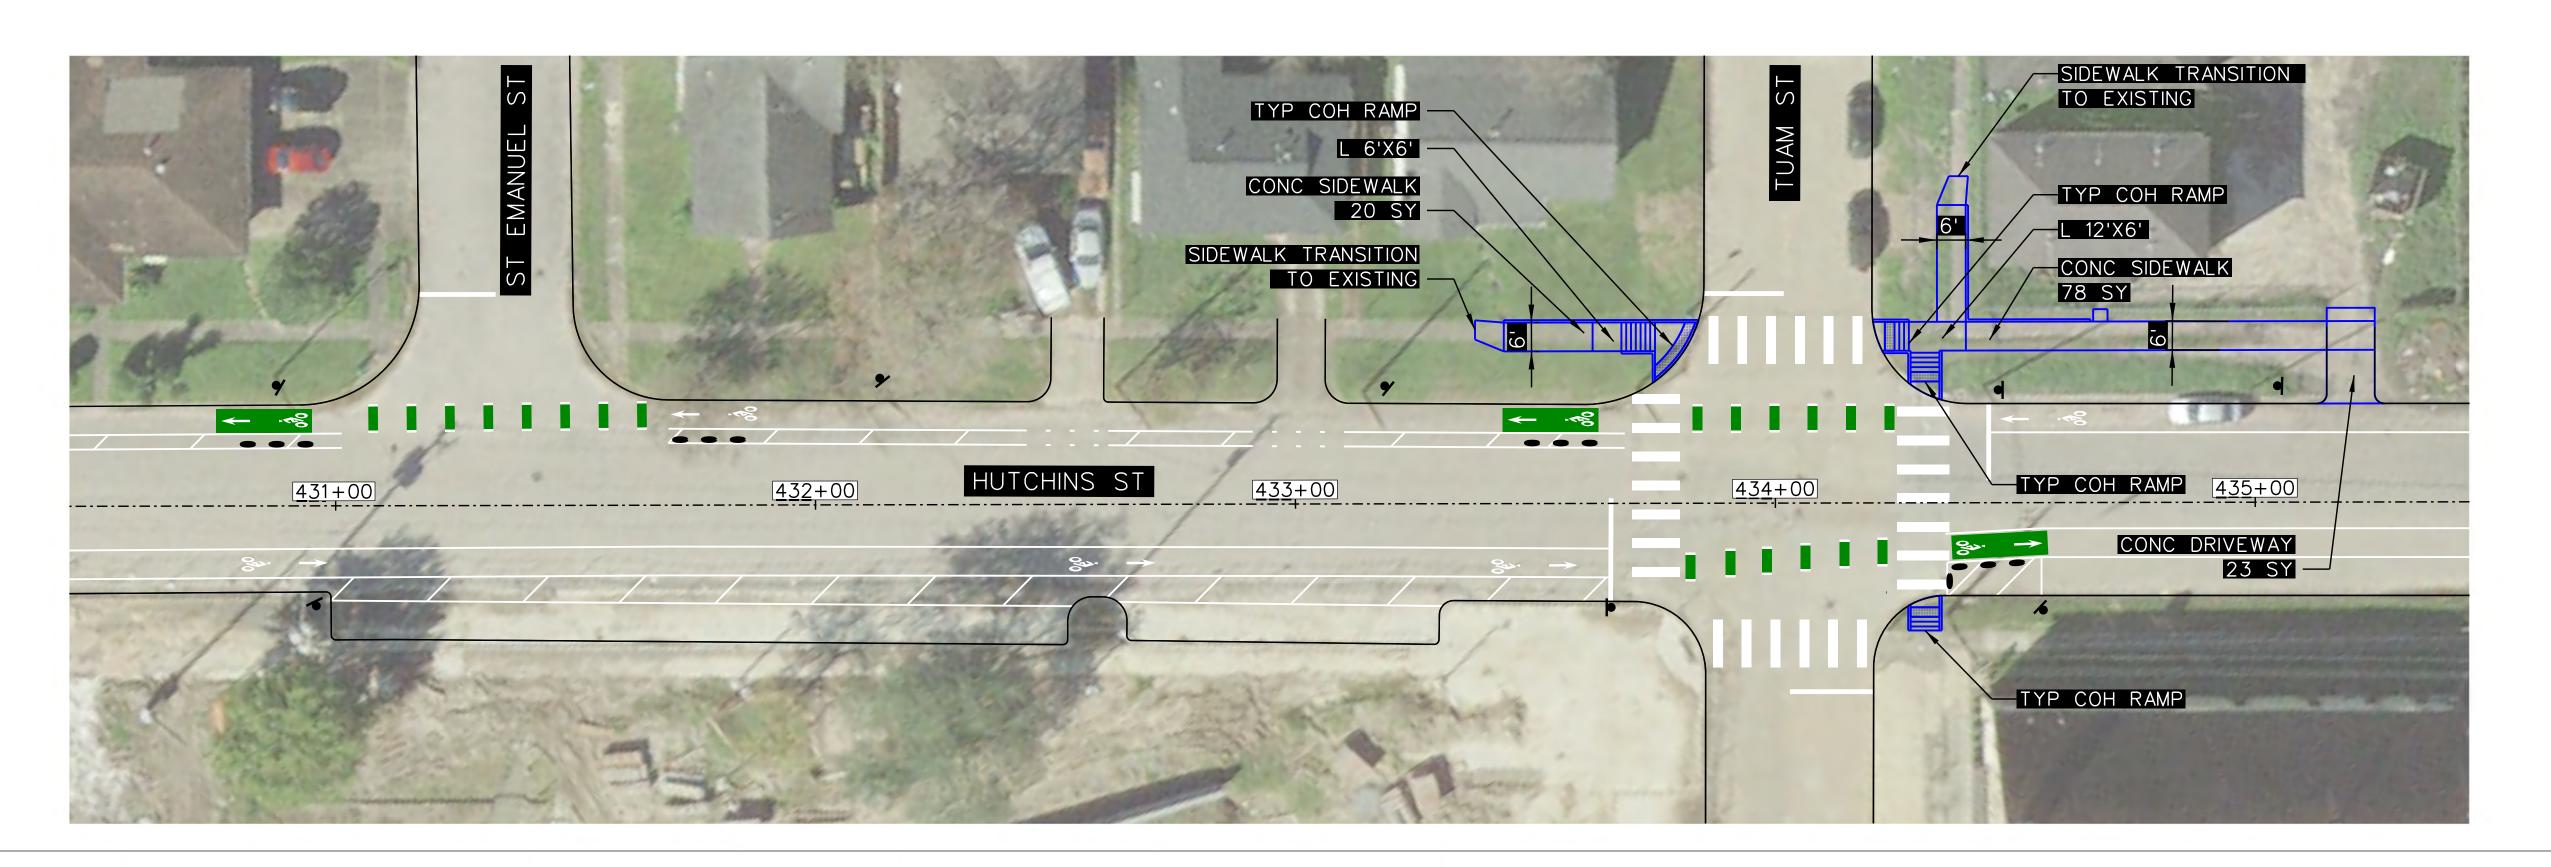



1. CURB RAMP LANDING AREAS MARKED "L" 2% MAX SLOPE FOR DRAINAGE

2. SEE SHEET 308 FOR SIDEWALK DETAILS.


3. SEE SHEET 309 FOR TYP COH RAMP DETAILS.


QUANTITIES (THIS SHEET ONLY)

CONCRETE SIDEWALK

CONCRETE CURB AND GUTTER

23 SY CONCRETE DRIVEWAY

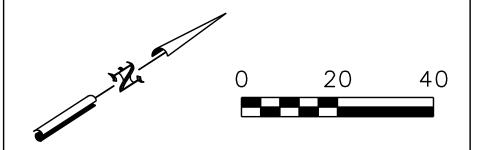


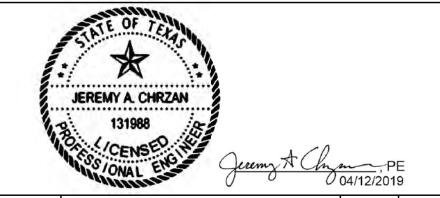

NO.	REVISIONS	DATE	NAME

TOOLE DESIGN


8484 Georgia Avenue, Suite 800, Silver Spring, MD 20910 TEL (301) 927-1900 TBPE Registration No. 14667

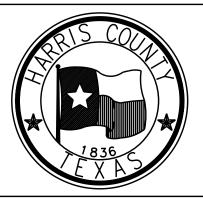


HARRIS COUNTY

ENGINEERING DEPARTMENT

PROJECT TITL HUTCHINS/(E: CLEBURNE STREETS ON—STR	EET BIKEWAY
DRAWN BY: CB/FL	SHEET DESCRIPTION: PAVING SHEETS	
CK'D BY: JC	HUTCHINS ST PAVING LAYOUT AT DENNIS ST AND TUAM ST	
SCALE: 1"=20'	SHEET 1 OF 1	
DATE: 04/12/19	APPROVED BY:	
		SHEET NO: 403

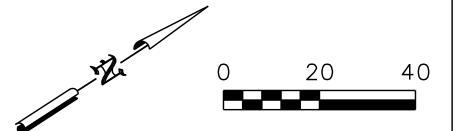

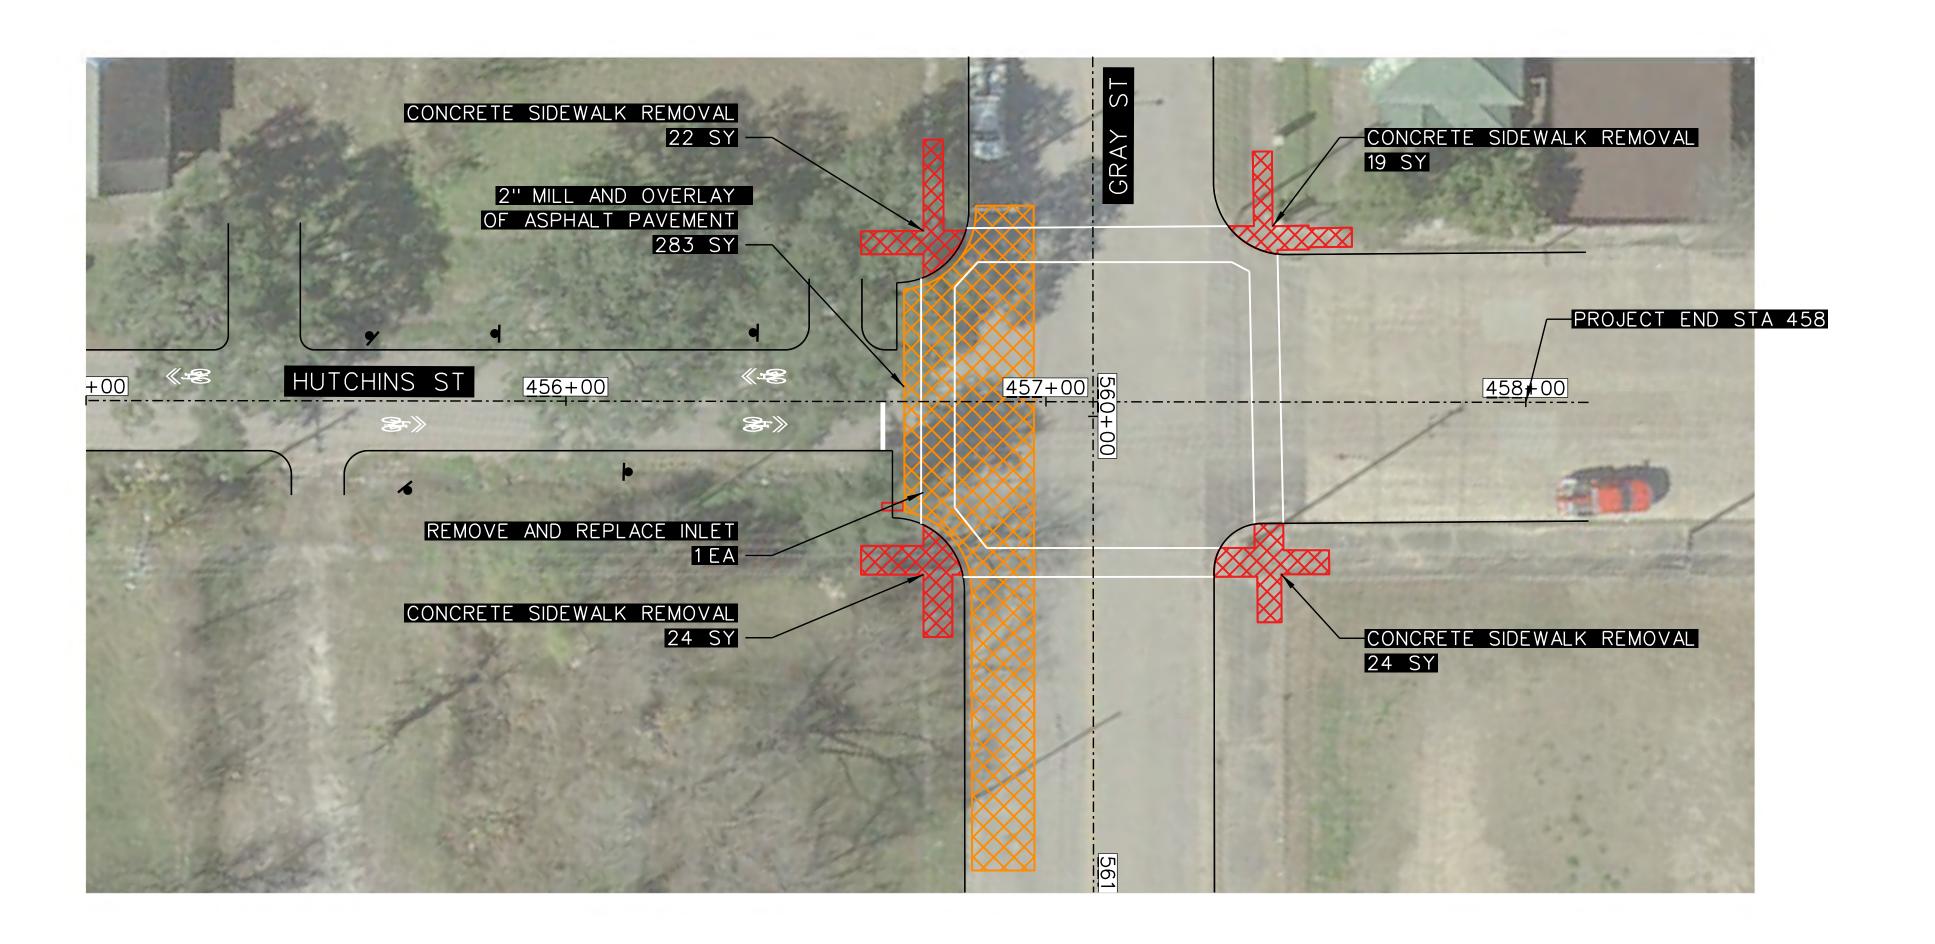


QUANTITIES (THIS SHEET ONLY)

283 SY 2" MILL AND OVERLAY OF ASPHALT PAVEMENT

89 SY CONCRETE SIDEWALK REMOVAL


REMOVE AND REPLACE INLET

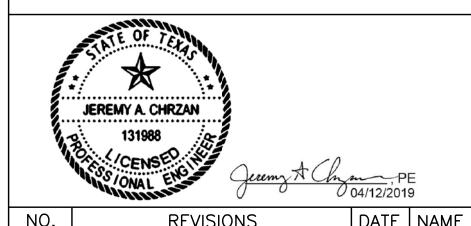

110.	INLVISIONS	בו	14KIVIL	

TOOLE DESIGN

8484 Georgia Avenue, Suite 800, Silver Spring, MD 20910 TEL (301) 927-1900 TBPE Registration No. 14667

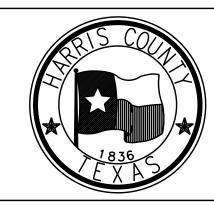

HARRIS COUNTY ENGINEERING DEPARTMENT


PROJECT TITLE:
HUTCHINS/CLEBURNE STREETS ON-STREET BIKEWAY
DRAWN BY: SHEET DESCRIPTION:
CB/FL PAVING SHEETS

CK'D BY: HUTCHINS ST PAVING REMOVAL AND REPAIR
JC AT GRAY ST

SCALE:
1"=20' SHEET 1 OF 1

DATE: APPROVED BY: 04/12/19

SHEET NO: 404

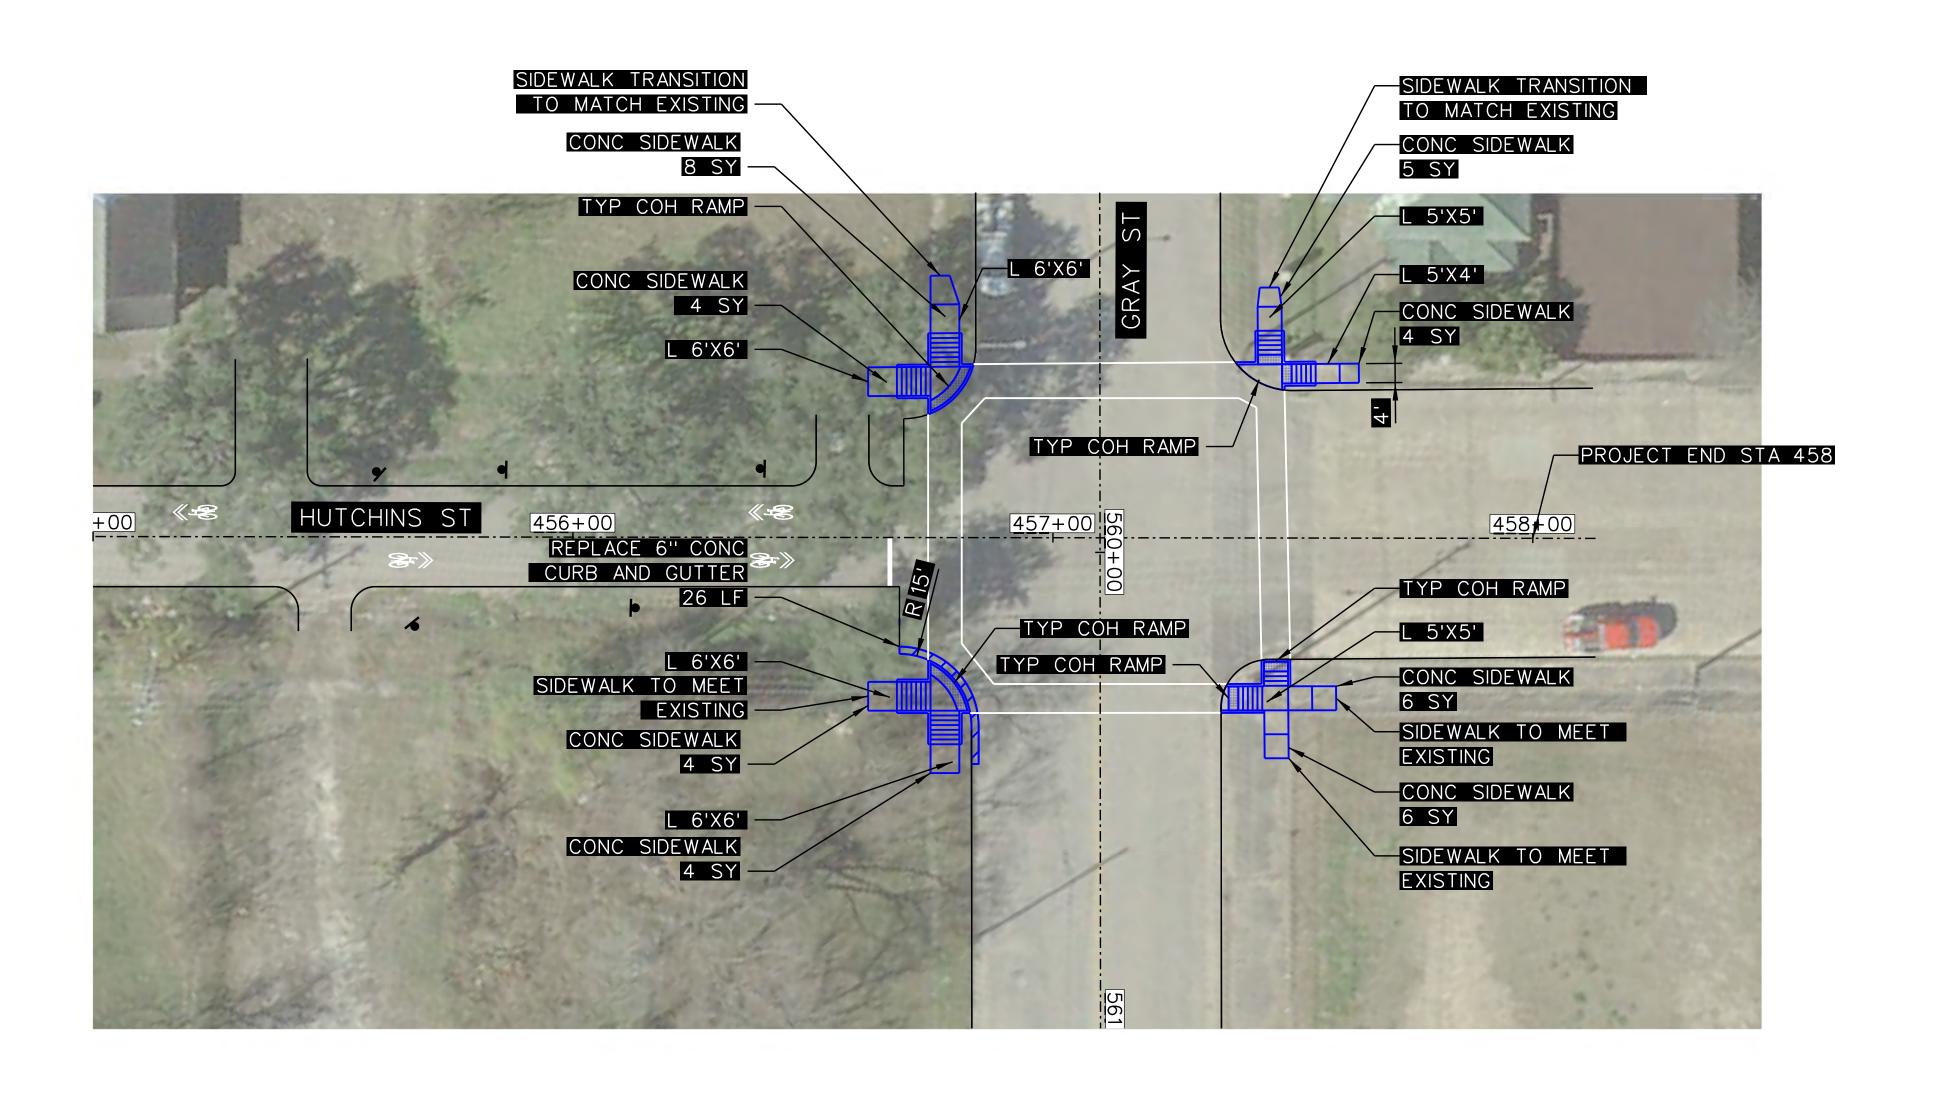

QUANTITIES (THIS SHEET ONLY)

CONCRETE SIDEWALK 41 SY


CONCRETE CURB AND GUTTER 26 LF

NOTES:

1. CURB RAMP LANDING AREAS MARKED "L" 2% MAX SLOPE FOR DRAINAGE

2. SEE SHEET 308 FOR SIDEWALK DETAILS.

3. SEE SHEET 309 FOR TYP COH RAMP DETAILS.

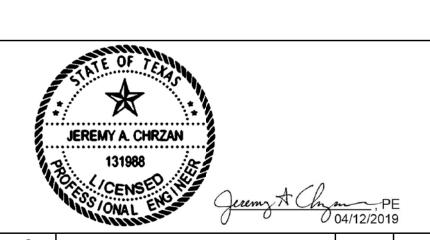

NO.	REVISIONS	DATE	NAME	

TOOLE DESIGN

8484 Georgia Avenue, Suite 800, Silver Spring, MD 20910 TEL (301) 927-1900 TBPE Registration No. 14667



HARRIS COUNTY ENGINEERING DEPARTMENT

PROJECT TITLE:
HUTCHINS/CLEBURNE STREETS ON-STREET BIKEWAY
DRAWN BY: SHEET DESCRIPTION:
CB/FL PAVING SHEETS

CK'D BY:
HUTCHINS ST PAVING LAYOUT AT GRAY ST HUTCHINS ST PAVING LAYOUT AT GRAY ST SCALE: 1"=20' SHEET 1 OF 1 DATE: APPROVED BY:

SHEET NO:


405


04/12/19

177 SY CONRETE MEDIAN REMOVAL

395 SY CONCRETE PAVEMENT REMOVAL

39 SY CONCRETE SIDEWALK AND CURB RAMP REMOVAL

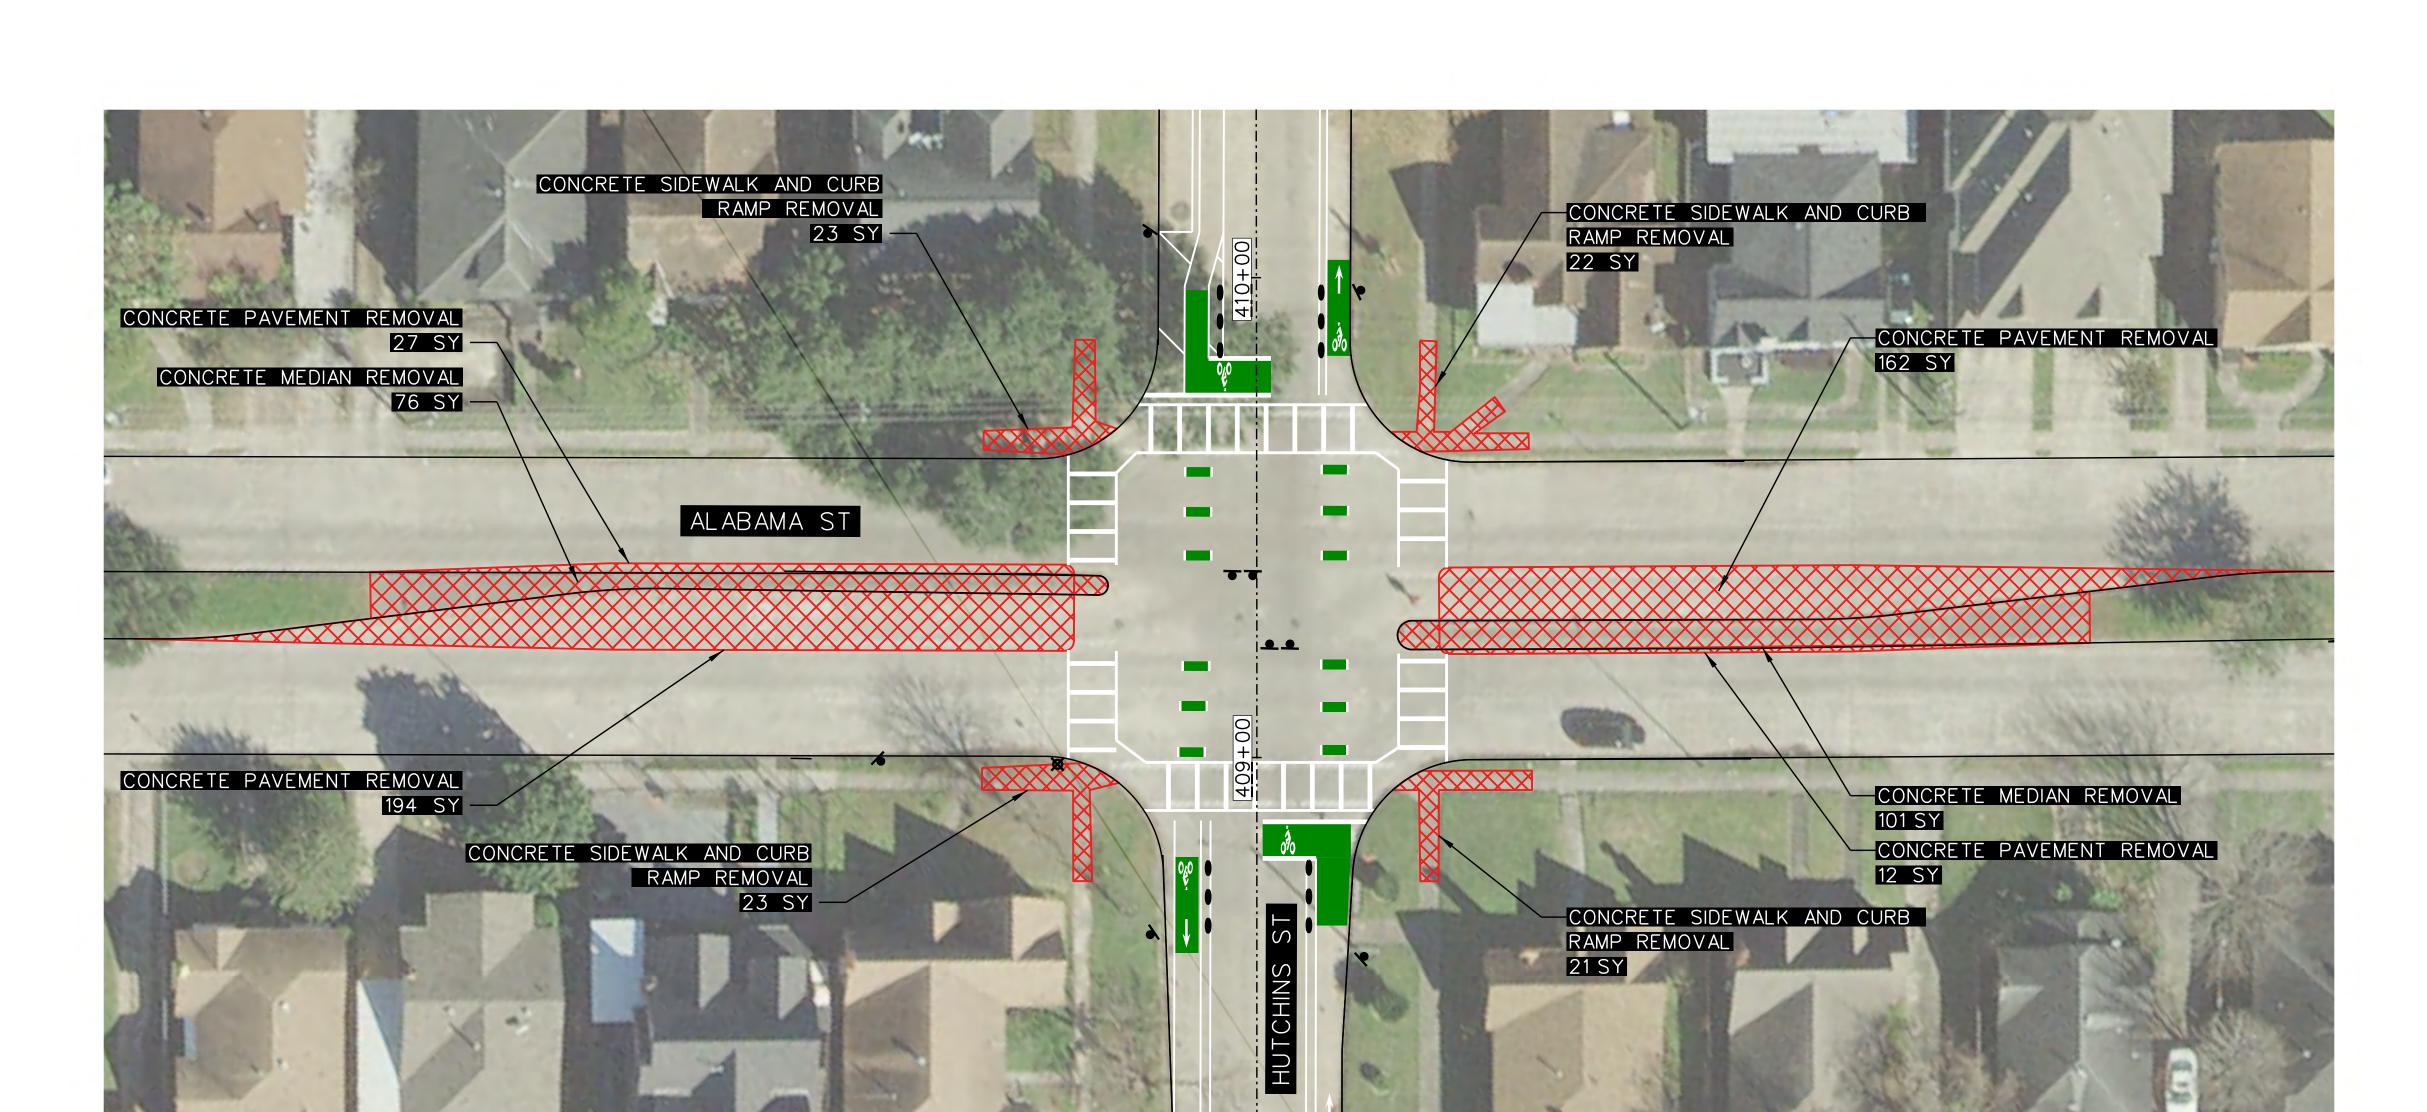


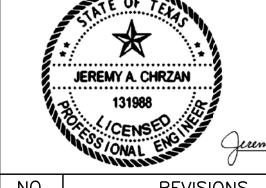

NO.	REVISIONS	DATE	NAME

100LE DESIGN

8484 Georgia Avenue, Suite 800, Silver Spring, MD 20910
TEL (301) 927-1900
TBPE Registration No. 14667

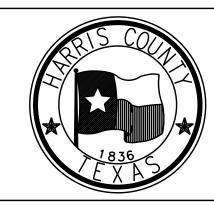

HARRIS COUNTY ENGINEERING DEPARTMENT

PROJECT TITLE:
HUTCHINS/CLEBURNE STREETS ON—STREET BIKEWAY
DRAWN BY: SHEET DESCRIPTION:
CB/FL PAVING SHEETS

CK'D BY: HUTCHINS ST PAVING REMOVAL AND REPAIR
JC AT ALABAMA ST

SCALE:
1"=20' SHEET 1 OF 1

1"=20' SHE

DATE: APPROVED BY:
04/12/19


SHEET NO: 406





1. CURB RAMP LANDING AREAS MARKED "L" 2% MAX SLOPE FOR DRAINAGE

2. SEE SHEET 308 FOR SIDEWALK DETAILS.

3. SEE SHEET 309 FOR TYP COH RAMP DETAILS.

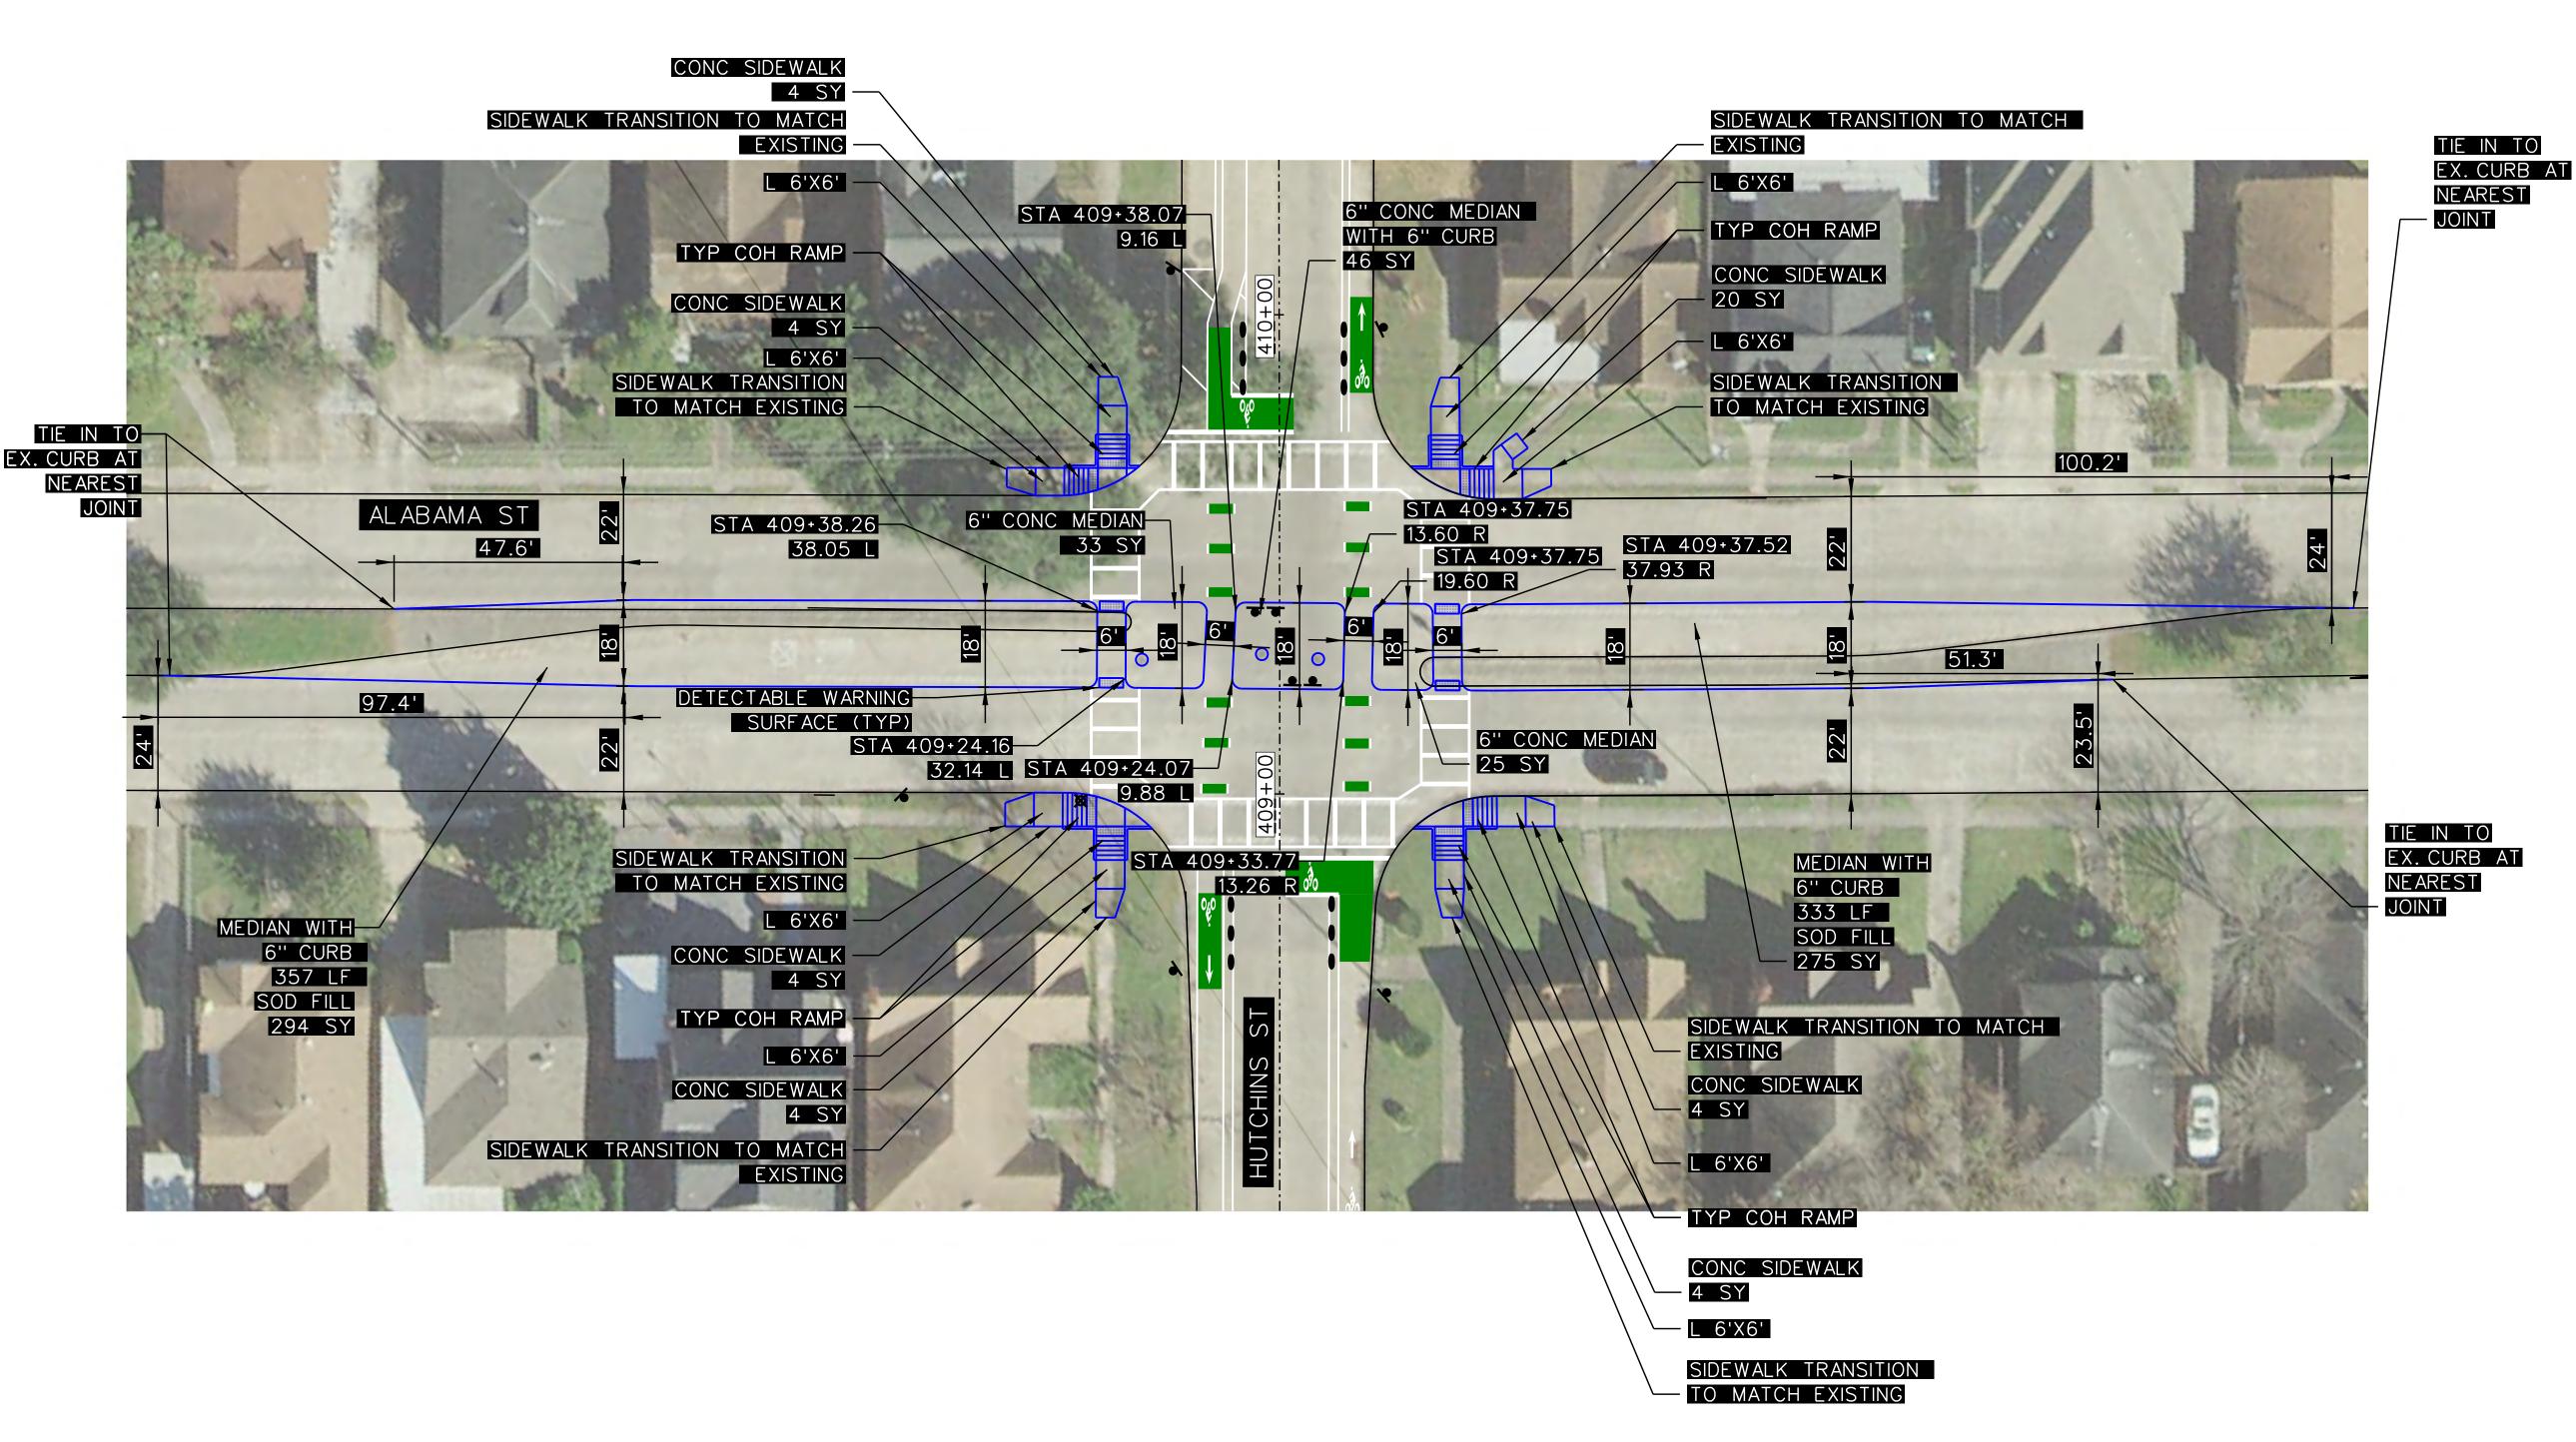

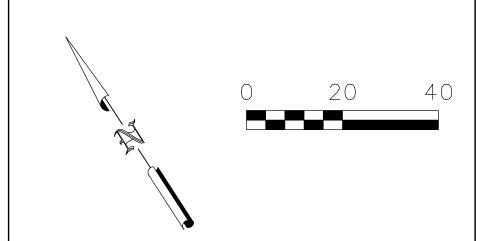


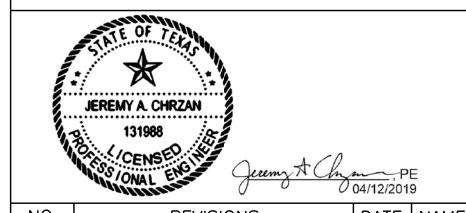

NO.	REVISIONS	DATE	NAME
	NO.	NO. REVISIONS	NO. REVISIONS DATE

TOOLE DESIGN

8484 Georgia Avenue, Suite 800, Silver Spring, MD 20910 TEL (301) 927-1900 TBPE Registration No. 14667

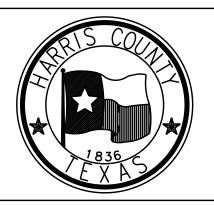

HARRIS COUNTY

ENGINEERING DEPARTMENT


QUANTITIES (THIS SHEET ONLY)


44 SY CONCRETE SIDEWALK

104 SY CONCRETE MEDIAN

569 SY SOD FILL

	CLEBURNE STREETS ON-STR	EET	BIKE	WAY
CB/FL	SHEET DESCRIPTION: PAVING SHEETS			
CK'D BY: JC	HUTCHINS ST PAVING LAYOUT AT ALABAMA ST			
SCALE: 1"=20'	SHEET 1 OF 1			
DATE:	APPROVED BY:			
04/12/19				
		SH	EET I	NO:
		40	7	

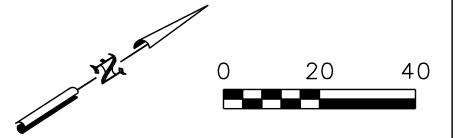

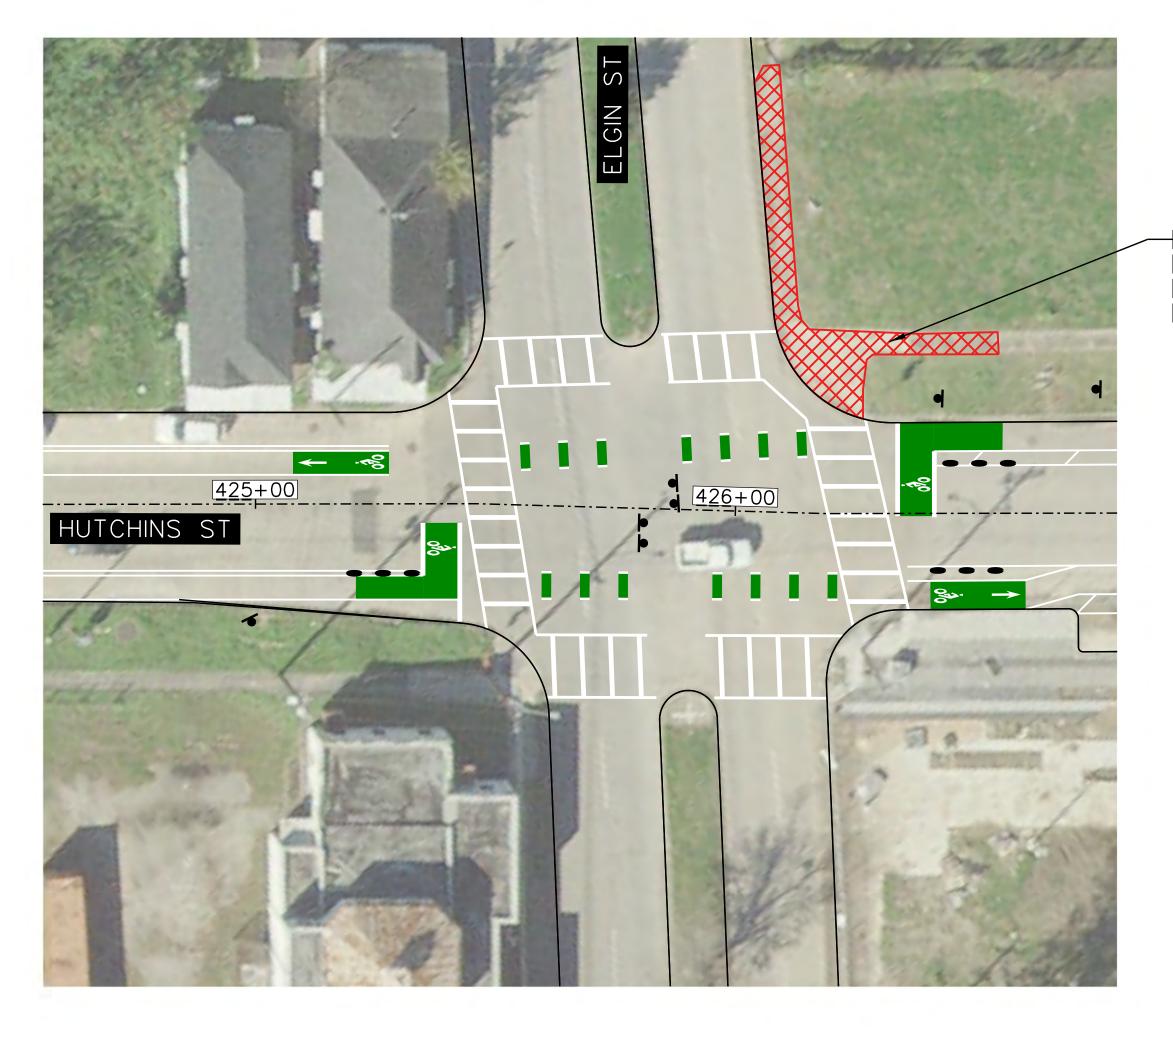


CONCRETE SIDEWALK AND CURB RAMP REMOVAL 73 SY

JEREMY A. CHRZAN DATE NAME **REVISIONS**

110.	INLVISIONS	בו	INAIVIL	

TOOLE DESIGN

8484 Georgia Avenue, Suite 800, Silver Spring, MD 20910 TEL (301) 927-1900 TBPE Registration No. 14667

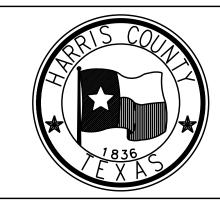

HARRIS COUNTY ENGINEERING DEPARTMENT

PROJECT TITLE:
HUTCHINS/CLEBURNE STREETS ON—STREET BIKEWAY
DRAWN BY: SHEET DESCRIPTION:
CB/FL PAVING SHEETS

CK'D BY: HUTCHINS ST PAVING REMOVAL AND REPAIR
AT ELGIN ST

SCALE:
1"=20' SHEET 1 OF 1

DATE: APPROVED BY:
04/12/19 04/12/19


SHEET NO:

408

QUANTITIES (THIS SHEET ONLY)

73 SY CONCRETE SIDEWALK AND CURB RAMP REMOVAL



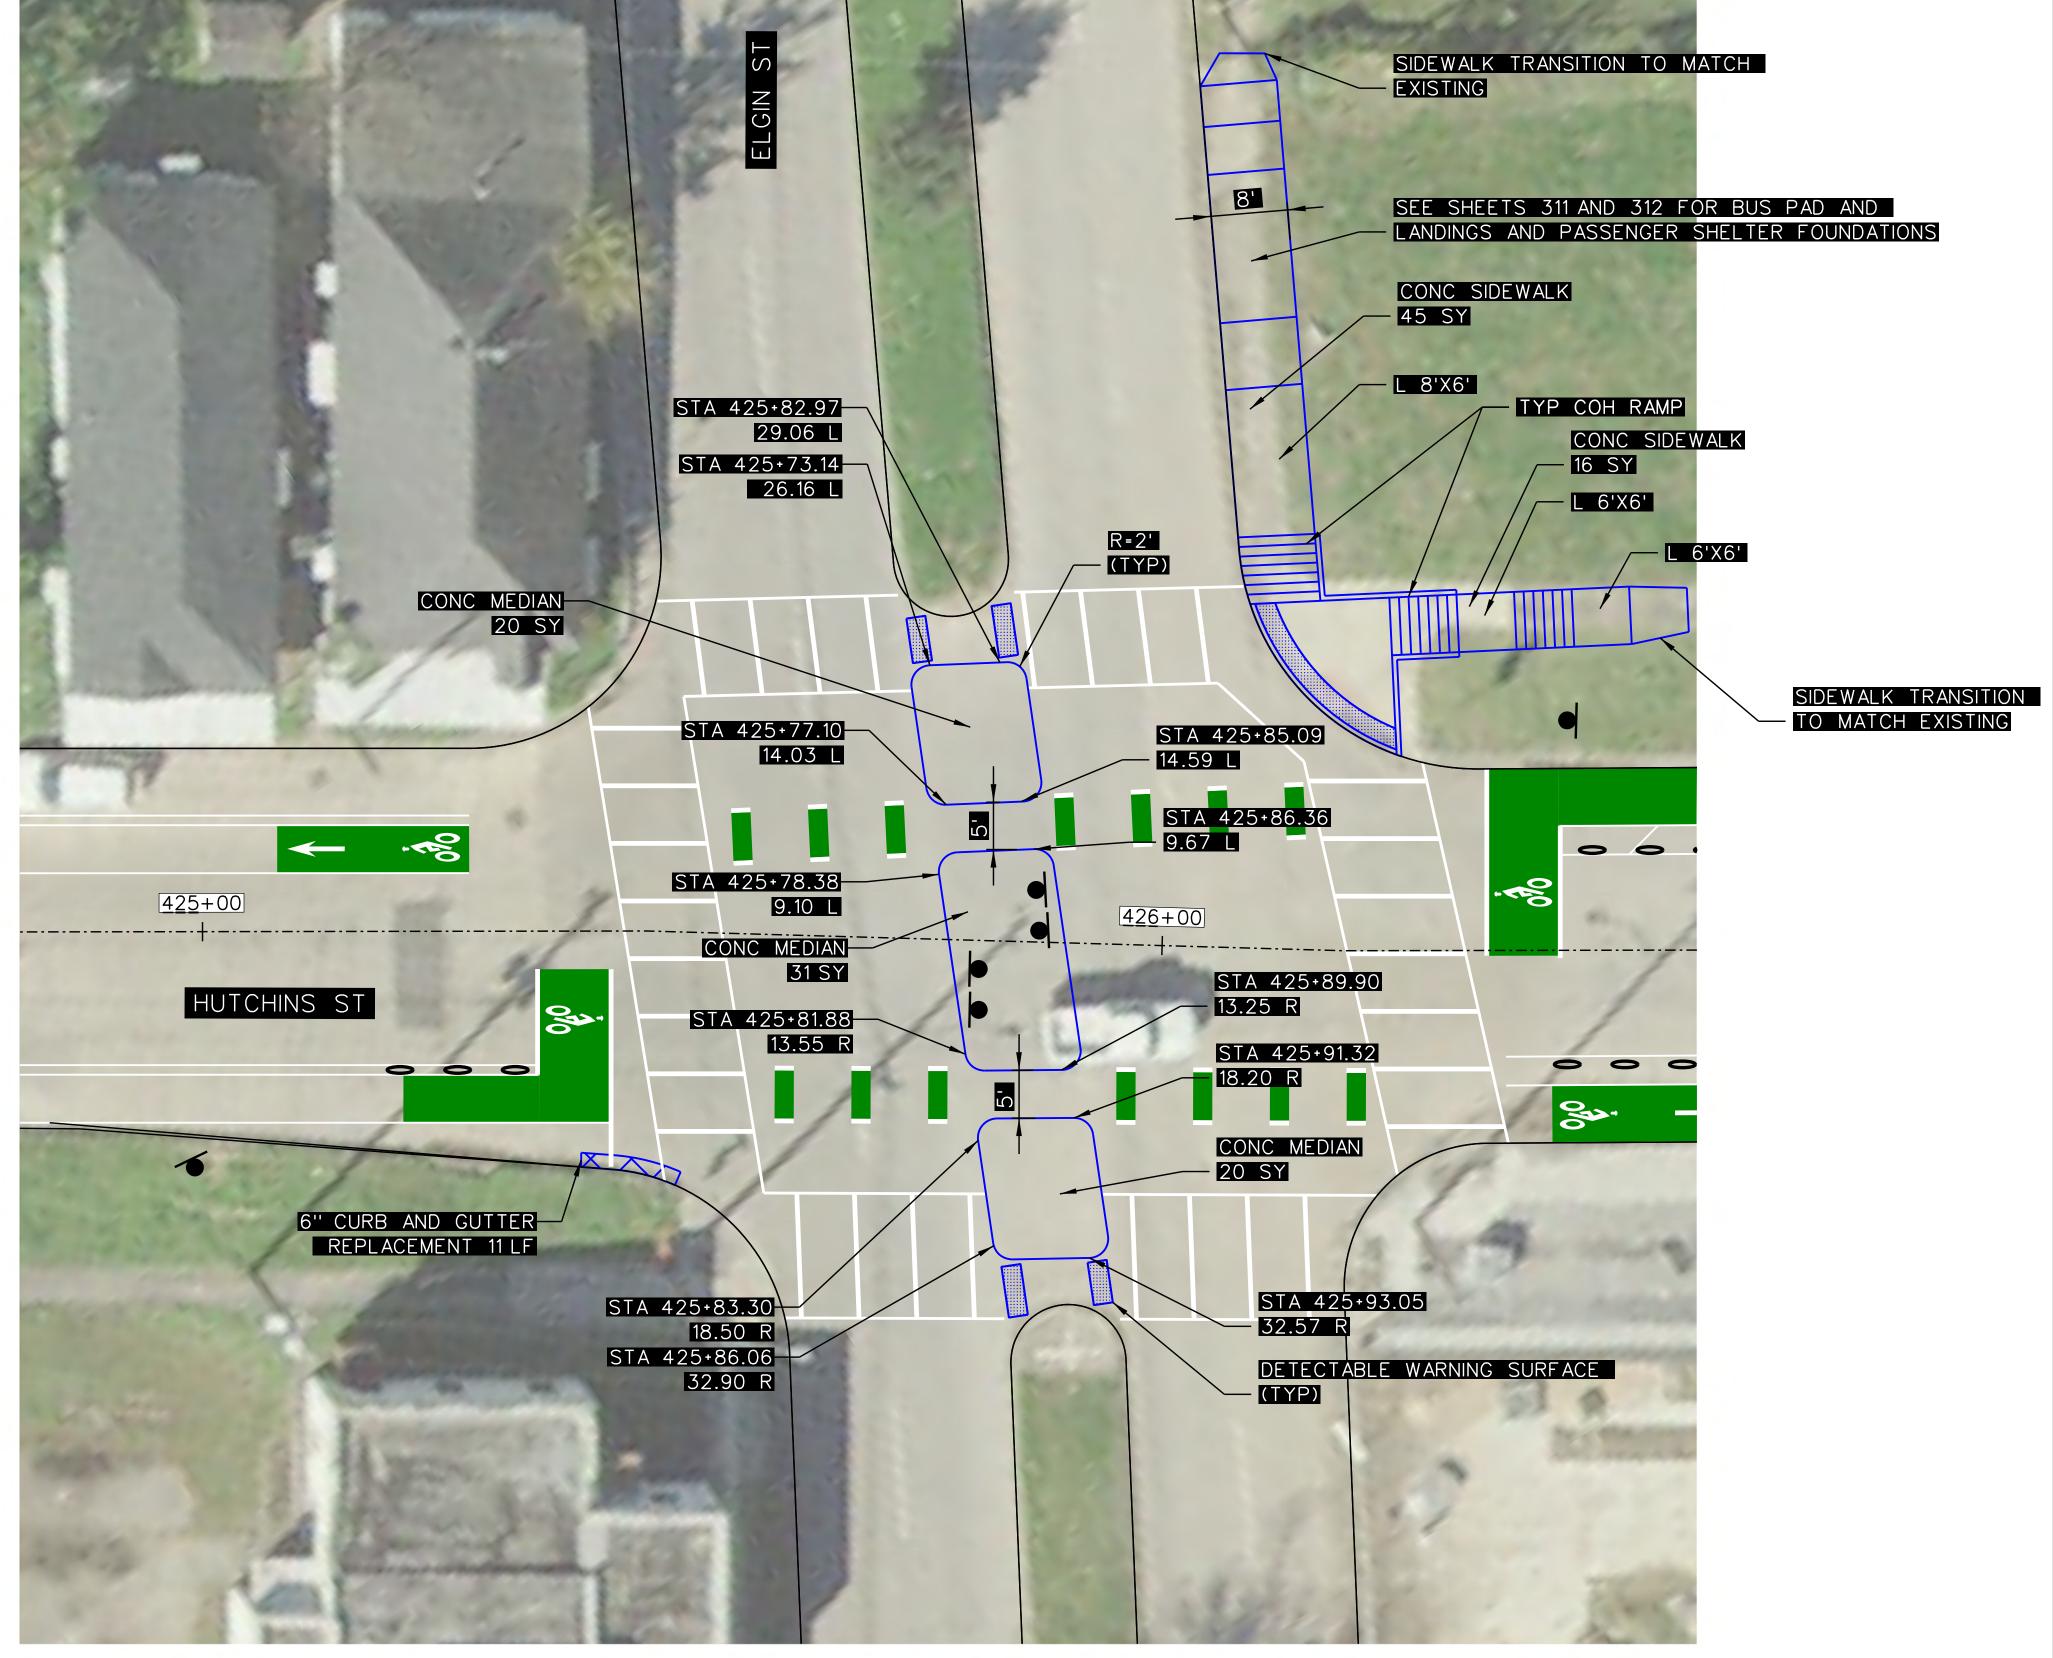


- 1. CURB RAMP LANDING AREAS MARKED "L" 2% MAX SLOPE FOR DRAINAGE
- 2. SEE SHEET 308 FOR SIDEWALK DETAILS.
- 3. SEE SHEET 309 FOR TYP COH RAMP DETAILS.


QUANTITIES (THIS SHEET ONLY)

CONCRETE SIDEWALK 61 SY

51 SY CONCRETE MEDIAN

11 LF CURB AND GUTTER REPLACEMENT

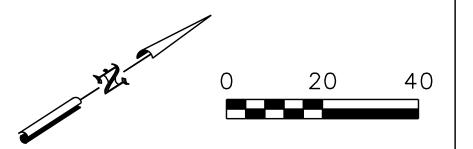

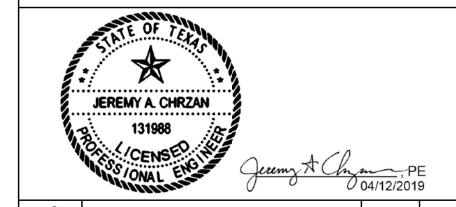

NO.	REVISIONS	DATE	NAME

TOOLE DESIGN


8484 Georgia Avenue, Suite 800, Silver Spring, MD 20910 TEL (301) 927-1900 TBPE Registration No. 14667



HARRIS COUNTY ENGINEERING DEPARTMENT

PROJECT TITL			
	CLEBURNE STREETS ON-STR	EET BIKE	EWAY
	SHEET DESCRIPTION:		
CB/FL	PAVING SHEETS		
CK'D BY:	HUTCHINS ST PAVING LAYOUT		
JC	AT ELGIN ST		
SCALE:	SHEET 1 OF 1	<u> </u>	
1"=10'			
DATE:	APPROVED BY:		
04/12/19			
		SHEET	NO:

409

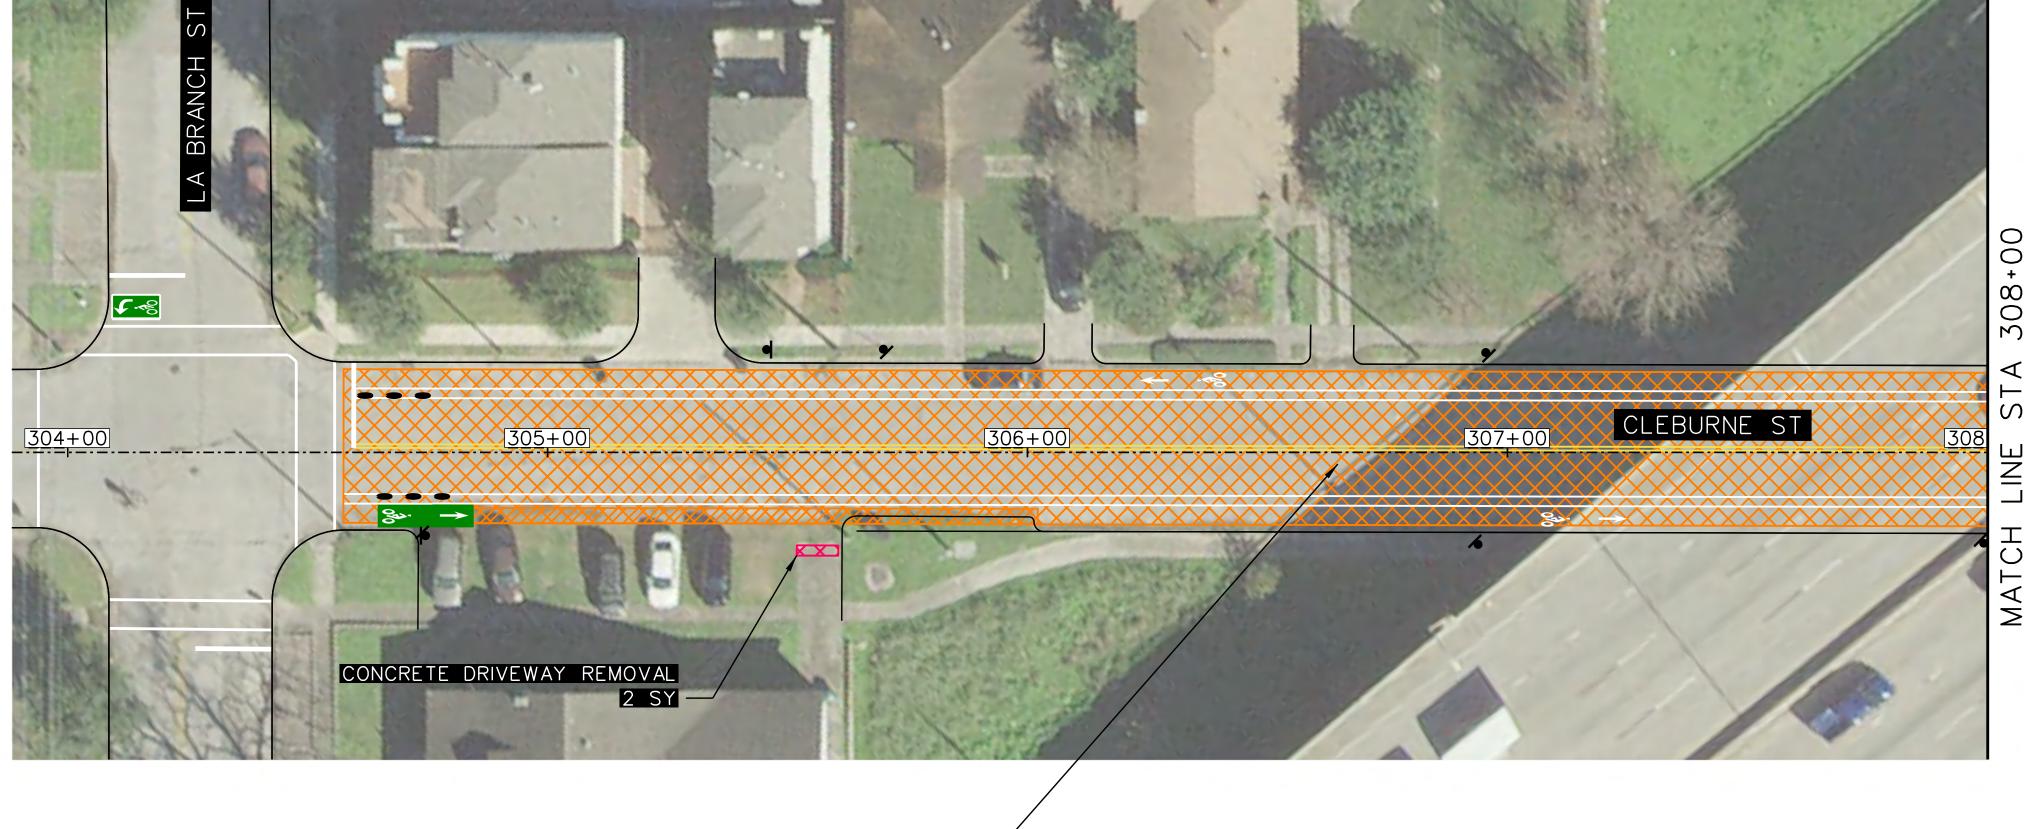

2" MILL AND OVERLAY
REPAIR/REPLACEMENT OF ASPHALT
PAVEMENT
2027 SF THIS SHEET

QUANTITIES (THIS SHEET ONLY)

2027 SY 2" MILL AND OVERLAY REPAIR/REPLACEMENT OF ASPHALT PAVEMENT

116 SY CONCRETE SIDEWALK REMOVAL


2 SY CONCRETE DRIVEWAY REMOVAL


1240 LF STREET LOOP WIRE (14 AWG IMSA 51-5-1985)

144 LF LOOP DETECTOR SAW CUT


NOTE:

1. A 6'X 20'PRESENCE DETECTION ZONE SHALL CONSIST OF ONE (1) 6'X 6'DETECTOR LOOP PLACED IN EACH LANE BEGINNING AT THE STOP LINE, AND ONE (1) 6'X 10'DETECTOR LOOP PLACED 4 FEET UPSTREAM OF THE TRAILING EDGE OF THE FIRST DETECTOR.

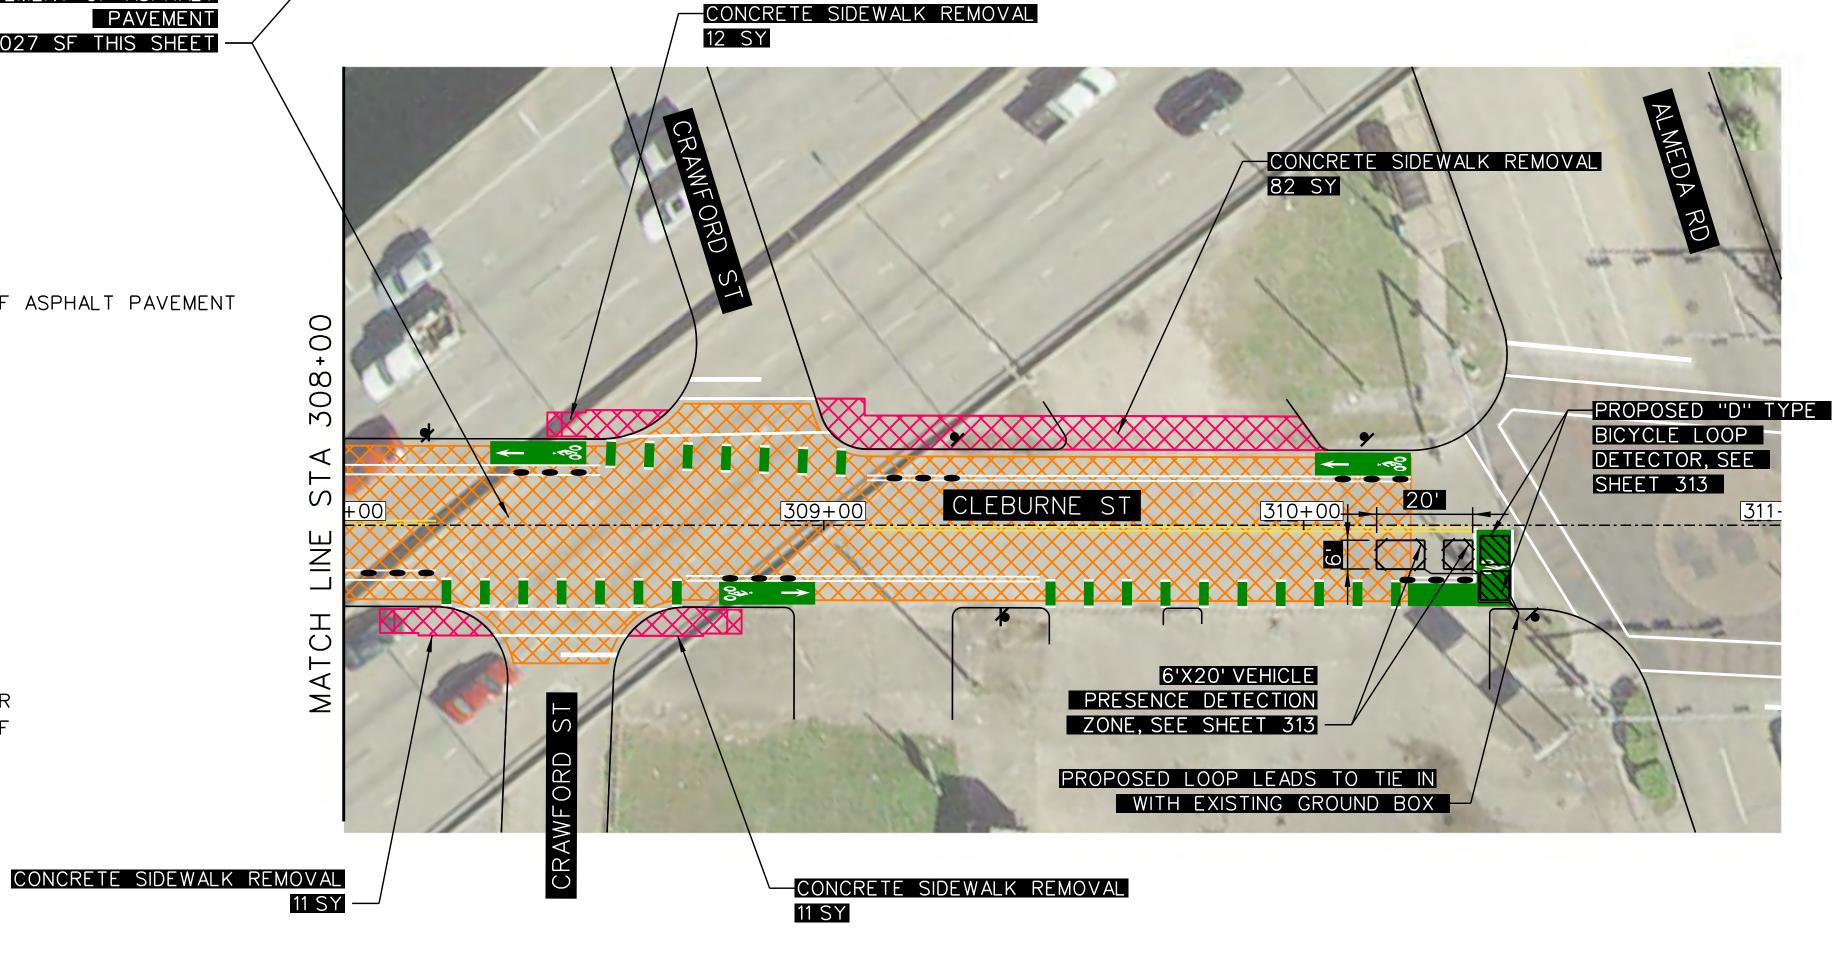

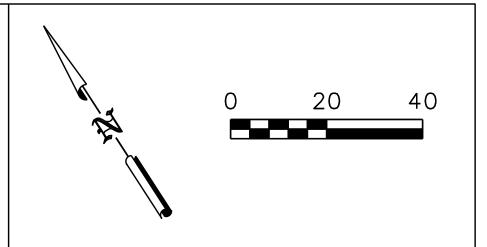




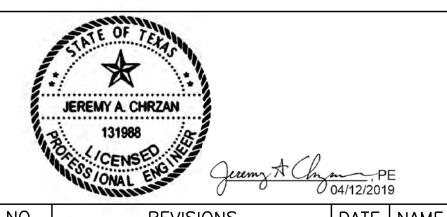

NO.	REVISIONS	DAIL	NAME

TOOLE DESIGN


8484 Georgia Avenue, Suite 800, Silver Spring, MD 20910
TEL (301) 927-1900
TBPE Registration No. 14667

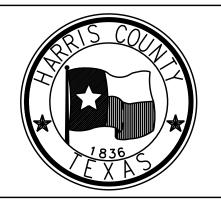


HARRIS COUNTY


ENGINEERING DEPARTMENT


DRAWN BY: CB/FL	CLEBURNE STREETS ON-STR SHEET DESCRIPTION: PAVING SHEETS	<u>eei dinewa</u>
CK'D BY: JC	CLEBURNE ST PAVING REMOVA BETWEEN LA BRANCH ST AND	L AND REPAII ALMEDA ST
SCALE: 1"=20'	SHEET 1 OF 1	
DATE: 04/12/19	APPROVED BY:	
		SHEET NO:

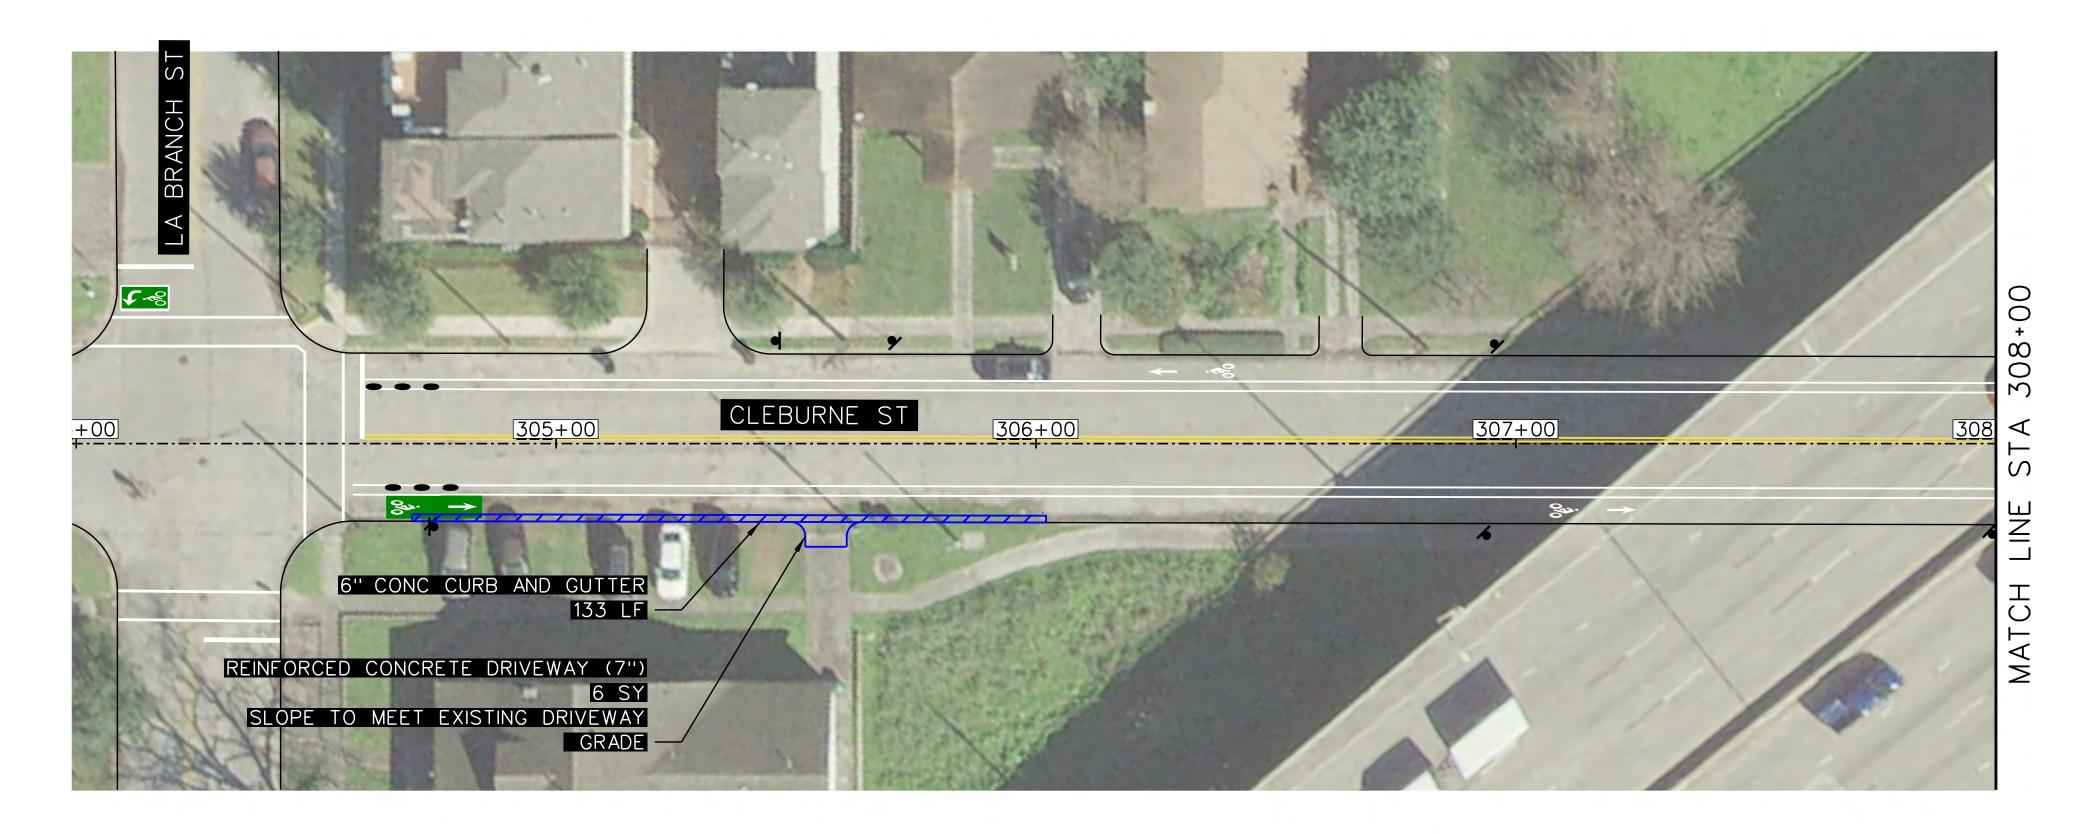


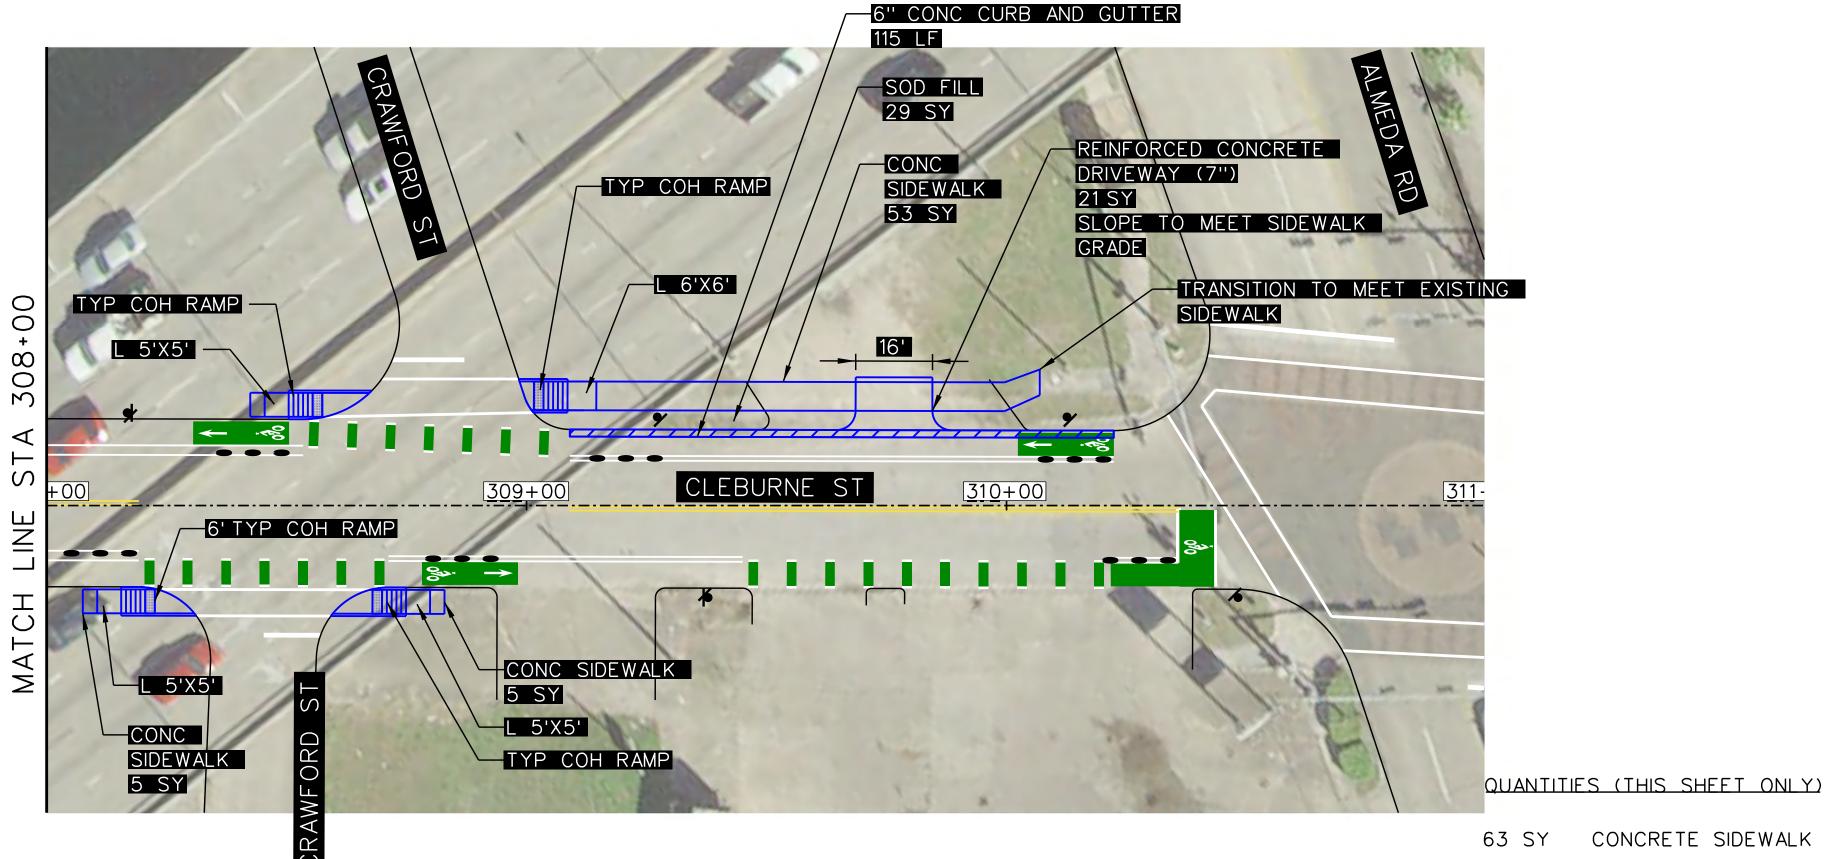

- 1. CURB RAMP LANDING AREAS MARKED "L" 2% MAX SLOPE FOR DRAINAGE
- 2. SEE SHEET 308 FOR SIDEWALK DETAIL
- 3. SEE SHEET 309 FOR 6' TYP COH RAMP DETAIL

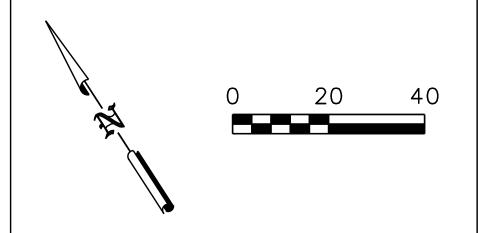

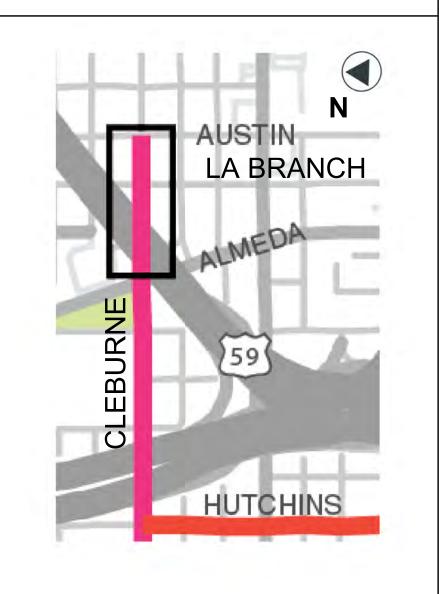

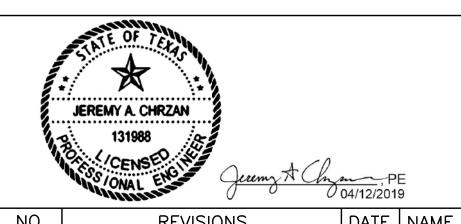

140.	KEVISIONS	בואט	INAME	

TOOLE DESIGN

8484 Georgia Avenue, Suite 800, Silver Spring, MD 20910 TEL (301) 927-1900 TBPE Registration No. 14667



HARRIS COUNTY

ENGINEERING DEPARTMENT DRO IECT TITLES

PROJECT TITLE:						
HUTCHINS/0	HUTCHINS/CLEBURNE STREETS ON-STREET BIKEWAY					
DRAWN BY:	SHEET DESCRIPTION:					
CB/FL	PAVING SHEETS					
CK'D BY:	CLEBURNE ST PAVING LAYOUT	BETWEEN				
JC JC	JC LA BRANCH ST AND ALMEDA ST					
SCALE:	CUEET 1 OF 1					
1"=20'	SHEET 1 OF 1					
DATE: APPROVED BY:						
04/12/19						
		SHEET NO:				
		411				
I						


CONCRETE SIDEWALK


REINFORCED CONCRETE DRIVEWAY

250 LF CONCRETE CURB AND GUTTER

29 SY SOD FILL




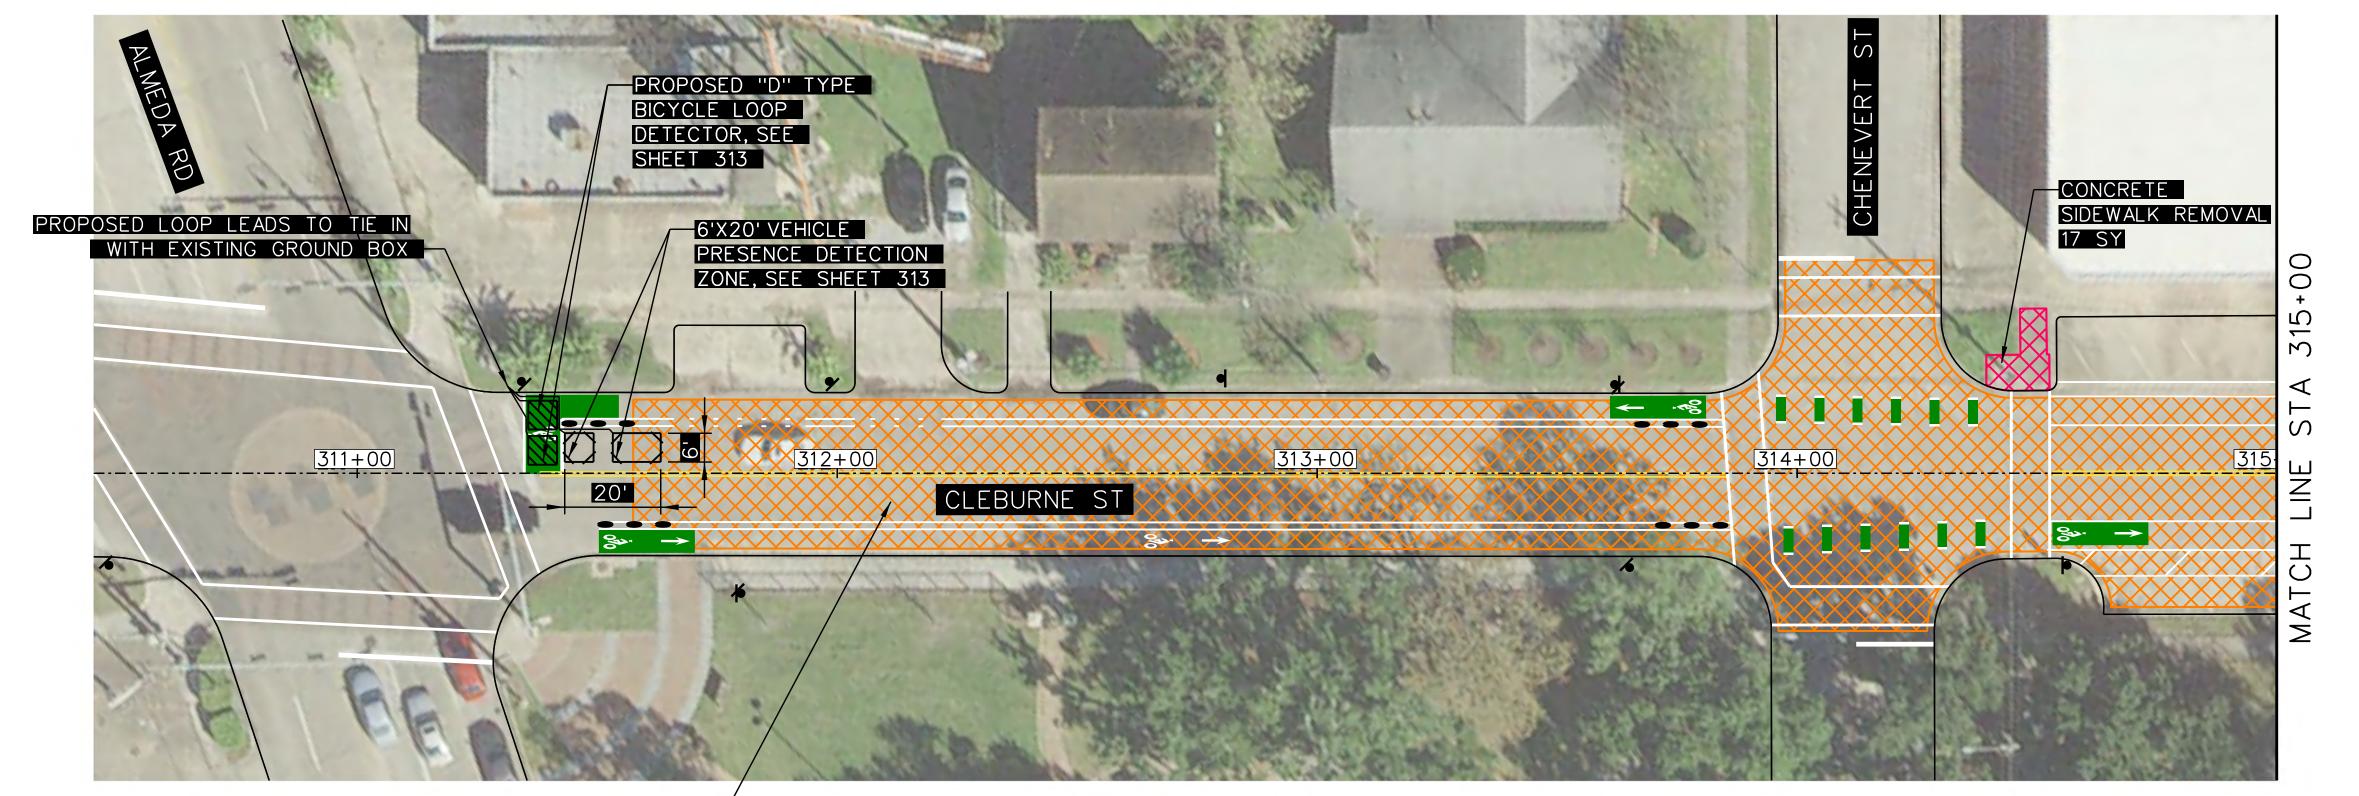

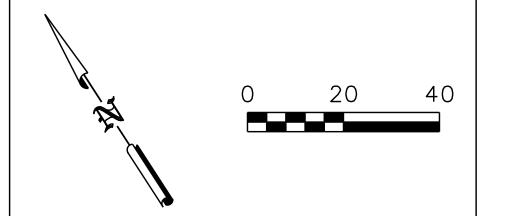



2" MILL AND OVERLAY REPAIR/REPLACEMENT OF ASPHALT PAVEMENT 3814 SY THIS SHEET

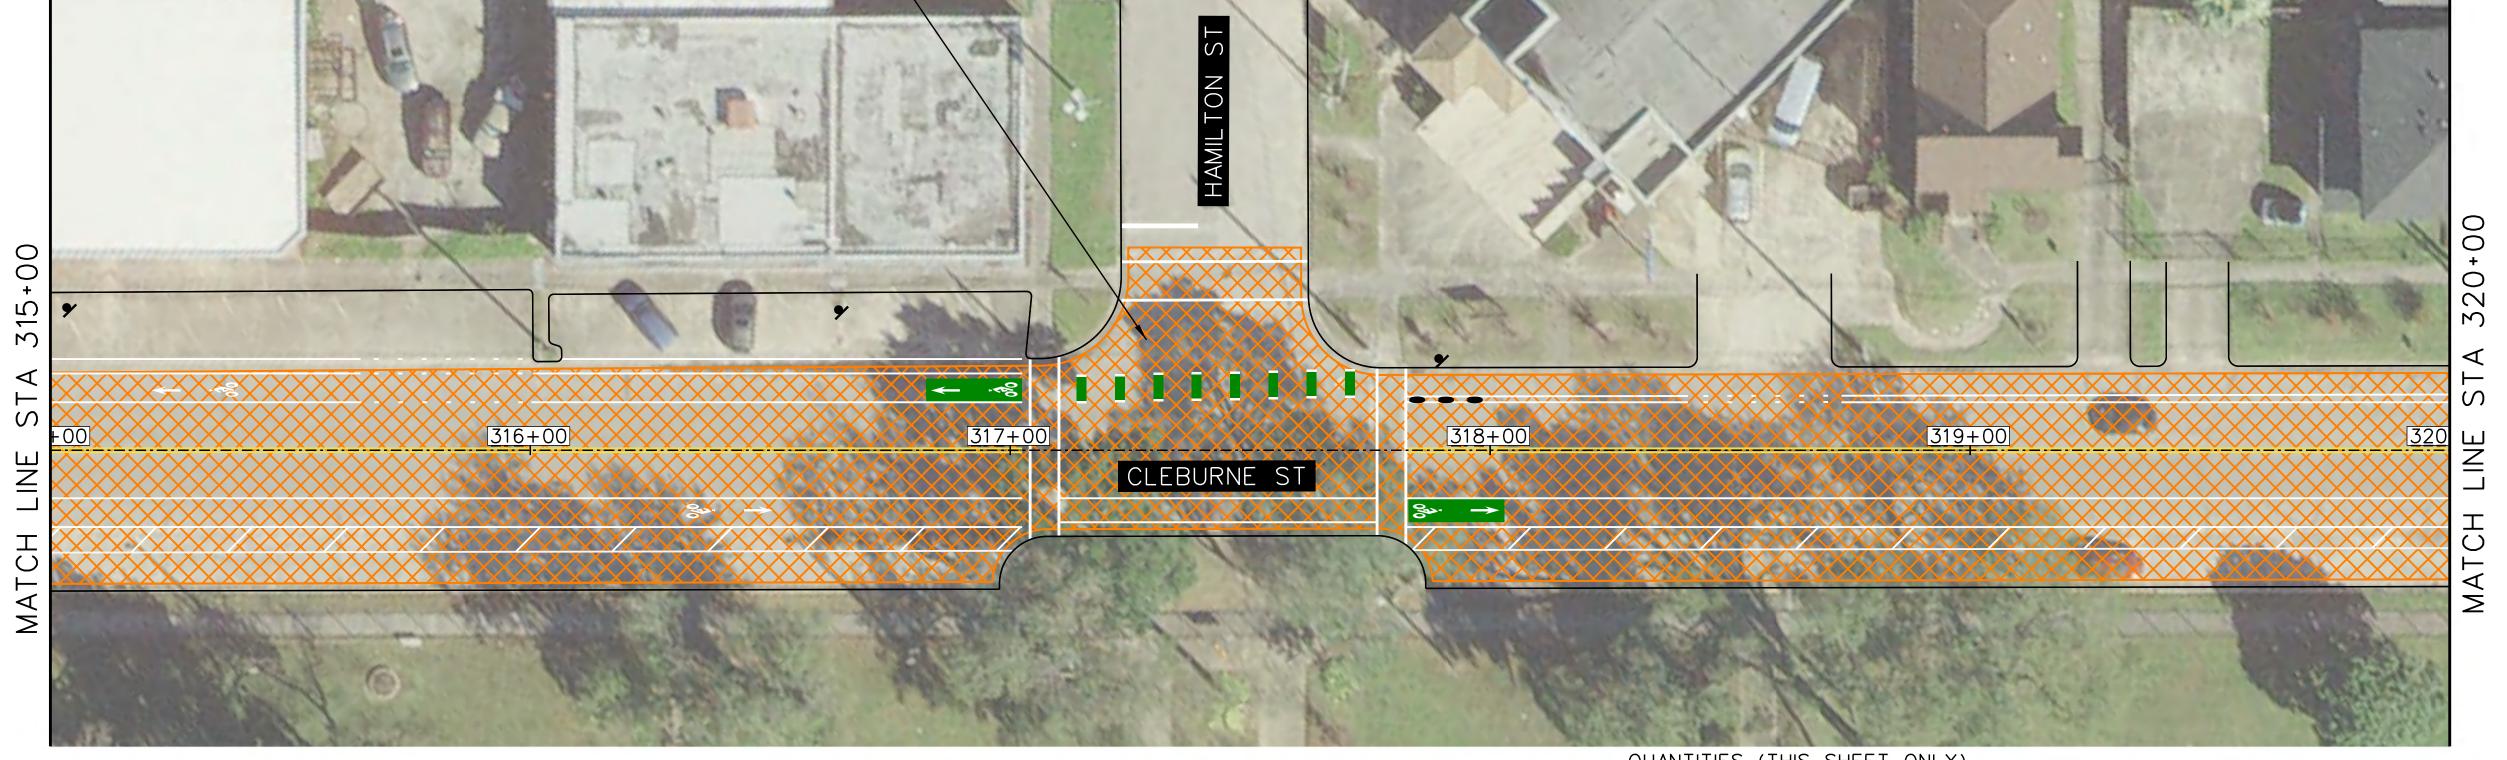

NOTE:

1. A 6'X 20'PRESENCE DETECTION ZONE SHALL CONSIST OF ONE (1) 6' X 6' DETECTOR LOOP PLACED IN EACH LANE BEGINNING AT THE STOP LINE, AND ONE (1) 6' X 10' DETECTOR LOOP PLACED 4 FEET UPSTREAM OF THE TRAILING EDGE OF THE FIRST DETECTOR.

QUANTITIES (THIS SHEET ONLY)

3814 SY 2" MILL AND OVERLAY REPAIR/REPLACEMENT OF ASPHALT PAVEMENT

CONCRETE SIDEWALK REMOVAL

744 LF STREET LOOP WIRE (14 AWG IMSA 51-5-1985)


144 LF LOOP DETECTOR SAW CUT

No.	JEREMY A. CHRZAN			
	131988 CENSED	Jeremy A.C.	lny	 E 9
	חבייוכו	ONC		L N L A N A

NO.	REVISIONS	DATE	NAME	

TOOLE DESIGN

8484 Georgia Avenue, Suite 800, Silver Spring, MD 20910 TEL (301) 927-1900 TBPE Registration No. 14667

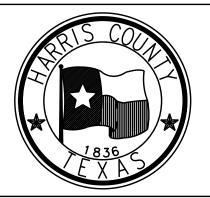



HARRIS COUNTY


ENGINEERING DEPARTMENT


PROJECT TITL		EET DUZEMAN
	CLEBURNE STREETS ON-STR	FFI BIKEWAY
DRAWN_BY:	SHEET DESCRIPTION:	
CB/FL	PAVING SHEETS	
CK'D BY:	CLEBURNE ST PAVING REMOVAL	. AND REPAIR
JC	BETWEEN ALMEDA ST AND HUT	CHINS ST
SCALE:	CUEET 1 OF 2	
1"=20'	SHEET 1 OF 2	
DATE:	APPROVED BY:	
04/12/19		
		SHEET NO:
ĺ		

412

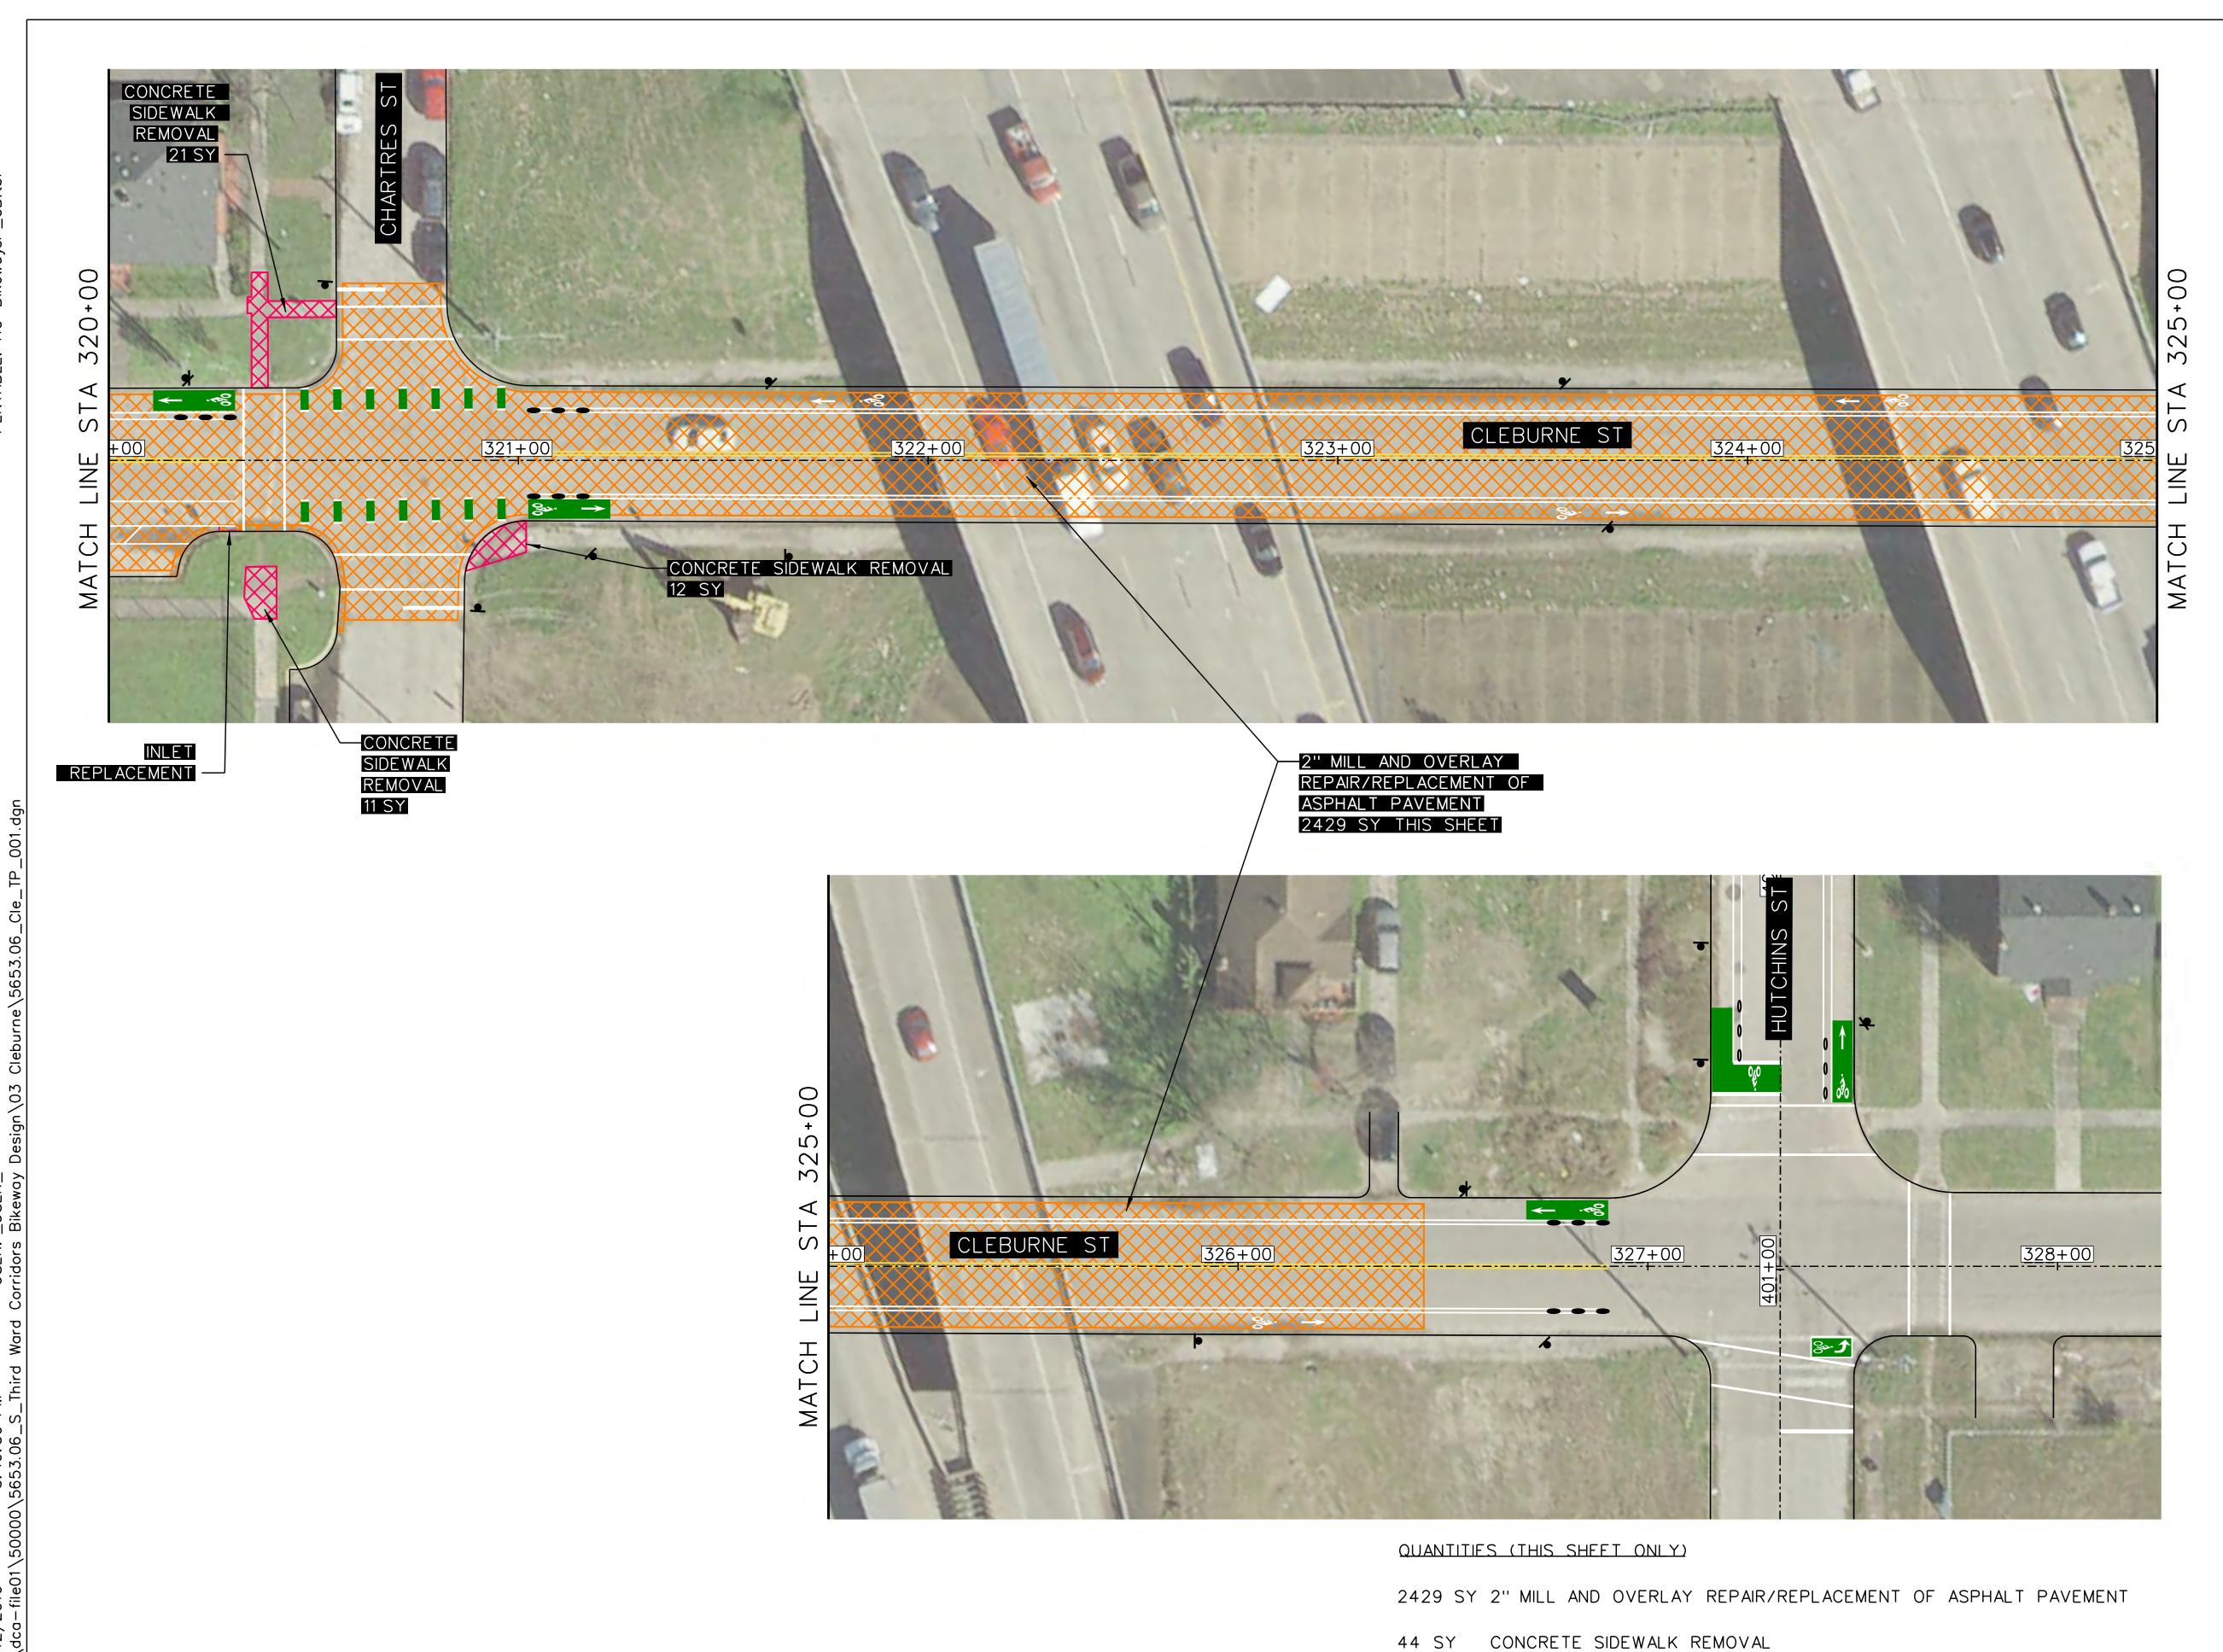

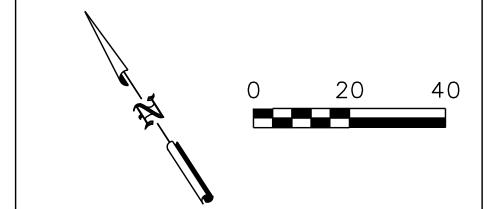

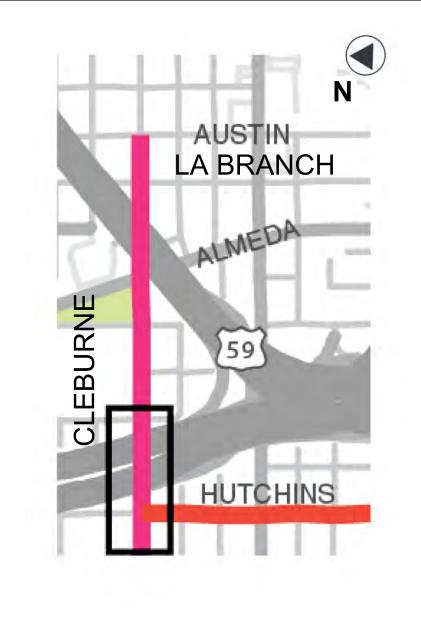


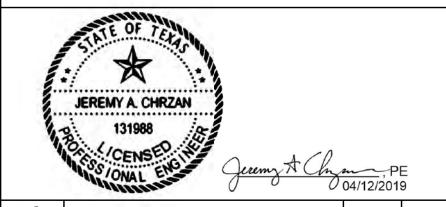

NO.	REVISIONS	DATE	NAME

TOOLE DESIGN

8484 Georgia Avenue, Suite 800, Silver Spring, MD 20910
TEL (301) 927-1900
TBPE Registration No. 14667

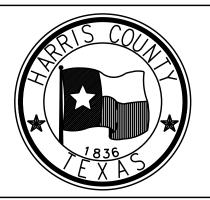

HARRIS COUNTY ENGINEERING DEPARTMENT

PROJECT TITLE:
HUTCHINS/CLEBURNE STREETS ON-STREET BIKEWAY
DRAWN BY: SHEET DESCRIPTION:
CB/FL PAVING SHEETS
CK'D BY: CLEBURNE ST PAVING REMOVAL AND REPAIR

CK'D BY: CLEBURNE ST PAVING REMOVAL AND REP


JC BETWEEN ALMEDA ST AND HUTCHINS ST

SCALE:

1"=20' SHEET 2 OF 2

DATE: APPROVED BY: 04/12/19


SHEET NO: 413

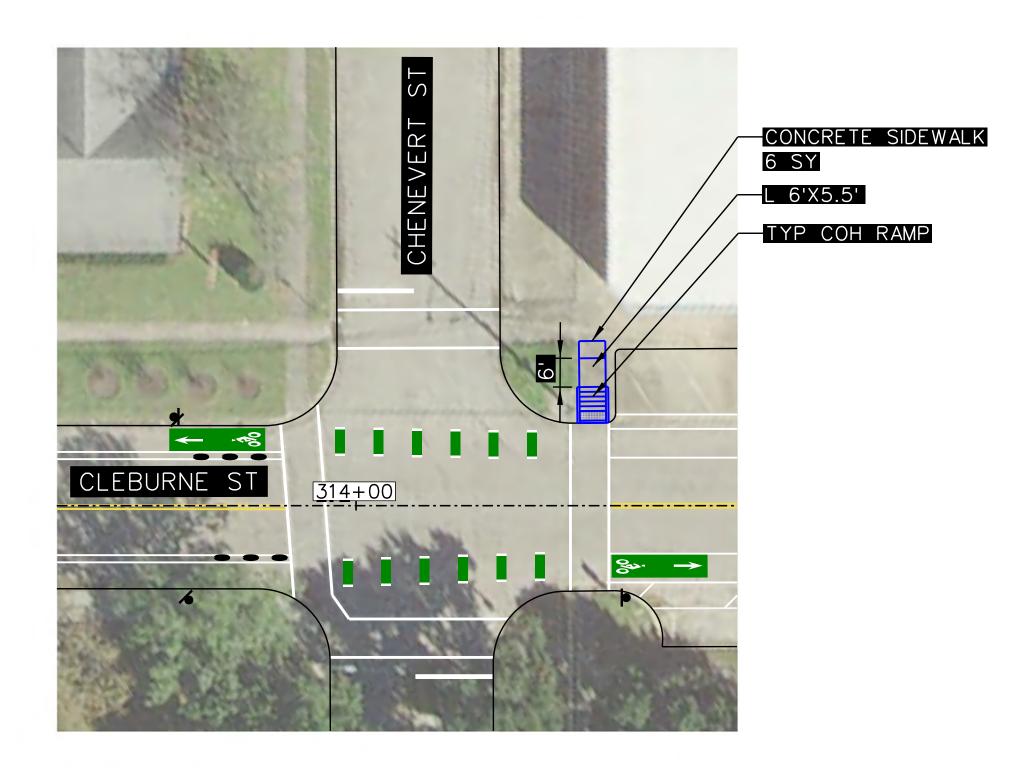




133 SY CONCRETE SIDEWALK


80 LF CONCRETE CURB AND GUTTER

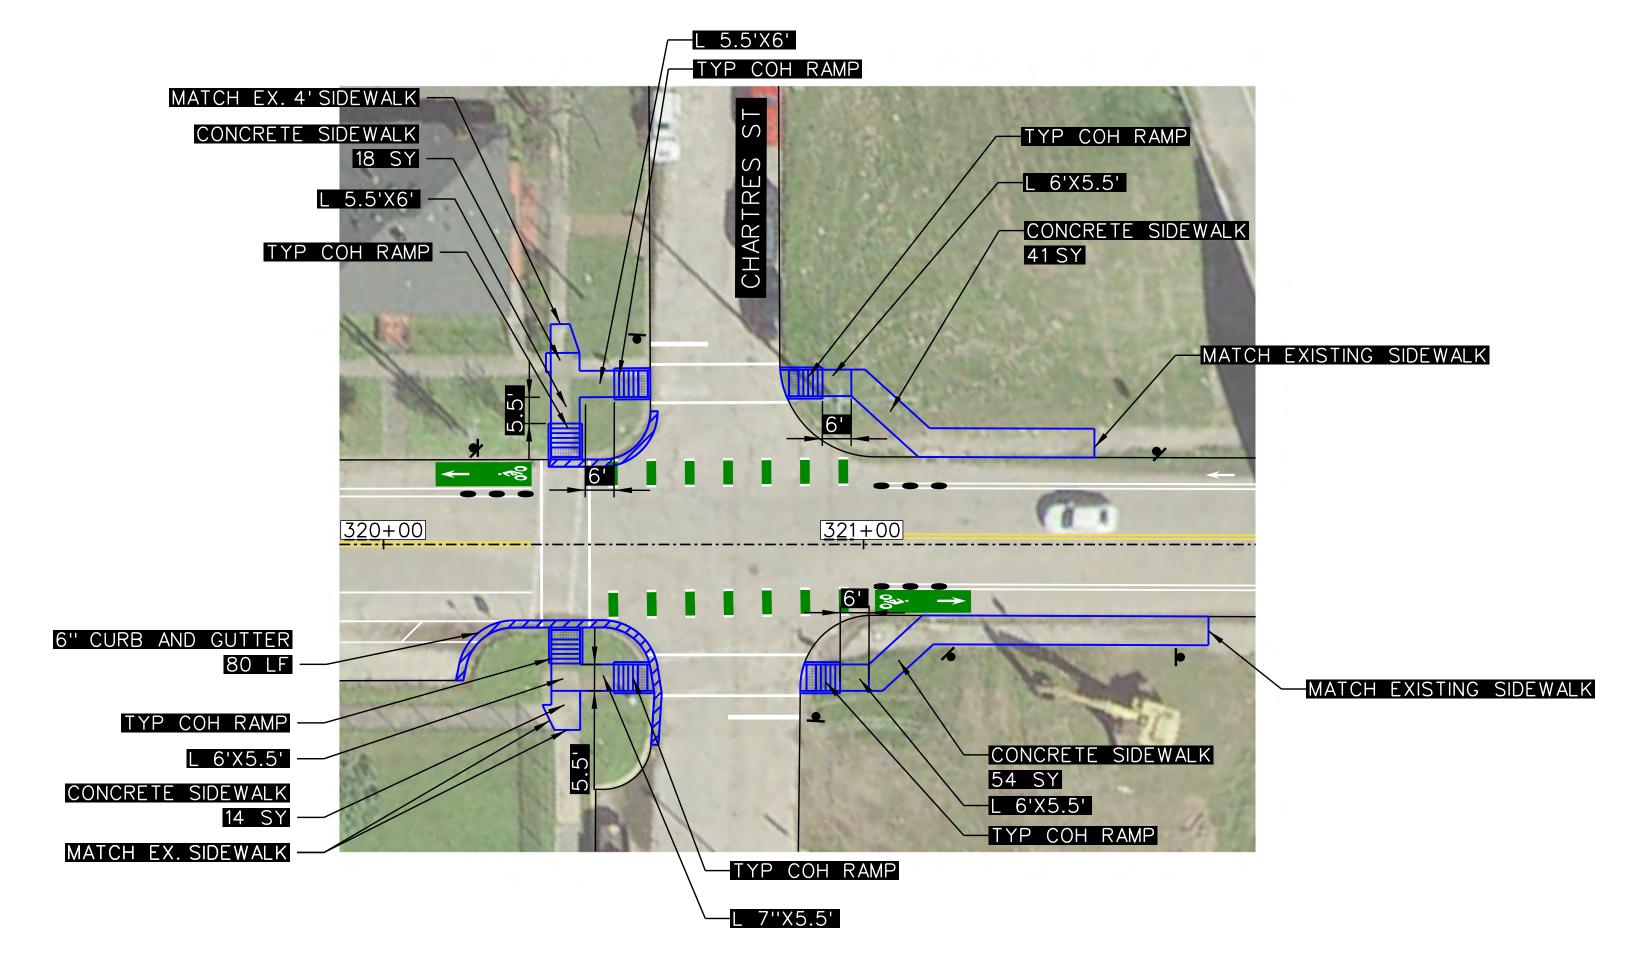


NOTES:

- 1. CURB RAMP LANDING AREAS MARKED "L" 2% MAX SLOPE FOR DRAINAGE
- 2. SEE SHEET 308 FOR SIDEWALK DETAILS.
- 3. SEE SHEET 309 FOR TYP COH RAMP DETAILS.

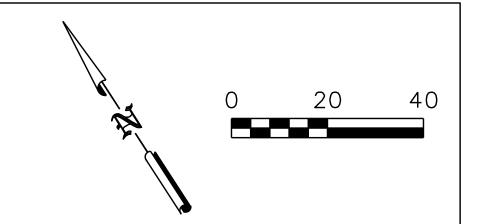

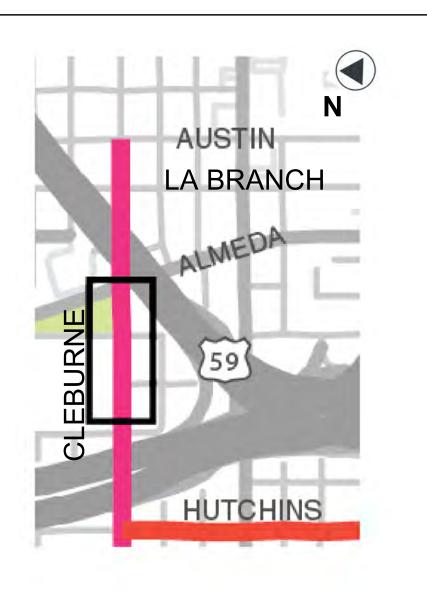

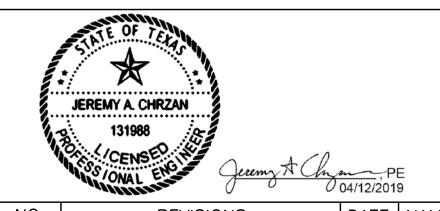

NO.	REVISIONS	DATE	NAME

TOOLE DESIGN

8484 Georgia Avenue, Suite 800, Silver Spring, MD 20910 TEL (301) 927—1900 TBPE Registration No. 14667



HARRIS COUNTY

ENGINEERING DEPARTMENT

PROJECT TITLE: HUTCHINS/CLEBURNE STREETS ON—STREET BIKEWAY DRAWN BY: SHEET DESCRIPTION: CB/FL PAVING SHEETS CK'D BY: CLEBURNE ST PAVING LAYOUT JC AT CHENEVERT ST AND CHARTRES ST SCALE: 1"=20' SHEET 1 OF 1 DATE: APPROVED BY: 04/12/19 SHEET NO: 414						
CB/FL PAVING SHEETS CK'D BY: CLEBURNE ST PAVING LAYOUT JC AT CHENEVERT ST AND CHARTRES ST SCALE: 1"=20' SHEET 1 OF 1 DATE: APPROVED BY: 04/12/19 SHEET NO:		HUTCHINS/	CLEBURNE STREETS ON—STR	EET BIKEWAY		
JC AT CHENEVERT ST AND CHARTRES ST SCALE: 1"=20' SHEET 1 OF 1 DATE: 04/12/19 SHEET NO:		DRAWN BY: CB/FL				
SCALE: 1"=20' DATE: 04/12/19 APPROVED BY: SHEET NO:			CLEBURNE ST PAVING LAYOUT			
1"=20' SHEET 1 OF 1 DATE: APPROVED BY: 04/12/19 SHEET NO:		JC	JC AT CHENEVERT ST AND CHARTRES ST			
04/12/19 SHEET NO:		1"=20'	SHEET 1 OF 1			
SHEET NO:		DATE:	APPROVED BY:			
		04/12/19				